New Building for




Meridian Rd., Winnebago County, Illinois







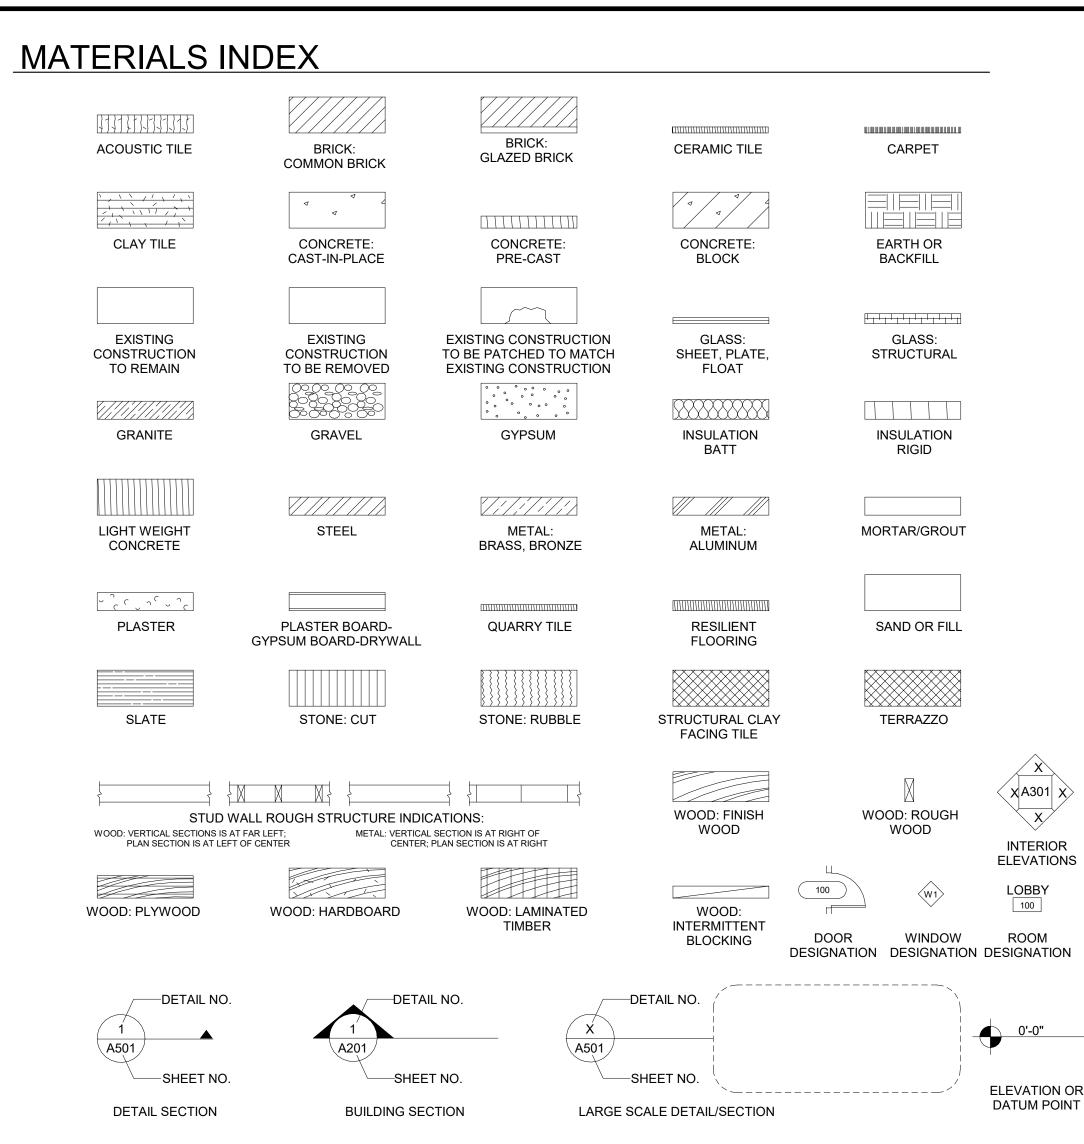

ABBREVIATIONS ACOUSTIC PLASTER **EXTERIOR** PL BD PLASTER BOARD ACT ACOUSTIC TILE **FIGURE** PLYWOOD FIG. PLYWD ACT. ACTUAL FINISH POL. POLISHED FIN. ALUMINUM **FLOOR** PROJ. PROJECT Q.T. ARCH. ARCHITECTURAL FLASH. FLASHING QUARRY TILE A.T. ASPHALT TILE F.O. FINISH OPENING RISER R-FEC AVG AVERAGE **FULL SIZE** RECESSED FIRE EXTINGUISHER SURFACE BRACKET MOUNTED B-FE GAUGE CABINET GALV RUBBER FIRE EXTINGUISHER GALVANIZED REBAR BLOCK GALVANIZED IRON REINFORCING BAR BEARING PLATE REF. BPL **GIWT** GLAZED INT WALL TILE REGRIGERATOR, REFERENCE BR BRICK, BEDROOM GLASS REV REVISION CPT GYP BL RM, RMS ROOM, ROOMS CARPET GYPSUM BLOCK CAT. CATALOG **HOLLOW CORE** R.O. **ROUGH OPENING** HC HDWE C BL CONCRETE BLOCK HARDWARE R.T. RUBBER TILE CEM CEMENT **HOLLOW METAL** SUPPLY CER T CERAMIC TILE HORIZ. HORIZONTAL S & V STAIN & VARNISH CFM CUBIC FEET PER MINUTE HEIGHT SOLID CORE СІ SCFT STRUCT CLAY FACING TILE CAST IRON HOT WATER CL CLG CENTER LINE INSIDE DIMENSION SCHED SCHEDULE INSUL SEC CEILING INSULATION SECTION CLO CLOSET INTERIOR SHT SHEET SP CON CONSTRUCTION SPANDREL GLASS KITCHEN CONT. SPECS CONTINUOUS KCP KEENE'S CEMENT PLASTER SPECIFICATIONS COR CORRIDOR LONG, LINE SQ FT SQUARE FEET C PL SR-FEC CEMENT PLASTER LAVATORY SEMI-RECESSED FIRE СТ **EXTINGUISHER CABINET** CORK TILE LINO LINOLEUM C TO C SRWY STAIRWAY CENTER TO CENTER LIVING ROOM LIGHT, LAUNDRY TRAY CW STEEL COLD WATER DET DF MAR STOR STORAGE DETAIL MARBLE DRINKING FOUNTAIN MATL STRUCT STRUCTURAL MATERIAL DIAM. DIAMETER MAX. MAXIMUM SUSP SUSPENDED DIM DIMENSION MC MINERAL CORE THREAD, THICKNESS DN DOWN MCJ MASONRY CONTROL JOINT THRESH THRESHOLD DO MET DITTO METAL TRANSPL TRANSPLANTED DINING ROOM, DOOR MINIMUM TYPICAL DS METAL LATH AND PLASTER UNFIN UNFINISHED DOWNSPOUT ML & P DWG DRAWING UNO **UNLESS NOTED OTHERWISE** M.O. MASONRY OPENING UR ENAMEL, EXHAUST MULL. MULLION URINAL NOT APPLICABLE EΑ EACH N.A. VINYL **EXPANSION JOINT** NATURAL V.A.I. VINYL ASBESTOS TILE E.J. NITC NOT IN THIS CONTRACT VERT. **ELEVATION** VERTICAL **ELEV** ELEVATION NO., # NUMBER VEST. VESTIBULE ENT **ENTRANCE** NOM. NOMINAL V.T. VINYL TILE **EPOXY** F 1/4" RESINOUS EPOXY FLOOR NTS NOT WAX, WIDTH O.C. ON CENTER WC WATER CLOSET **EPOXY PT** WOOD, WORKING DRAWINGS **EPOXY PAINT** O.D. OUTSIDE DIMENSION WD WDW EST. **ESTIMATED** WINDOW PAINT E.W. **EACH WAY** PLASTER, PLATE WI WROUGHT IRON PLAS T **EXIST EXISTING** PLASTIC TILE WATERPROOF

	Architect:
	Blakemore Architects 400 North First Street Rockford, IL 61107 Tel: 815-227-0023 Email:brian@blakemo
R L	
	GENERAL NOTES
	1. Notes on each sheet a
RAL	Dimensions shall not v (minimum) and 'Align' intent in any area, Ger
	3. 'Typical' means the co
ON	Architectural dimensio mechanical, electrical Architects immediately
	5. Drawings are not to be
ROUT	6. All vertical dimensions dimensional thickness
	7. All work must comply due to a variance betw Architects.
FILL	It is the responsibility of fabrications and inform approval before such the such that the such
ZO	9. If a discrepancy shoul General Contractor an used and notify the are
X	10. All vertical dimensions
JGH X X INTERIOR	11. General contractor is t materials for project so installation, Blakemore handling or air freight o contractor.
LOBBY	12. General contractor is i power lines, & plumbir
DOW ROOM NATION DESIGNATION	ALTERNATE BID L
	#A-1: Base Bid: Heavy Tin Alternate: Metal Frai
0'-0"	#A-2: Cost to provide Perfo
	#C-1: Alternate Bid to prov

Tel: 630-538-1996 Tel: 262-236-9372 rian@blakemore-architects.com Web: www.core4engineering.com Web: www.oasllc.net **ERAL NOTES** otes on each sheet apply only to the sheet where they appear, unless specifically noted otherwise. mensions shall not vary more than 1/16th from side to side, front to rear, finish face to finish face 'Min' inimum) and 'Align' dimensions are critical. Should any existing conditions not permit construction of design tent in any area, General Contractor to notify Blakemore Architects immediately. ypical' means the condition indicated is the same or is representative for all similar conditions u.n.o. chitectural dimensions and design intent are indicated on Architectural drawings. If the installation of echanical, electrical and plumbing equipment interferes with compliance to the design intent, notify Blakemore chitects immediately. awings are not to be scaled for new construction. vertical dimensions shown for new construction are from top of finish floor (a.f.f.) General Contractor to verify mensional thickness of all floor finishes. work must comply with laws, ordinances and regulations of the local Building Code. Any revision necessary e to a variance between such laws, and these specifications and drawings shall be submitted to Blakemore s the responsibility of the millwork and glazing contractors to verify all conditions and openings prior to rications and inform General Contractor of any discrepancies immediately. Notify Blakemore Architects for proval before such work is performed. discrepancy should exist between items noted on drawings and items indicated in the specification the neral Contractor and subcontractors shall assume the larger quantity and/or better quality items should be sed and notify the architect immediately. vertical dimensions are to be established from a level plane. eneral contractor is to be aware of all lead times for finish materials at the time of pricing to assure availability of aterials for project schedule. If the General Contractor fails to order materials in sufficient time for orderly stallation, Blakemore Architects will not accept any request for material substitution. Any cost for special ndling or air freight of materials in order to meet required deadlines is the responsibility of the General eneral contractor is responsible for coordinating with Plumber & Electrician proper location of receptacles, ower lines, & plumbing lines as to not interfere with fixtures as shown on Architectural Drawings. ERNATE BID LIST: Base Bid: Heavy Timber Wood Canopy at Main Entrance Alternate: Metal Framed Canopy at Main Entrance - See Sheet A201-A & A506 Cost to provide Performance Bond by the General Contractor. Alternate Bid to provide concrete dumpster pad #C-2: Alternate Bid to provide Heavy Duty Asphalt at rear storage yard. ALLOWANCE LIST (TO BE HELD BY THE GENERAL CONTRACTOR): 1: Testing allowance - \$30,000.00 2: Well Water - Design Build System (electric to be provided by E.C. under base bid) codes. ve the following: ered safety glass with ing, etc., to be Il (thickness as erning authorities.

Structural:

CORE 4 Engineering, Inc.

N70 W5185 Columbia Rd.,

Cedarburg, WI 53012

1.	All partitions to be constructed of noncombustible materials in accordance with local building codes.
2.	Flame spread ratings: All materials used for interior wall, ceiling & floor finish w/trim shall have the following: a. Stairways, lobbies and public corridors, Class 26-75 b. Interior offices and spaces - Class 76-200
3.	All glazing where indicated shall conform to the local Building code. All glazing is to be tempered safety glass wi temper marks located so as to be concealed when glazing is set in place, u.n.o.
4.	All wood blocking shall be treated to retard fire as required by the local Building Code.
5.	All wood blocking required for both base & upper cabinets, custom millwork, cabinetry, shelving, etc., to be installed by General Contractor.
6.	Deflections for all partitions shall be limited to 1/240th of the span maximum.
7.	All exit doors to be keyless in the direction of egress.
8.	All drywall partitions receiving a fire resistive rating shall be constructed with fire code drywall (thickness as shown) per manufacturer's recommendations and requirements of applicable codes and governing authorities.
9.	Penetrations - coordinate with mechanical contractor and engineers for all openings required.
10.	Use galvanized corner beads and edge trims in all exposed work.
11.	Unless otherwise noted, all drywall partitions to be metal stud with layer of 5/8" drywall both sides, with acoustic batt insulation between.
12.	Movement control: a. Provide for vertical movement at the head of all partitions as indicated in the Notes or the Drawings. In drywall construction connect head runner channel to underside of structure, cut studs to allow for vertical movement. Do not fasten to runner channel, fasten drywall to studs only. b. Horizontal control joints at 12'-0" over ceiling in the vertical direction. c. Vertical control joints for any wall length at 30'-0" in the horizontal direction where indicated or as required Verify location of all control joints with Blakemore Architects.
13.	Sound Control: a. Completely seal with acoustical sealant heads, bases, ends, plus all penetrations including but not limited to mechanical Electrical and plumbing work, etc. b. Provide sound blankets as shown in architectural details.
14	All doors and frames to be installed plumb and true and shall operate freely without binding. Frames shall be

15. Door undercuts (if required by HVAC drawings) shall be kept to a minimum dimension and shall be uniform

17. Provide control joints at jambs of all windows (From top of window to top of window to top of drywall above.

1. All paint to be applied in accordance with manufacturer's specifications for particular surface.

16. Provide fire extinguishers, smoke detectors and all other life safety devices as required by code. All locations to

throughout the project.

FINISH NOTES

be approved by Blakemore Architects & local fire inspector.

2. All interior gypsum partition walls to receive a level 4 finish.

SHEET INC	DEX	Current drawing date:
1) GENERAL:		
COVER NDEX	COVER SHEET INDEX SHEET	10-27-25 10-27-25
CODE 1	CODE SYNOPSIS	10-27-25
CODE 2	ADA STANDARDS	10-27-25
2) CIVIL:		
C01 C02	GENERAL NOTES SWPP SITE MAP	10-27-25 10-27-25
C03	SWPP DETAILS	10-27-25
C04	EXISTING CONDITIONS & REMOVALS PLAN	10-27-25
C05	LAYOUT PLAN	10-27-25
C06 C07	GRADING PLAN GRADING PLAN DETAILS	10-27-25 10-27-25
C08	DRAINAGE PLAN	10-27-25
C09	UTILITY PLAN	10-27-25
C10 _01	DETAILS LANDSCAPE PLAN	10-27-25 10-27-25
3) ARCHITECT	URAL:	
A100	FOUNDATION PLAN	10-27-25
A101	FLOOR PLAN	10-27-25
A101-A A102	FLOOR PLAN - WALL TYPES & FINISHES MEZZANINE FLOOR PLANS	10-27-25 10-27-25
A103	ROOF PLAN	10-27-25
A104	CANOPY FLOOR PLANS	10-27-25
A105 A106	ROOM SCHEDULES DOOR & FRAME SCHEDULES	10-27-25 10-27-25
4106 4107	DOOR & FRAME SCHEDULES DOOR & FRAME TYPES	10-27-25 10-27-25
A201	BUILDING ELEVATIONS	10-27-25
A201-A	BUILDING ELEVATIONS - CANOPY ALTERNATE #1	10-27-25
A202 A203	BUILDING ELEVATIONS BUILDING SECTIONS	10-27-25 10-27-25
4203 4301	ENLARGED FLOOR PLANS	10-27-25
A302	INTERIOR ELEVATIONS	10-27-25
A401	REFLECTED CEILING PLAN	10-27-25 10-27-25
A501 A502	WALL SECTIONS WALL SECTIONS	10-27-25 10-27-25
A503	WALL SECTIONS	10-27-25
4504	CANOPY SECTIONS	10-27-25
4505 4506	CANOPY SECTIONS & DETAILS CANOPY SECTIONS - ALTERNATE #1	10-27-25 10-27-25
4601	WALL SECTION DETAILS	10-27-25
\602	METAL STAIRS DETAILS	10-27-25
I) STRUCTURA 3000	AL: 3D VIEWS AND TITLE SHEET	10-27-25
S001	STRUCTURAL GENERAL NOTES	10-27-25
3002	STRUCTURAL GENERAL NOTES & SCHEDULES	10-27-25
S100 S100-1	OVERALL FOUNDATION PLAN FOUNDATION PLAN	10-27-25 10-27-25
S100-2	FOUNDATION PLAN	10-27-25
S101	OVERALL MEZZANINE FRAMING PLAN	10-27-25
S102 S103	MEZZANINE FRAMING PLAN ENLARGED FLOOR PLANS	10-27-25 10-27-25
S104	ALTERNATE BID CANOPY	10-27-25
S300	CONCRETE SECTIONS & DETAILS	10-27-25
S301 S302	CONCRETE SECTIONS & DETAILS CONCRETE SECTIONS & DETAILS	10-27-25 10-27-25
S340	PRECAST SECTIONS & DETAILS	10-27-25
5400 5600	MASONRY SECTIONS & DETAILS WOOD SECTIONS, DETAILS & ELEVATIONS	10-27-25 10-27-25
5) MECHANICA	,	.0 27 20
Й 1.10	FLOOR PLAN VENTILATION	10-27-25
M1.20 M200	FLOOR PLAN PIPING SCHEDULES MECHANICAL	10-27-25 10-27-25
W200 W210	SCHEDULES MECHANICAL SCHEDULES MECHANICAL	10-27-25 10-27-25
M300	SYSTEMS MECHANICAL	10-27-25
M400	DETAILS - MECHANICAL	10-27-25
M410 M420	DETAILS - MECHANICAL DETAILS - MECHANICAL	10-27-25 10-27-25
M500	SYMBOLS - MECHANICAL	10-27-25
S) ELECTRICA		40.07.05
≣110 ≣210	FLOOR PLAN - ELECTRICAL LIGHTING FLOOR PLAN - POWER ELECTRICAL	10-27-25 10-27-25
E300	SCHEDULES - ELECTRICAL	10-27-25
E401	DETAILS & DIAGRAMS - ELECTRICAL	10-27-25
≣500 ≣600	SYMBOLS LIST - ELECTRICAL GENERAL NOTES - ELECTRICAL	10-27-25 10-27-25
7) PLUMBING:		
P1.10	UNDER FLOOR PLAN - PLUMBING	10-27-25
P1.11	FLOOR PLAN - SA & VENT - PLUMBING	10-27-25
P1.12 P3.01	FLOOR PLAN - WATER - PLUMBING ABBREVIATIONS, NOTES & SYMBOLS - PLUMBING	10-27-25 10-27-25
23.01 23.02	SCHEDULES - PLUMBING	10-27-25
P4.01	DETAILS - PLUMBING	10-27-25
P4.02	DETAILS - PLUMBING	10-27-25

Indicates drawing sheets that have been prepared by consulting engineers contracted by Blakemore Architects. Architectural seals on this sheet do not cover these drawings. See individual drawings for

seals of consulting engineers.

Civil:

ARC Design Resources, Inc.

5291 Zenith Parkway

Loves Park, IL 61111

Tel: 815-484-4300

Web: www.arcdesign.com

MEP:

O'Higgins & Arnold Sustainability, LLC

769 Heartland Drive, Unit A

Sugar Grove, IL 60554



400 N. First Street Rockford, IL 61107 815-227-0023 E: brian@blakemore-architects.com blakemore-architects.com



New Building

Forest Preserves of Winnebago County

Meridian Rd., Winnebago County, Illinois

THE CONTRACTOR SHALL DETERMINE EXACT DIMENSIONS AND CONDITIONS AT THE SITE PRIOR TO SUBMITTING A BID. THE CONTRACTOR SHALL COORDINATE ALL DRAWINGS WITH ACTUAL FIELD CONDITIONS PRIOR TO PROCEEDING WITH THE WORK AND NOTIFY THE ARCHITECT OF ANY DISCREPANCIES. THIS DRAWING IS THE PROPERTY OF BLAKEMORE ARCHITECTS AND MAY NOT BE REPRODUCED WITHOUT THE PRIOR WRITTEN PERMISSION OF THE ARCHITECT.

NO.	DATE	DESCRIPTION
1)	05-08-2025	Initial Layout
2)	08-07-2025	Schematic Design
3)	08-27-2025	Design Development
4)	10-17-2025	Final Owner Review Set
5)	10-27-2025	Issued for Bids / Permit
	C COPYRIG	HT Blakemore Architects 2025

BA Project No.

Scale

12" = 1'-0"

2025-09

Sheet Title

INDEX SHEET

Ref. North

Sheet No.

INDEX

EARTHWORK NOTES

- Boring samples have been taken at the proposed construction site and a boring report has been supplied with the construction documents. Unsuitable Materials:
- Assume that if unsuitable materials are encountered and the replacement of these materials is required, this situation shall be handled as follows: A. The site contractor shall notify the general contractor immediately. The project superintendent, prior to the undercutting being completed, shall approve any
- additional undercutting. The quantities shall be verified by the engineer as the additional removal is being completed. B. If approved by the engineer, these materials shall be removed and replaced with compacted granular materials and compacted in accordance to required standards. The cost of this work shall be an extra to the contract, with the cost being adjusted by change order. If the site contractor is furnishing any off site materials, a representative sample of such materials shall be furnished to the general contractor's approved
- testing agency to determine a proctor. These materials shall be placed as homogeneously as possible to facilitate accurate compaction and moisture testing.
- A. "Organic material" is defined as material having an organic content in excess of 8% or as determined by the project owner's engineer.
- B. Topsoil shall be friable and loamy (loam, sandy loam, silt loam, sandy clay loam, or clay loam).
- B.1. Sand content shall generally be less than 70% by weight. B.2. Clay content shall generally be less than 35% by weight.
- B.3. Organic soils, such as peat or muck, shall not be used as topsoil Topsoil shall be relatively free from large roots, weeds, brush, or stones larger than 25 mm (1 inch). At least 90% shall pass the 2.00 mm (no. 10) sieve. Topsoil ph shall be between 5.0 and 8.0. Topsoil organic content shall not be less than 1.5% by weight. Topsoil shall contain no substance that is potentially
- toxic to plant growth. "Existing on-site material within moisture content limits" is defined as material of such a quality that the specified compaction can be met without any
- idditional work other than "densifying" with a roller. Scarification and drying of this material will not need to be done prior to compaction
- "Existing on-site material NOT within moisture content limits" is defined as material with a high moisture content that can not meet specified compaction requirements without scarification and drying, chemical stabilization, etc. of this material prior to compaction.
- G. "Unsuitable material" is defined as any materials that:

engineer's recommendations for "engineered fill"

- G.1. Cannot be utilized as "topsoil" (organic) for landscape areas. G.2. Cannot be utilized as "engineered fill" regardless of moisture content and / or does not structurally meet the standards of the project owner's
- G.3. Can be defined as natural materials or materials from "demolition" and / or excavated areas (i.e., materials that would not be suitable for "engineered
- "Off-site material" is defined as any materials that are brought from any area not indicated on this plan set.
- "Trench backfill" shall be defined as any materials used for the purposes of backfilling any trench and / or any excavation requiring backfilling. Refer to 'Standards for fill areas" to determine acceptable materials and procedures.
- The term "stripping" or "strip" as used herein shall be defined as the removal of all "organic materials" from a given area. The term "organic materials" is defined as material having an organic content over 8% based on ASTM D2974, or as defined by the owner's engineer.
- Standards for cut areas: A. A "cut area" is defined as any area where "engineered fill" is not required to bring the site to design subgrade elevation. Instead, excavation or "cutting" is
- required to achieve design subgrade elevation ("engineered fill" being defined as any material being "offsite material"). B. In "cut areas" the site contractor shall perform one of the following procedures at the discretion and in the presence of a representative of the owner's
- engineer and the project architect: B.1. For exposed building or parking lot subgrades consisting primarily of granular soils, the exposed subgrade should be compacted / densified by at least one (1) pass of a smooth-drummed vibratory roller having a minimum gross weight of 10 tons.
- B.2. For exposed building or parking lot subgrades consisting primarily of cohesive soils, the exposed subgrades should be proof-rolled with a fully-loaded six-wheel truck having a minimum gross weight of 25 tons. The maximum allowable deflection under the specified equipment shall be 1/2". C. In the event that adequate stability of granular soils subgrades cannot be achieved by the procedures as outlined in item 1 above, or that deflections greater than 1/2" are observed during the "proof rolling" of cohesive soils subgrades (as outlined in item 2 above) additional corrective measures will be required. These measures could include, but not necessarily be limited to, scarification, moisture conditioning, re-compaction, undercutting and replacement with
- engineered fill or crushed stone (with or without geotextiles), or chemical stabilization. D. It shall be considered as part of the scope of these documents (and thus part of this contractor's responsibility) to perform scarification and drying of the subgrade per Illinois Department of Transportation (IDOT) standards (scarify a 16" depth for 3 days). If this does not work then additional drying measures
- shall be an extra to the contract Any proposed corrective measures by the contractor should be reviewed by the owner's engineer and the project architect. In the event that in the opinion of the owner's engineer and / or the project architect proof rolling is not a good indicator of the subgrade stability, an alternative method shall be specified by the owner's engineer and / or the project architect.
- Standards for fill areas: A. A "fill" area is defined as any area where material is required to adjust the existing elevation to a proposed subgrade elevation (these areas require installation of "engineered fill" to achieve design subgrade elevation). "Engineered fill" material can be defined as either "granular soil" or "soil" that is either from the construction site or is "offsite material". Materials having their origin from the construction site is referred to as "borrow". The composition and the compaction
- standards of the engineered fill for this project will be specified by owner's engineer and the project architect. B. In "fill" areas, "borrow" materials are allowed to be utilized as engineered fill such that the site contractor compacts the "borrow" areas to the specified
- compaction. 6. Compaction standards (for engineered fill and back filled areas)
 - A. Prior to placement of fill in areas below the design grade, the exposed subgrade should be observed by a representative of the owner's engineer to evaluate that adequate stripping has been performed. Additionally, the proof rolling or compacting procedures outlined in the "standards for cut areas" section of these notes should be performed. It is typical practice to proof roll (and densify if necessary) exposed subgrades prior to filling. If soft or unstable subgrades are observed, these areas should be stabilized or undercut. Minimum compaction standards are based upon a percentage of the fill or backfill material's maximum standard proctor dry density (ASTM D698). All engineered subgrades should meet the following minimum compaction:
 - A.1. Areas under foundations bases: A.1.A. 95% standard proctor for all fill placed below foundation base elevation in the building area.
 - A.2. Areas under floor slabs and above foundations/footing bases:
 - A.2.A. 95% standard proctor for all fill placed more than 12 inches below final grade for support of floor slabs and above foundation base elevation in A.2.B. 95% standard proctor for fill placed in the upper 12 inches of design subgrade below slabs. The granular fill under the floor slab should be
 - compacted to a minimum of 95% standard proctor. A.3. Areas under pavement sections: A.3.A. 95% standard proctor for all fill placed more than 12 inches below passenger car pavement sections and 95% standard proctor for the top 12
 - A.4. Landscaped areas
 - A.4.A. 90% standard proctor for all fill placed in landscape areas. These areas should be brought to grade with "topsoil" to a depth of 6 inches in areas to be seeded, 6 inches in areas to be sodded, and 6 inches for all interior curbed landscape islands.
 - A.5. Base course portion of pavement sections: A.5.A. 95% standard proctor for all base course materials that are part of a "pavement section".
- B. The option of utilizing the modified proctor (ASTM D1557) in lieu of the specified standard proctor (ASTM D698) shall be at the discretion of the general contractor, contingent upon written approval by the architect and owner's engineer.
- All backfill and fill materials shall be placed in lifts not greater than 8" in loose depth. Before compacting, moisten or aerate each layer as necessary to provide optimum moisture content. Compact each layer to required percentage of maximum density of the area.
- A. The term "finish grading" as used herein shall be defined as that condition that areas not receiving a finish product such as parking areas, driveways, roadways, sidewalks, etc. Finish graded areas would generally be those areas receiving "landscaping" such as seed, sod, trees, bushes, mulch, etc. B. The site contractor is responsible for "finish grading" all areas within the perimeter of the "construction site". The definition of the "construction site" is the area encompassing all disturbed areas that were disturbed as a result of the construction process relating to the general contract of which this site contract

GENERAL NOTES

- Unless noted otherwise on this page, all earthwork, grading and paving shall be performed in accordance with Standard Specifications for Road and Bridge Construction in Illinois, State of Illinois Department of Transportation, Current Edition, and all revisions and supplements thereto, the specifications contained in this project manual, and the requirements and specifications of the City of Rockford. In case of conflict between the Standard Specifications and the project specific specifications in this manual, the specifications in the manual shall govern.
- The designs represented in these plans are in accordance with established practices of civil engineering for the design functions and uses intended by the owner at this
- time. Neither the engineer nor its personnel can or do warrant these designs or plans as constructed except in the specific cases where the engineer inspects and controls the physical construction on a contemporary basis at the site.
- The contractor, by agreeing to perform the work, agrees to indemnify and hold harmless the owner, the engineer, the County, and all agents and assigns of those parties, from all suits and claims arising out of the performance of said work, and further agrees to defend or otherwise pay all legal fees arising out of the defense of said parties. 4. In accordance with generally accepted construction practices, the contractor shall be solely and completely responsible for conditions of the job site, including safety of all persons and property during performance of the work. This requirement will apply continuously and not be limited to normal working hours. Any construction observation by the engineer of the contractor's performance is not intended to include review of the adequacy of the contractors safety measures, in, or near the construction site. The

contractor is responsible for maintaining adequate signs, barricades, fencing, traffic control devices and measures, and all other measures that are necessary to protect the

- safety of the site at all times. Maintain access for vehicular and pedestrian traffic as required for other construction activities. Use traffic control devices to include temporary striping, flagmen,
- barricades, warning signs, and warning lights shall be in accordance with current MUTCD and IDOT standards. Contractor is responsible to provide secure storage for their own equipment. Designated storage locations will be identified for the contractor. Contractor will have the
- option of installing secure trailer or fenced vard. All phases of the site work for this project shall meet or exceed industry standards and requirements set forth by the the owner's "Description of Work", Winnebago County,
- the State of Illinois, and this plan set. The contractor shall coordinate all permit and inspection requirements with responsible local, state, and federal agencies. The contractor shall include the costs of this coordination and all inspection fees in the bid price.
- 9. All work performed by the contractor shall come with a warranty against defects in workmanship and materials. This warranty period shall run concurrent with the required warranty periods the owner must provide to each local government agency, as a condition of the permit, but shall not be less than 12 months from the date of final
- 10. The contractor will be held solely responsible for and shall take precautions necessary to avoid property damage to adjacent properties during the construction of this
- 11. All structures, inlets, pipes, swales, roads and public egresses must be kept clean and free of dirt and debris at all times. 12. Any field tiles encountered during construction shall be recorded showing size, location, and depth by the contractor, and either reconnected and rerouted or connected to
- the storm sewer system. The owner shall be notified immediately upon encountering any tile. 13. The contractor shall field verify the elevations of the benchmarks prior to commencing work. The contractor shall also field verify the location and elevation of existing pipe inverts, curb or pavement where matching into existing work. The contractor shall field verify horizontal control by referencing property corners to known property lines. Notify the engineer of discrepancies in either vertical or horizontal control prior to proceeding. 14. All elevations are on USGS datum.
- 15. Parking areas designated as A.D.A. and all sidewalk shall be compliant with federal, state, and local A.D.A. requirements. 16. Detectable warning plates per Article 424.09 of the IDOT specifications shall be placed at all locations where sidewalk that is to be replaced intersects public roads and at
- locations indicated in this plan set. 17. The contractor shall verify the location of all utilities in the field prior to construction. This includes sanitary sewer, water main, storm sewer, General Telephone,
- Commonwealth Edison, Northern Illinois Gas and cable television, if any. The J.U.L.I.E. number is 1-800-892-0123. 18. Property corners shall be carefully protected until they have been referenced by a Professional Land Surveyor. 19. The contractor shall keep careful measurements and records of all construction and shall furnish the Engineer, the Owner and the Village with record drawings in a digital
- format compatible with AutoCAD Release 14 upon completion of their work. 20. Any excess dirt or materials shall be removed from the site at no cost to owner. 21. Notify the owner of any existing wells. Obtain permit form the Winnebago County Health Department. Cap and abandon wells in accordance with local, state, and federal
- 22. Finish grade shall in all areas not specifically reserved for storm water management shall drain freely. No ponding shall occur. Tolerances to be observed will be measured
- to the nearest 0.04 of a foot for paved surfaces and 0.10 of a foot for unpaved areas. 23. The contractor shall utilize the owner's engineer, Arc Design Resources for construction layout services and shall contact Arc Design directly to negotiate required scope of
- services and fee. Contractor shall include all necessary construction layout in their bid. Contact Mr. Lee Sprecher at 815-484-4300 x238.

GENERAL PAVING NOTES

- 1. All pavement shall be constructed in accordance with the following:
- Concrete pavement shall be constructed in accordance with the Illinois Department of Transportation (IDOT) "Standard Specifications for Road and Bridge Construction" (Standard Specifications), latest edition, including all updates and standards thereto. Additional details and requirements provided in the contract documents, including this plan set.
- All proposed pavement areas shall be stripped of all topsoil and unsuitable material and excavated or filled to within 0.10 feet of design subgrade. The subgrade of pavement areas shall be free of all unsuitable material and shall be compacted to a minimum 95 per cent of Standard proctor
- The subgrade shall be proof rolled, inspected and approved by the Owner prior to placing the base material. Notify the engineer at least 48 hours prior to finished subgrade preparation.
- The earthwork contractor shall be responsible for removal of spoil material from the underground contractors, preparing the roadway subgrade, proof rolled, placing topsoil to a minimum depth of 4 inches to finished grade in the parkways areas only, grading of drainage swales, and all other tasks as
- The quantities contained in these documents are approximate and estimated, and are presented as a guide to the contractor in determining the scope of work. It is the Contractor's responsibility to determine all quantities and to become familiar with the site and soil conditions.
- The paving Contractor is responsible for the final subgrade preparation, proof rolling, the pavement base, binder, and surface, and all final clean-up and related work associated with the paving operation.
- 8. The proposed pavement shall be of the type and thickness as specified in the engineering drawings, and constructed in strict conformance with the previously referenced IDOT standard specifications.
- Areas of deficient paving, including compaction, smoothness, thickness, and asphalt mixture, shall be delineated, removed, and replaced in compliance with Specifications requirements unless corrected otherwise as directed and approved by the owner. 10. Field quality control tests specified herein will be conducted by the owner's Independent Testing Laboratory (ITL) at no cost to the contractor. Any
- testing and inspection resulting from the requirements of necessary permits by the State of Illinois shall be at the contractor's expense. The contractor shall perform additional testing as considered necessary by the contractor for assurance of quality control. Retesting required as a result of failed initial tests shall be at the contractor's expense.
- A. Field testing, frequency, and methods may vary as determined by and between the owner and the ITL.
- Testing shall be performed on finished surface of each asphalt concrete course for smoothness, using 10'-0" straightedge applied parallel with, and at right angles to centerline of paved area. The following tolerances in 10 ft shall not be exceeded: Base Course Surface: 1/4-inch,
- Wearing Course Surface: 1/8-inch. C. No ponding shall occur on paved surfaces.



STORM SEWER NOTES

- 1. Storm sewer shall be constructed in accordance with the following: A. "Standard Specifications for Water and Sewer Main Construction in Illinois" (Standard Specifications), Seventh Edition dated 2014 (and all revisions and supplements thereto)
- Standards and requirements of Rockford.
- Additional details and requirements provided in the contract documents, including this plan set.
- Where criteria of the aforementioned specifications conflict, the more stringent criteria shall be implemented. All storm sewer pipe shall be reinforced concrete pipe unless otherwise specified in this plan set.
- All storm sewer system elements shall conform to the following specifications: A. Storm pipe:
- A.1. Sump pump service connection and storm sewer extension (4" and 6"):
- A.1.a. ADS pipe shall be in accordance with ASTM D2751. SDR 35 PVC pipe shall be in accordance with ASTM D3034. Concrete sewer pipe (10" diameter and smaller) shall be Class III (minimum) in accordance with ASTM C14.
- Reinforced circular concrete pipe (12" diameter and larger) shall be Class III (minimum), wall B, in accordance with ASTM C76. Reinforced concrete arch culvert pipe shall be double-lined reinforced, Class III (minimum) in accordance with ASTM C506. Reinforced concrete elliptical culvert pipe shall be Class HE-III or VE-III (minimum) in accordance with ASTM C507.
- Underdrain pipe (4" and 6") shall be SDR 35 PVC pipe in accordance with ASTM D2729. Galvanized corrugated steel culvert pipe shall be type B, with a minimum wall thickness of 14 gauge per AASHTO M246 (shall only be
- used for culverts). Joints for storm pipe:
- B.1. ADS pipe joints shall be in accordance with ASTM D2235. B.2. PVC pipe joints shall be in accordance with ASTM 3121 (push-on type), except underdrain pipe, which shall have solvent welded
- C.1. 1/4" thick steel in accordance with ASTM A252, grade 2, or ASTM A139, grade B, or approved equal having a minimum yield strength of 35,000 psi.
- Manholes and Catch Basins: Manholes and catch basins shall be precast reinforced concrete in accordance with ASTM C478.
- Manholes and catch basins shall be sized as follows:
- D.2.a. For sewers eighteen inches in diameter or less, manholes shall have a forty-eight inch inside diameter.
- For sewers twenty-one to thirty-six inches in diameter, manholes shall have a sixty inch inside diameter. For sewers greater than thirty-six inches in diameter, manholes shall have a seventy-two inch inside diameter or as specified in D.2.c. this plan set.
- D.3. Adjusting rings: D.3.a. No more than 2 precast concrete adjusting rings shall be allowed.
- Precast concrete adjusting rings shall have a maximum height of 6 inches. D.3.b.
- D.4. Seals: D.4.a. For pipe and frame seals, all pipe connection openings shall be made watertight with hydraulic cement. The hydraulic cement sealing pipe connections shall extend the full thickness of the structure wall. Hydraulic cement shall also be applied within the structure from the cone section, past all adjustment rings, to the frame.
- All bottom sections shall be monolithically precast including bases and invert flowlines. E. Inlets.
- a. Inlets shall be precast reinforced concrete in accordance with ASTM C478 and ASTM C443. b. Inlets shall have a twenty-four inch inside diameter and a maximum depth of four feet.
- c. Adjusting rings: c.1. No more than 2 precast concrete adjusting rings shall be allowed.
- c.a. Precast concrete adjusting rings shall have a maximum height of 6 inches.
- d. Only one pipe connection shall be allowed, and it shall be precast with resilient rubber watertight pipe to manhole sleeves or seals. External flexible watertight sleeves shall also extend from the manhole cone to the manhole frame.
- e. Bottom sections: All bottom sections shall be monolithically precast including bases and invert flowlines. Castings (Unless otherwise noted within the plans):
- F.1. Unless otherwise specified as a "closed lid", manhole frames and covers shall be as listed below. Close lid frame and covers shall be Neenah R-1916-C embossed "STORM SEWER".
- Crushed Granular Bedding shall be crushed gravel or crushed stone course aggregate in accordance with ASTM C33 (Size No. 67). 4. All end sections 24" and greater shall come equipped safety bars per IDOT detail Standard 542411. 5. Inspect pipe for defects and cracks before being lowered into the trench, piece by piece. Remove and replace defective, damaged or unsound
- pipe or pipe that has had its grade disturbed after laying. Protect open ends with a stopper to prevent earth or other material from entering the pipe during construction. Remove dirt, excess water, and other foreign materials from the interior of the pipe during the pipe laying progress. 6. Install pipe in accordance with manufacturer's written recommendations
- 7. Commence installation at the lowest point for each segment of the route. Lay RCP with the groove or bell end up-stream. 8. Lay pipe to the required line and slope gradients with the necessary fittings, bends, manhole, risers and other appurtenances placed at the required location as noted on Drawings.
- 9. All storm sewers under and within two feet of any existing or proposed pavement shall be backfilled with granular backfill material IDOT gradation FA-6 or approved equal (Grade 8 or Grade 9).
- 10. Compact backfill to 98 percent of maximum density in accordance with ASTM D698, (or 95 percent of maximum density, in accordance with ASTM D1557) obtained at optimum moisture as determined by AASHTO T180. 11. Do not backfill trenches until required tests are performed and utility systems comply with and are accepted by applicable governing authorities.
- 12. Backfill trenches to contours and elevations shown on the drawings.

PAVEMENT MARKING NOTES

1. Material description: a fast drying, high hiding marking paint for concrete, brick, and bituminous surface, suitable for painting centerlines and edgelines of highways, City of Rockford crosswalks and stop zones, parking lots, traffic aisles, etc. Do not apply to in temperatures below 50 °F

PLANTING NOTES

sizes shall remain consistent with these plans.

- 1. Landscape Contractor (Contractor) shall make a site visit prior to bidding/construction to inspect the current site conditions and review proposed
- planting plan and related work. Contractor shall report any discrepancies in the field to the Landscape Architect and/or Owner. Contractor shall verify locations of all underground utilities prior to begining construction on his phase of work. Electric, gas, telephone, and cable television can be located by calling J.U.L.I.E. at '811'. For regional locating, contact "Digger's Hotline". Any damage or interruption of services shall be the responsibility of the contractor. Contractor to coordinate all related activities with other trades on the job and shall report any
- unacceptable job conditions to owner's representative prior to commencing work. 3. For details pertaining to Utilities, Easements, Grading, Retaining Walls, Layout, Geometry, Wetland/Flood Plain Delineations, etc., or other trades
- refer to Architectural and Civil Engineering plans and/or owner. 4. Contractor is responsible for application and cost of all necessary building permits and code verifications. Submit copies of all documents to owner and landscape architect 5. Contractor shall grade entire site to correct surface irregularities in preparation for sod/seed. Roto-til, disc, drag, harrow or hand rake sub grade to
- a depth of 4" in all lawn areas and remove construction debris, foreign matter or stones larger than 2". Grading shall provide slopes which are smooth, continuous, free from depressions or ridges. Level, rake and roll as necessary to an even and true condition and obtain positive drainage in all areas. Finish grades shall meet the approval of owner prior to lawn installation. 6. All disturbed areas are to recieve minimum 4" of topsoil and be finished with mulch, straw mulch, seed, sod, etc. or as noted. All excavated areas
- around the building foundation, parking islands, curbed areas and planting bed areas shall recieve a minimum of 12" depth topsoil. All lawn areas to be watered until a healthy stand of grass is established. (see seed/sod notes for acceptance details) Quantity lists are supplied as a convenience; however, the contractor should verify all quantities. The drawings shall take precedence over the lists. Plantings may need to be adjusted in the field to accommodate utilities, easements, drainage ways, downspouts, etc.; however, quantities and
- 9. Size & grading standards of plant material shall conform to the latest addition of ANSI Z60.1 AMERICAN STANDARD OF NURSERY STOCK, by the American Nursery & Landscape Association. Plant material shall be nursery grown and be either balled and burlap or container grown. 10. All plant species specified are subject to availability. Material shortages in the landscape industry may require substitutions. All substitutions must be approved by the Landscape Architect and/or Owner
- 11. Plant symbols illustrated on this plan are a graphic representation of proposed plant material types and are intended to provide for visual clarity. However, the symbols do not necessarily represent actual plant spread at the time of installation. Sizes and/or spread on plant list represent minimum requirements at the time of installation; mature growth may exceed figures listed. 12. Any plant materials with damaged or crooked/disfigured leaders, bark abrasion, sun scald, insect damage, etc. are not acceptable and will be
- rejected by Landscape Architect and/or Owner. Trees with multiple leaders will be rejected unless called for in the plant list as multi-stem or 13. Upon inspection and acceptance of all landscape items by Landscape Architect and/or Owner the contractor shall assume maintenance
- responsibilities for a period of thirty (30) days, for all plant material, to include: watering, cultivating, weeding, pruning, mulching and spraying as necessary to keep plants free of insects and in a healthy, vigorous condition until responsibility is transferred to the owner (see below). 14. All plant material shall be guaranteed for one (1) year after acceptance by landscape architect and/or owner. After the first thirty (30) days, the owner shall assume maintenance responsibilities as described (see above). Contractor shall replace without cost to owner any dead or unacceptable plants, as determined by the landscape architect at the end of one (1) year guarantee period. Contractor shall notify immediately, in writing, any
- concerns related to maintenance practices. 15. All planting beds and tree saucers shall be mulched continuous with minimum 3" depth shredded hardwood mulch, see planting details. All deciduous trees (shade / ornamental) that are not located in in a planting bed shall be mulched with a 3'-0" diameter circle. Evergreen trees shall
- be mulched to outer-most branches at the time of installation. 16. Planting edge delineation at all planting bed lines and tree saucers shall require a minimum 4" depth "vee" shaped cultivated, spaded edge with a vertical face abutting all lawn areas and sloped to inside of plant bed continuous between lawn and mulched areas as indicated on plan. 17. Contractor to seed all lawn areas as indicated on plan. Seeded lawn to be a combination of bluegrass, perennial rye and red fescue with the suggested following analysis by weight: 30% rugby Kentucky bluegrass, 20% park Kentucky bluegrass, 20% creeping red fescue, 20% scaldis

hard fescue, and 10% perennial ryegrass. Seed to be applied at a rate of 4 lbs. per 1,000 s.f.. All seeded lawn areas shall be covered with straw mulch or erosion control netting, consisting of hand or machine application at a rate of 2 ton per acre. Mulch shall be compact enough to reduce

repeatedly until all areas are covered with a satisfactory stand of grass. Minimum acceptance of seeded lawn areas may include scattered bare or

erosion of seed and topsoil but loose enough to allow air to circulate. Install per Method 1, Section 251, of the Standard Specifications for Road 18. Acceptance of grading and seed shall be by landscape architect and/or owner. Contractor shall assume maintenance responsibilities for a minimum of sixty (60) days or until second cutting, whichever is longer. Maintenance shall include watering, weeding, re-seeding (wash-offs), replacement and other operations necessary to keep lawn in a thriving condition. Upon final acceptance, owner shall assume all maintenance responsibilities. After lawn areas have germinated, areas which fail to show a uniform stand of grass for any reason whatsoever shall be re-seeded or replaced

dead spots, none of which are larger than one (1) square foot and when combined do not exceed 2% of total lawn area.



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BLAKEMORE ARCHITECTS

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New Building

Forest Preserves of Winnebago County

Meridian Rd. Winnebago County, Illinois

THE CONTRACTOR SHALL DETERMINE EXACT DIMENSIONS AND CONDITIONS AT THE SITE PRIOR TO SUBMITTING A BID. THE CONTRACTOR SHALL COORDINATE ALL DRAWINGS WITH ACTUAL FIELD CONDITIONS PRIOR TO PROCEEDING WITH THE WORK AND NOTIFY THE ARCHITECT OF ANY DISCREPANCIES. THIS DRAWING IS THE PROPERTY OF BLAKEMORE ARCHITECTS AND MAY NOT BE REPRODUCED WITHOUT THE PRIOR WRITTEN PERMISSION OF THE ARCHITECT

NO	. DATE	DESCRIPTION
1.	05-08-2025	Initial Layou
2.	08-07-2025	Schematic Design
3.	08-27-2025	Design Development
4.	10-17-2025	Final Owner Review Set
5.	10-27-2025	Issued for Bids / Permit

2025-09 BA Project No.


Scale

Sheet Title

Ref. North Sheet No.

C01

GENERAL NOTES

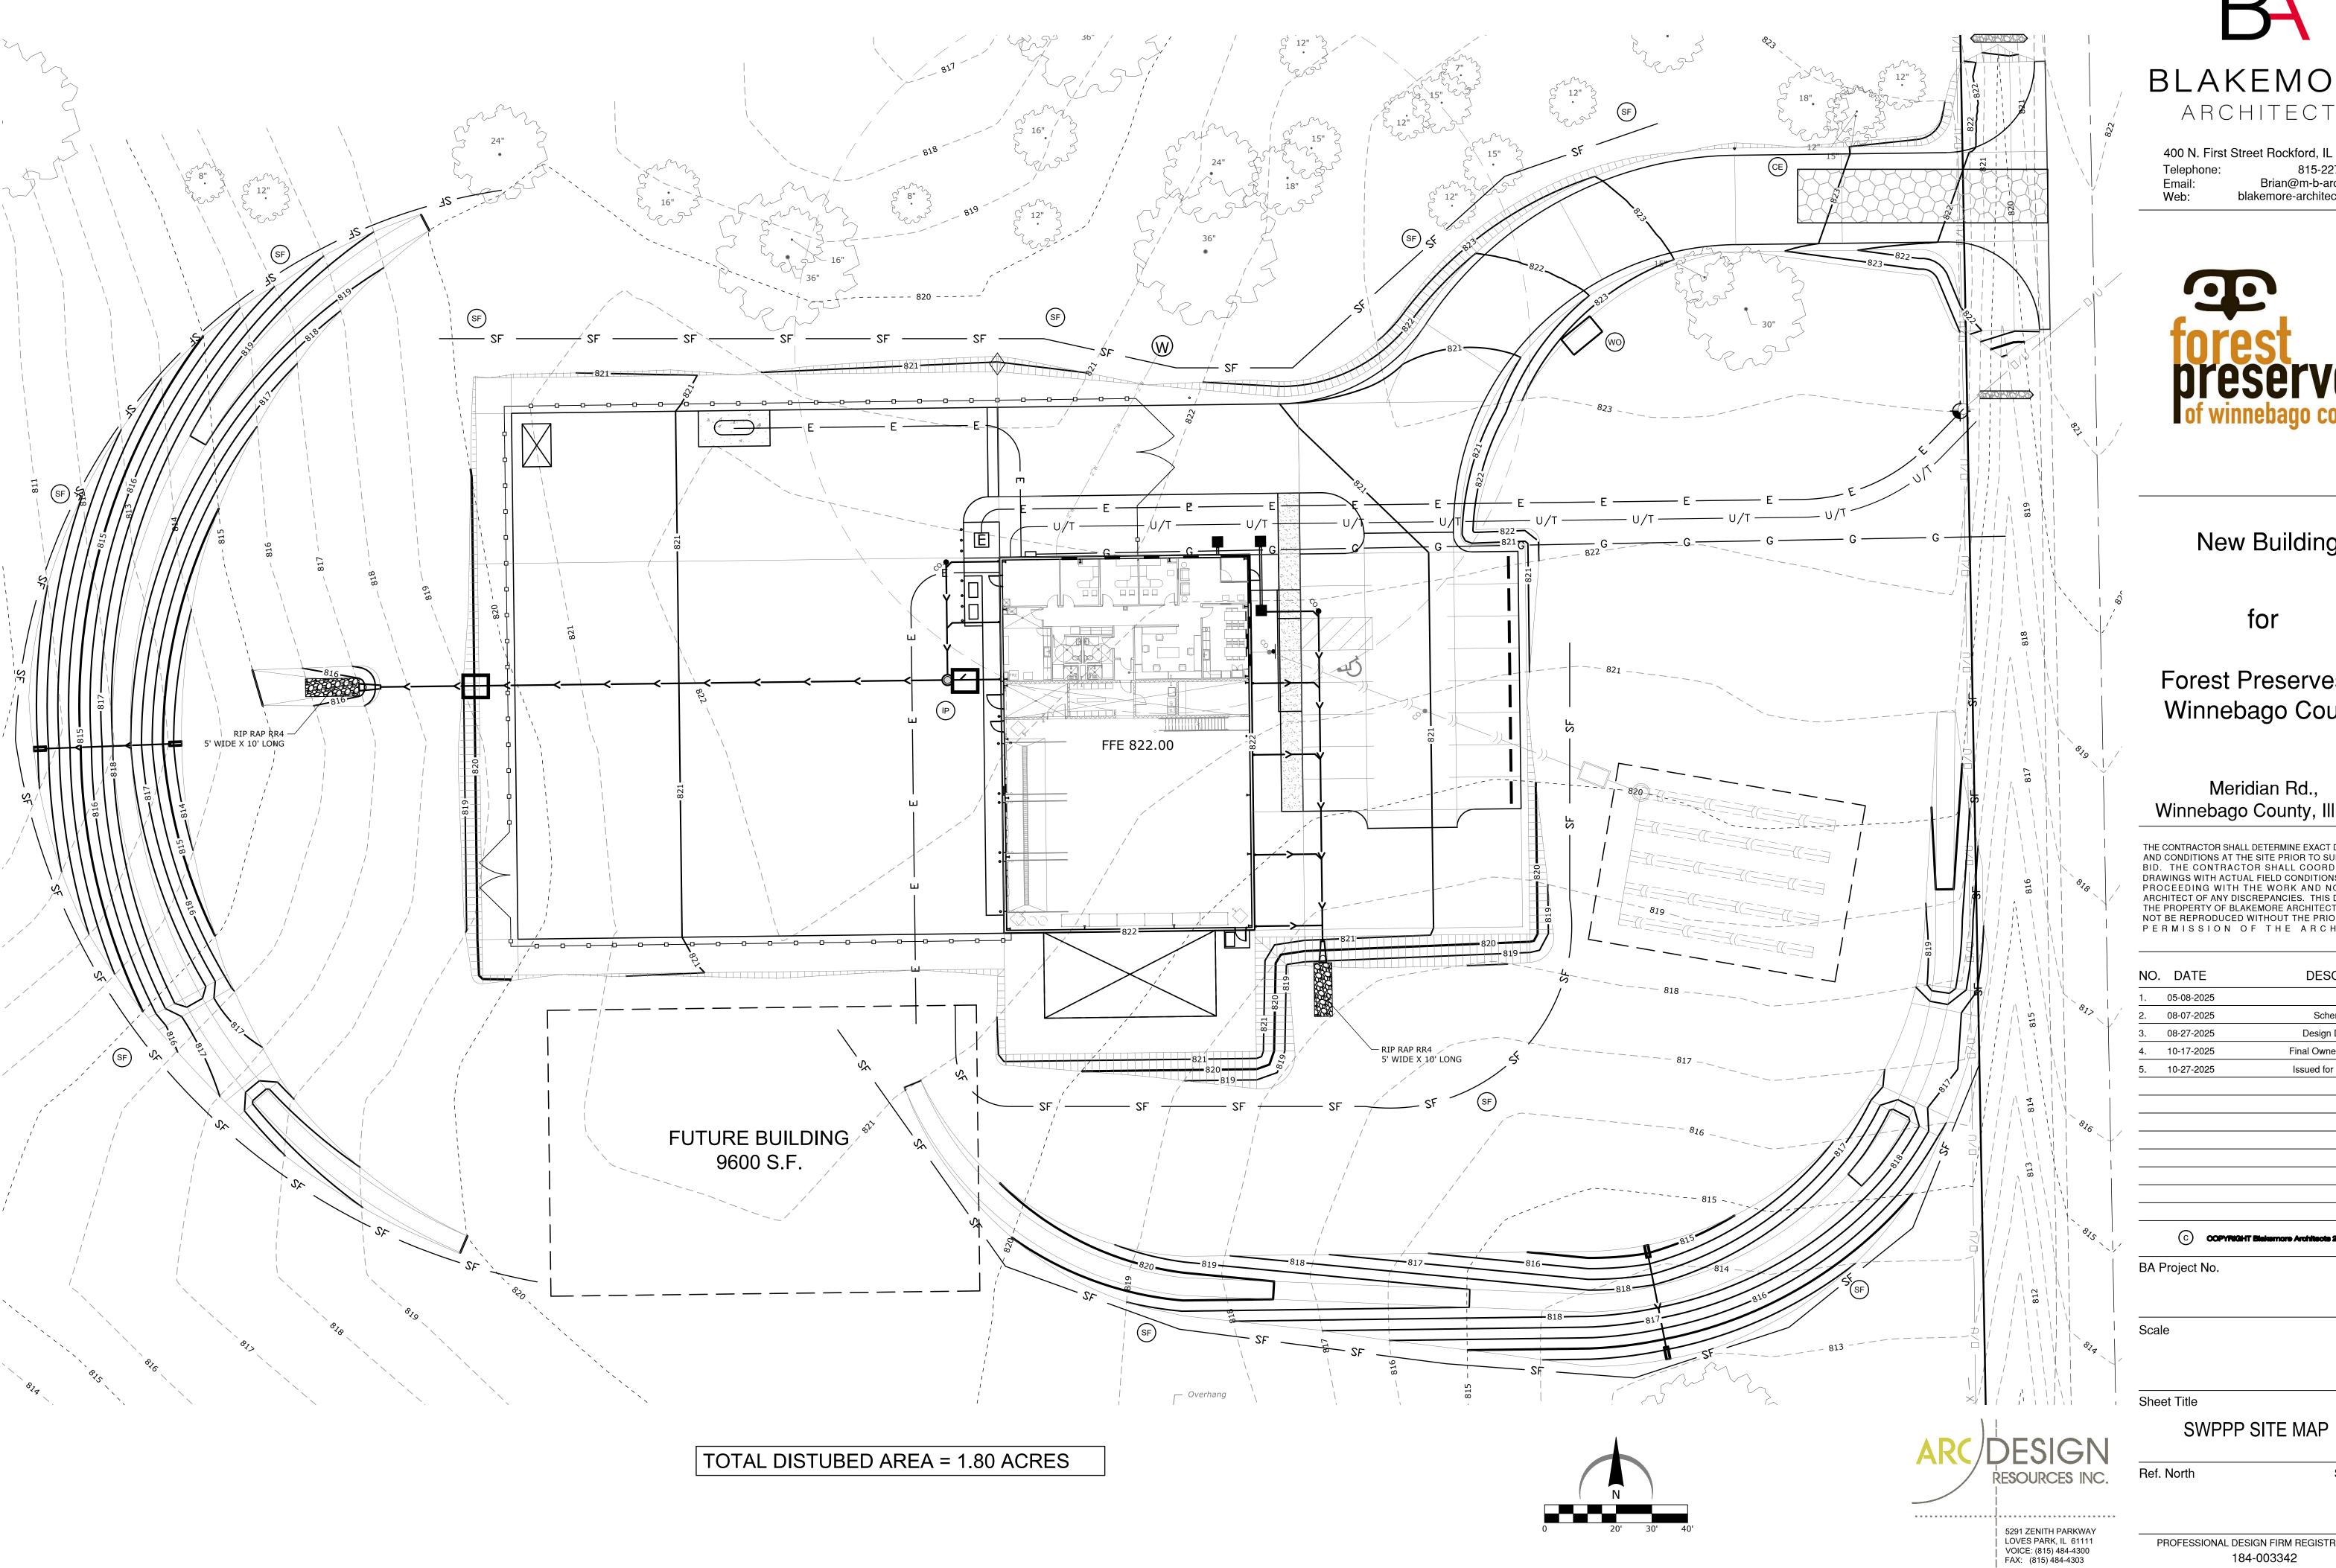



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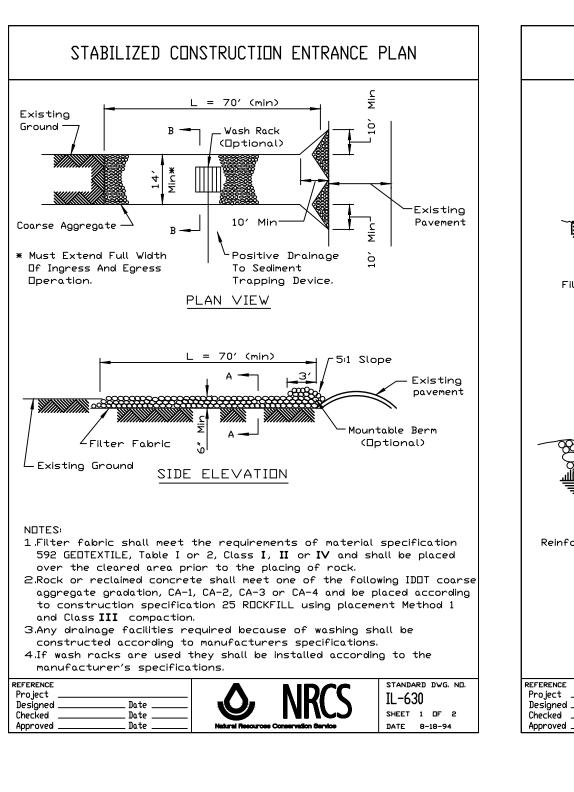
NO	. DATE	DESCRIPTION
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2025-09

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Sheet No. C02

1: 20



EROSION CONTROL REFERENCE NOTES

SEE CONSTRUCTION EXIT DETAIL IL-630 FROM THE ILLINOIS URBAN MANUAL (THIS DETAIL AND OTHERS CAN BE FOUND IN THE SWPPP BINDER FOR THIS SITE). THE CONSTRUCTION

PAVED SURFACE. ALL CONSTRUCTION TRAFFIC MUST UTILIZE CONSTRUCTION EXITS PER DETAIL TO ACCESS THE PUBLIC ROAD. DURING CONSTRUCTION, THE CONSTRUCTION EXITS MAY BE SHIFTED AT THE CONTRACTOR'S DISCRETION TO FACILITATE GRADING OPERATION. EXIT MUST TERMINATE AT EXISTING PAVED SURFACE. THE CONTRACTOR

SHALL BE RESPONSIBLE FOR ENSURING THAT THE RUNOFF FROM THE CONSTRUCTION

THE CONTRACTOR MAY PERMANENTLY REMOVE ANY PORTION OF THE PERIMETER SILT

FENCE AFTER ESTABLISHMENT OF FINAL GRADE AND/OR FINAL STABILIZATION RENDERS

EXIT IS DIRECTED BACK TOWARD THE SITE OR THAT THE RUNOFF IS CLEAR OF

THE RESPECTIVE PORTION OF THE PERIMETER SILT FENCE UPSTREAM OF A DISTURBANCE AND/OR INEFFECTIVE AS A BEST MANAGEMENT PRACTICE. ANY SUCH

REMOVAL SHALL BE NOTED ON THE SWPPP SITE MAPS ALONG WITH UPSTREAM

STRUCTURES WITH CLOSED LIDS WILL NOT REQUIRE PROTECTION FOLLOWING

NO STRUCTURE SHALL BE ALLOWED TO BE PROTECTED WITH ANY MEASURE OTHER

IS IMMINENT. STRUCTURES THAT WILL NOT RECEIVE A CASTING WITHIN 48 HOURS OF

INSTALLATION SHALL RECEIVE INLET PROTECTION. UPON INSTALLATION OF THE GRATE

INSTALLATION OF LID. CONTRACTOR SHALL NOTE TIME STRUCTURE INSTALLATION (AND PROTECTION INSTALLATION, INCLUDING TYPES OF PROTECTION) ARE EMPLOYED.

WHENEVER PIPE INSTALLATION IS HALTED FOR MORE THAN 24 HOURS OR WHEN RAIN IS

IMMINENT, THE OPEN END SHALL BE PROTECTED WITH A TEMPORARY BULK HEAD. A 3/4"

SHEET OF PLYWOOD THAT EXTENDS 6" BEYOND THE OUTSIDE DIAMETER OF THE PIPE

OCP SHALL BE PLACED TO PROTECT THE UPSTREAM END OF THE PERMANENT OUTFALL

REPLACED WITH THE PERMANENT RIPRAP PAD SPECIFIED ON THE SITE DRAINAGE PLAN.

SHORT TERM EROSION CONTROL FABRIC NAG SC150 SHALL BE APPLIED TO ALL SLOPES

SHALL BE PLACED AGAINST THE EXPOSED PIPE END. GRAVEL SHALL BE PLACED

POSSIBLE SEAL. THE TRENCH SHALL BE DEWATERED PRIOR TO REMOVING THE

ELEVATION, FOLLOWING BASIN SIDE SLOPE STABILIZATION, THE OCP SHALL BE

1.05) 4:1 OR STEEPER THAN 4:1 PRIOR TO PERMANENT SEEDING. FOLLOW MANUFACTURER


(1.04) PIPE PRIOR TO PIPE INSTALLATION. SEE PLAN FOR FINAL LOCATION AND TOP OF OCP


AGAINST THE PLYWOOD IN SUFFICIENT QUANTITY SO AS TO ENSURE THE TIGHTEST


THAN THOSE DETAILED IN THIS SWPPP SITE MAP FOR MORE THAN 48 HOURS OR IF RAIN


STABILIZATION AND GRADING CONDITIONS.

EXIT SHALL BE A MINIMUM OF 24' IN WIDTH AND 50' FEET IN LENGTH FROM EXISTING

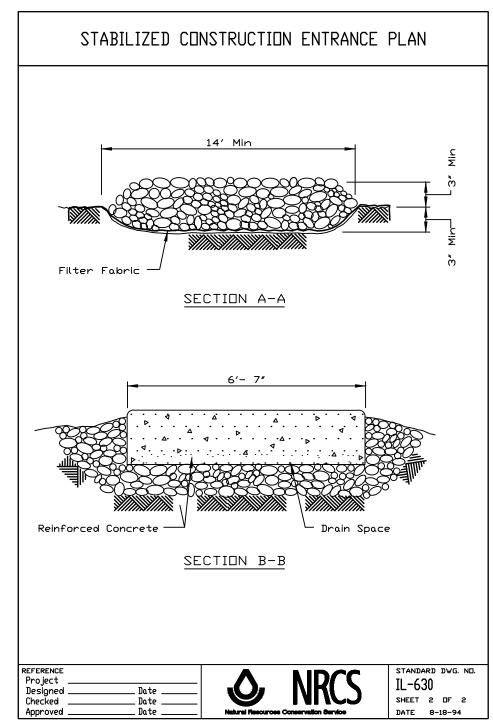

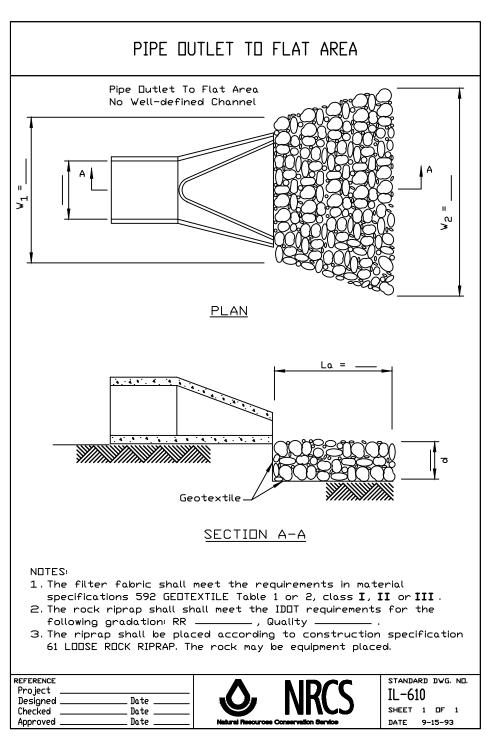

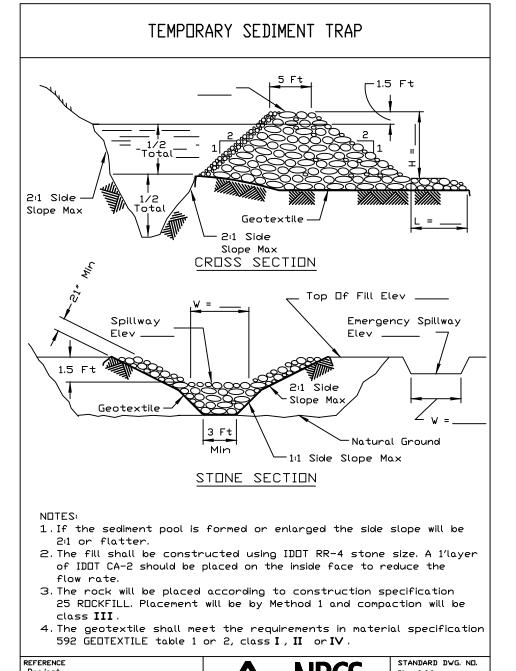

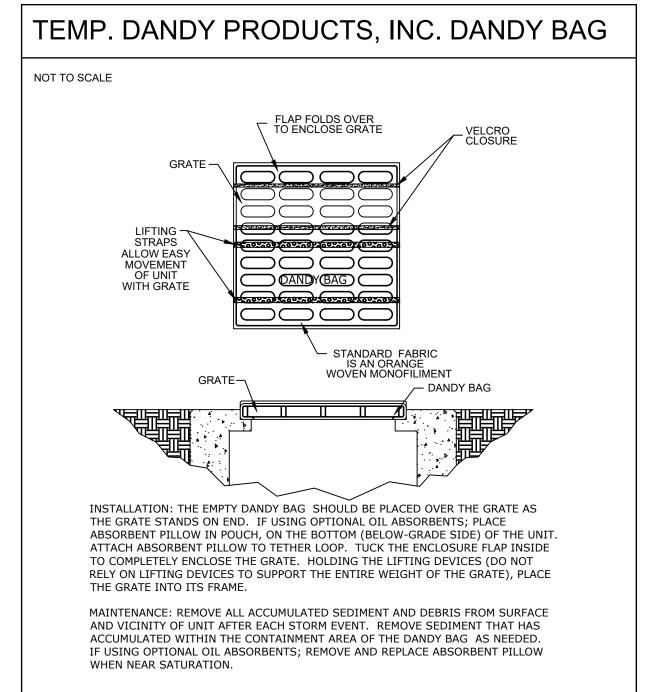

TEMP. GRAVEL AND WIRE MESH

INLET SEDIMENT FILTER

NOT TO SCALE



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Meridian Rd. Winnebago County, Illinois

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2025-09

BA Project No.

Scale

Sheet Title

SWPPP DETAILS

Ref. North Sheet No. C03

PROFESSIONAL DESIGN FIRM REGISTRATION # 184-003342

ROLLED EROSION CONTROL PRODUCTS Staking Pattern Guide Straw Wattle or Overlap minimum is the diameter of the roll.

4' spacing for wattles.

2' spacing for rolled excelsior.

Or space occording to manufacturer's specifications. (To only penetrate netting) Flow —○→ Wood Stake (or equal) seam between the tube and the ground. Soll When compost filter sock ditch check is used, place a compost berm upstream of the filter sock (see IUM 805). A trench is not required. Drawings are not to scale.

Ends of wattles or rolled excelsior shall be turned at least 6" upslope.

Recommended stakes are 1 1/8" wide x 1 1/8" thick x 30" long

Stakes shall not extend above the straw wattle more than 2".

Spacing: The toe of the upstream ditch check shall create a horizontal line with the top of the downstream ditch check.

When compost filter sock ditch check is used, place a compost berm upstream of the filter sock (see 1UM 805). A trench is not required. STANDARD DWG. NO. IUM-514

SHEET 1 OF 1

DATE 8-19-11

TEMPORARY STONE CONSTRUCTION EXIT


INLET PROTECTION PER STRUCTURE TYPE


SHORT TERM SLOPE EROSION CONTROL BLANKET


TEMPORARY SILT FENCE


OUTLET CONTROL PROTECTION


TEMPORARY CHECK DAM

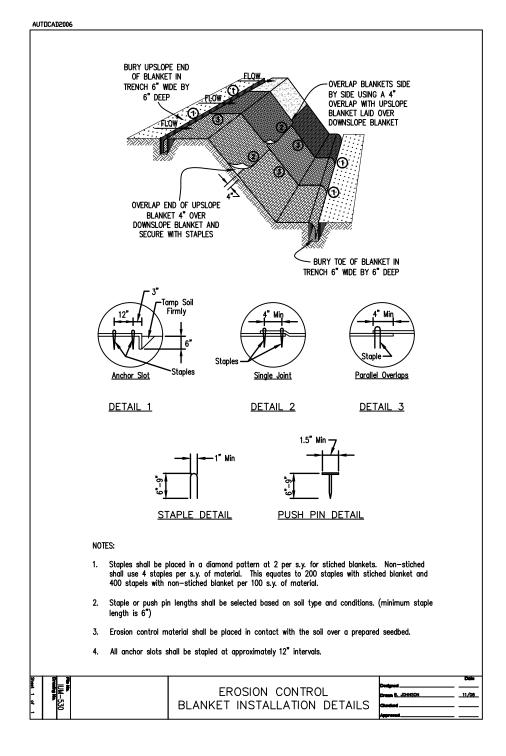


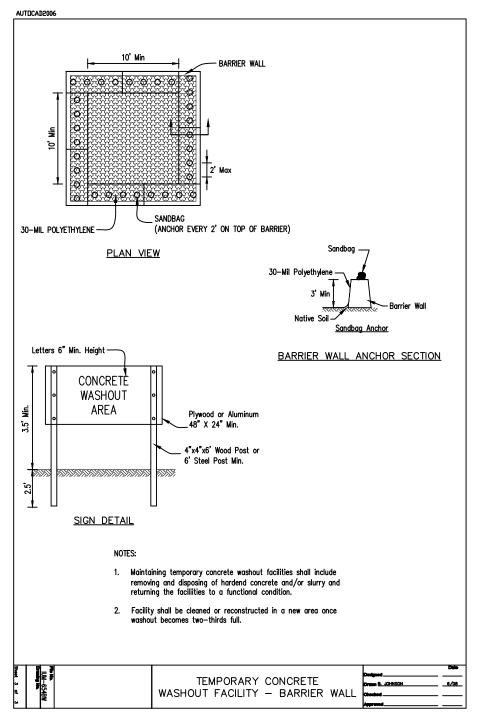


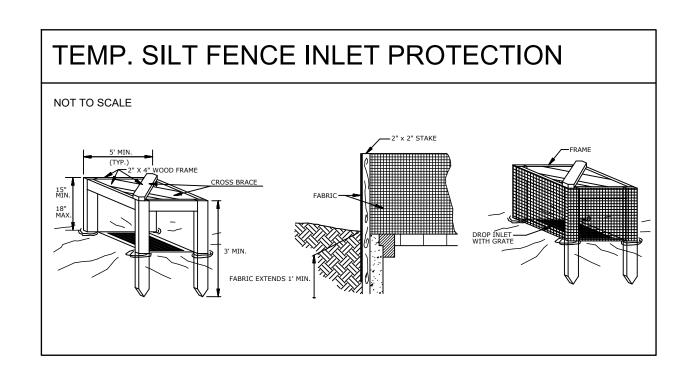

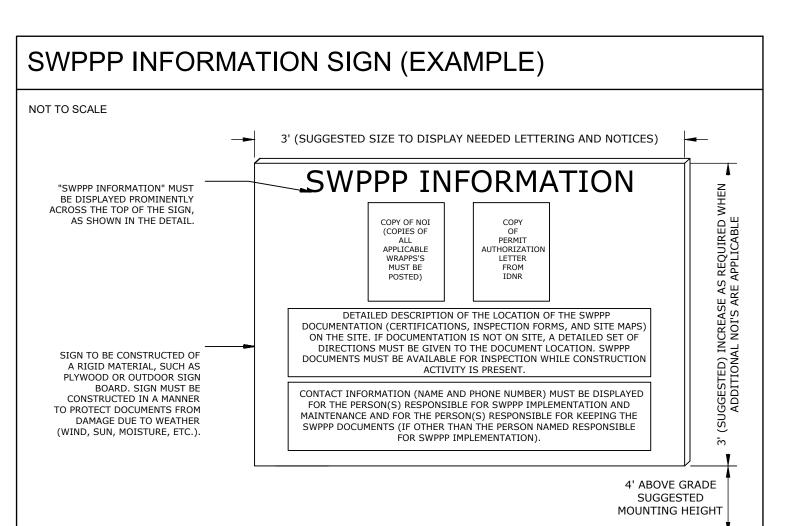

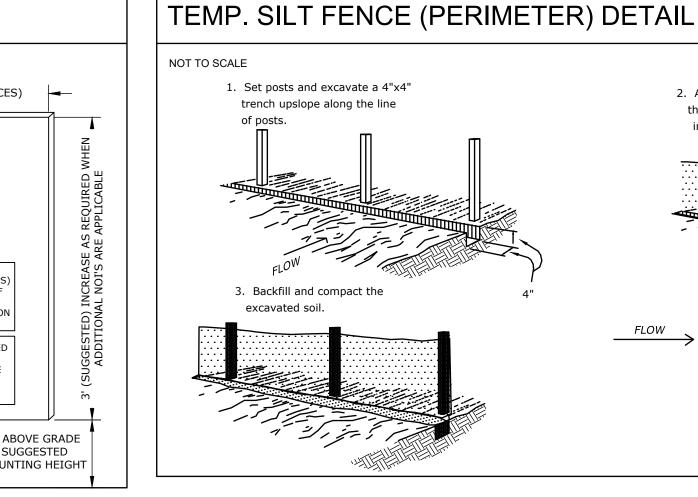

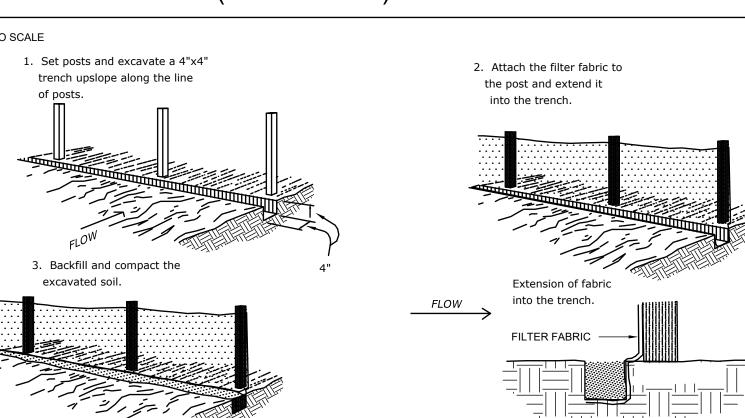

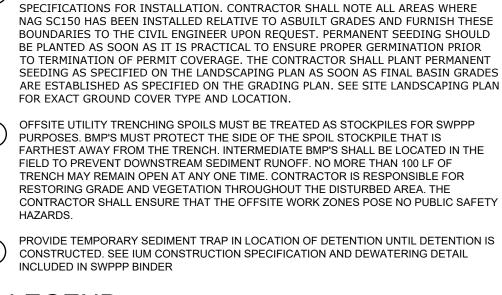

LEGEND SEE SITE PLAN SET FOR EXISTING SYMBOLS

(X.XX

— — — PROPERTY LINE LIMITS OF DISTURBANCE PROPOSED CONTOUR LINE - - - - 800- - - EXISTING CONTOUR LINE

PERMANENT STORM SEWER FLOWING TO THE LEFT. SEE SITE DRAINAGE PLAN FOR PERMANENT STORM SEWER INFORMATION

PROPOSED CURB AND GUTTER PROPOSED CATCH BASIN OR MANHOLE

> DIRECTION OF OVERLAND FLOOD ROUTE DIRECTION OF OVERLAND FLOW AND SLOPE

SEE SPECIFIC KEY NOTE ON THIS SHEET

TURF AREA (SEE LANDSCAPING PLAN FOR TYPE)

ST

OCP)

(1.04)

(1.07)

EROSION DETAILS (SEE SWPPP DETAILS SHEET FOR ITEMS BELOW)

PERMANENT TURF REINFORCEMENT, NORTH AMERICAN GREEN SC250

SEDIMENT TRAP


CONCRETE WASHOUT (IF NEEDED)

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IL-660 SHEET 1 OF

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EXISTING OVERHEAD UTILITIES TO REMAIN

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Meridian Rd., Winnebago County, Illinois

AND CONDITIONS AT THE SITE PRIOR TO SUBMITTING A BID. THE CONTRACTOR SHALL COORDINATE ALL DRAWINGS WITH ACTUAL FIELD CONDITIONS PRIOR TO PROCEEDING WITH THE WORK AND NOTIFY THE ARCHITECT OF ANY DISCREPANCIES. THIS DRAWING IS THE PROPERTY OF BLAKEMORE ARCHITECTS AND MAY NOT BE REPRODUCED WITHOUT THE PRIOR WRITTEN PERMISSION OF THE ARCHITECT.
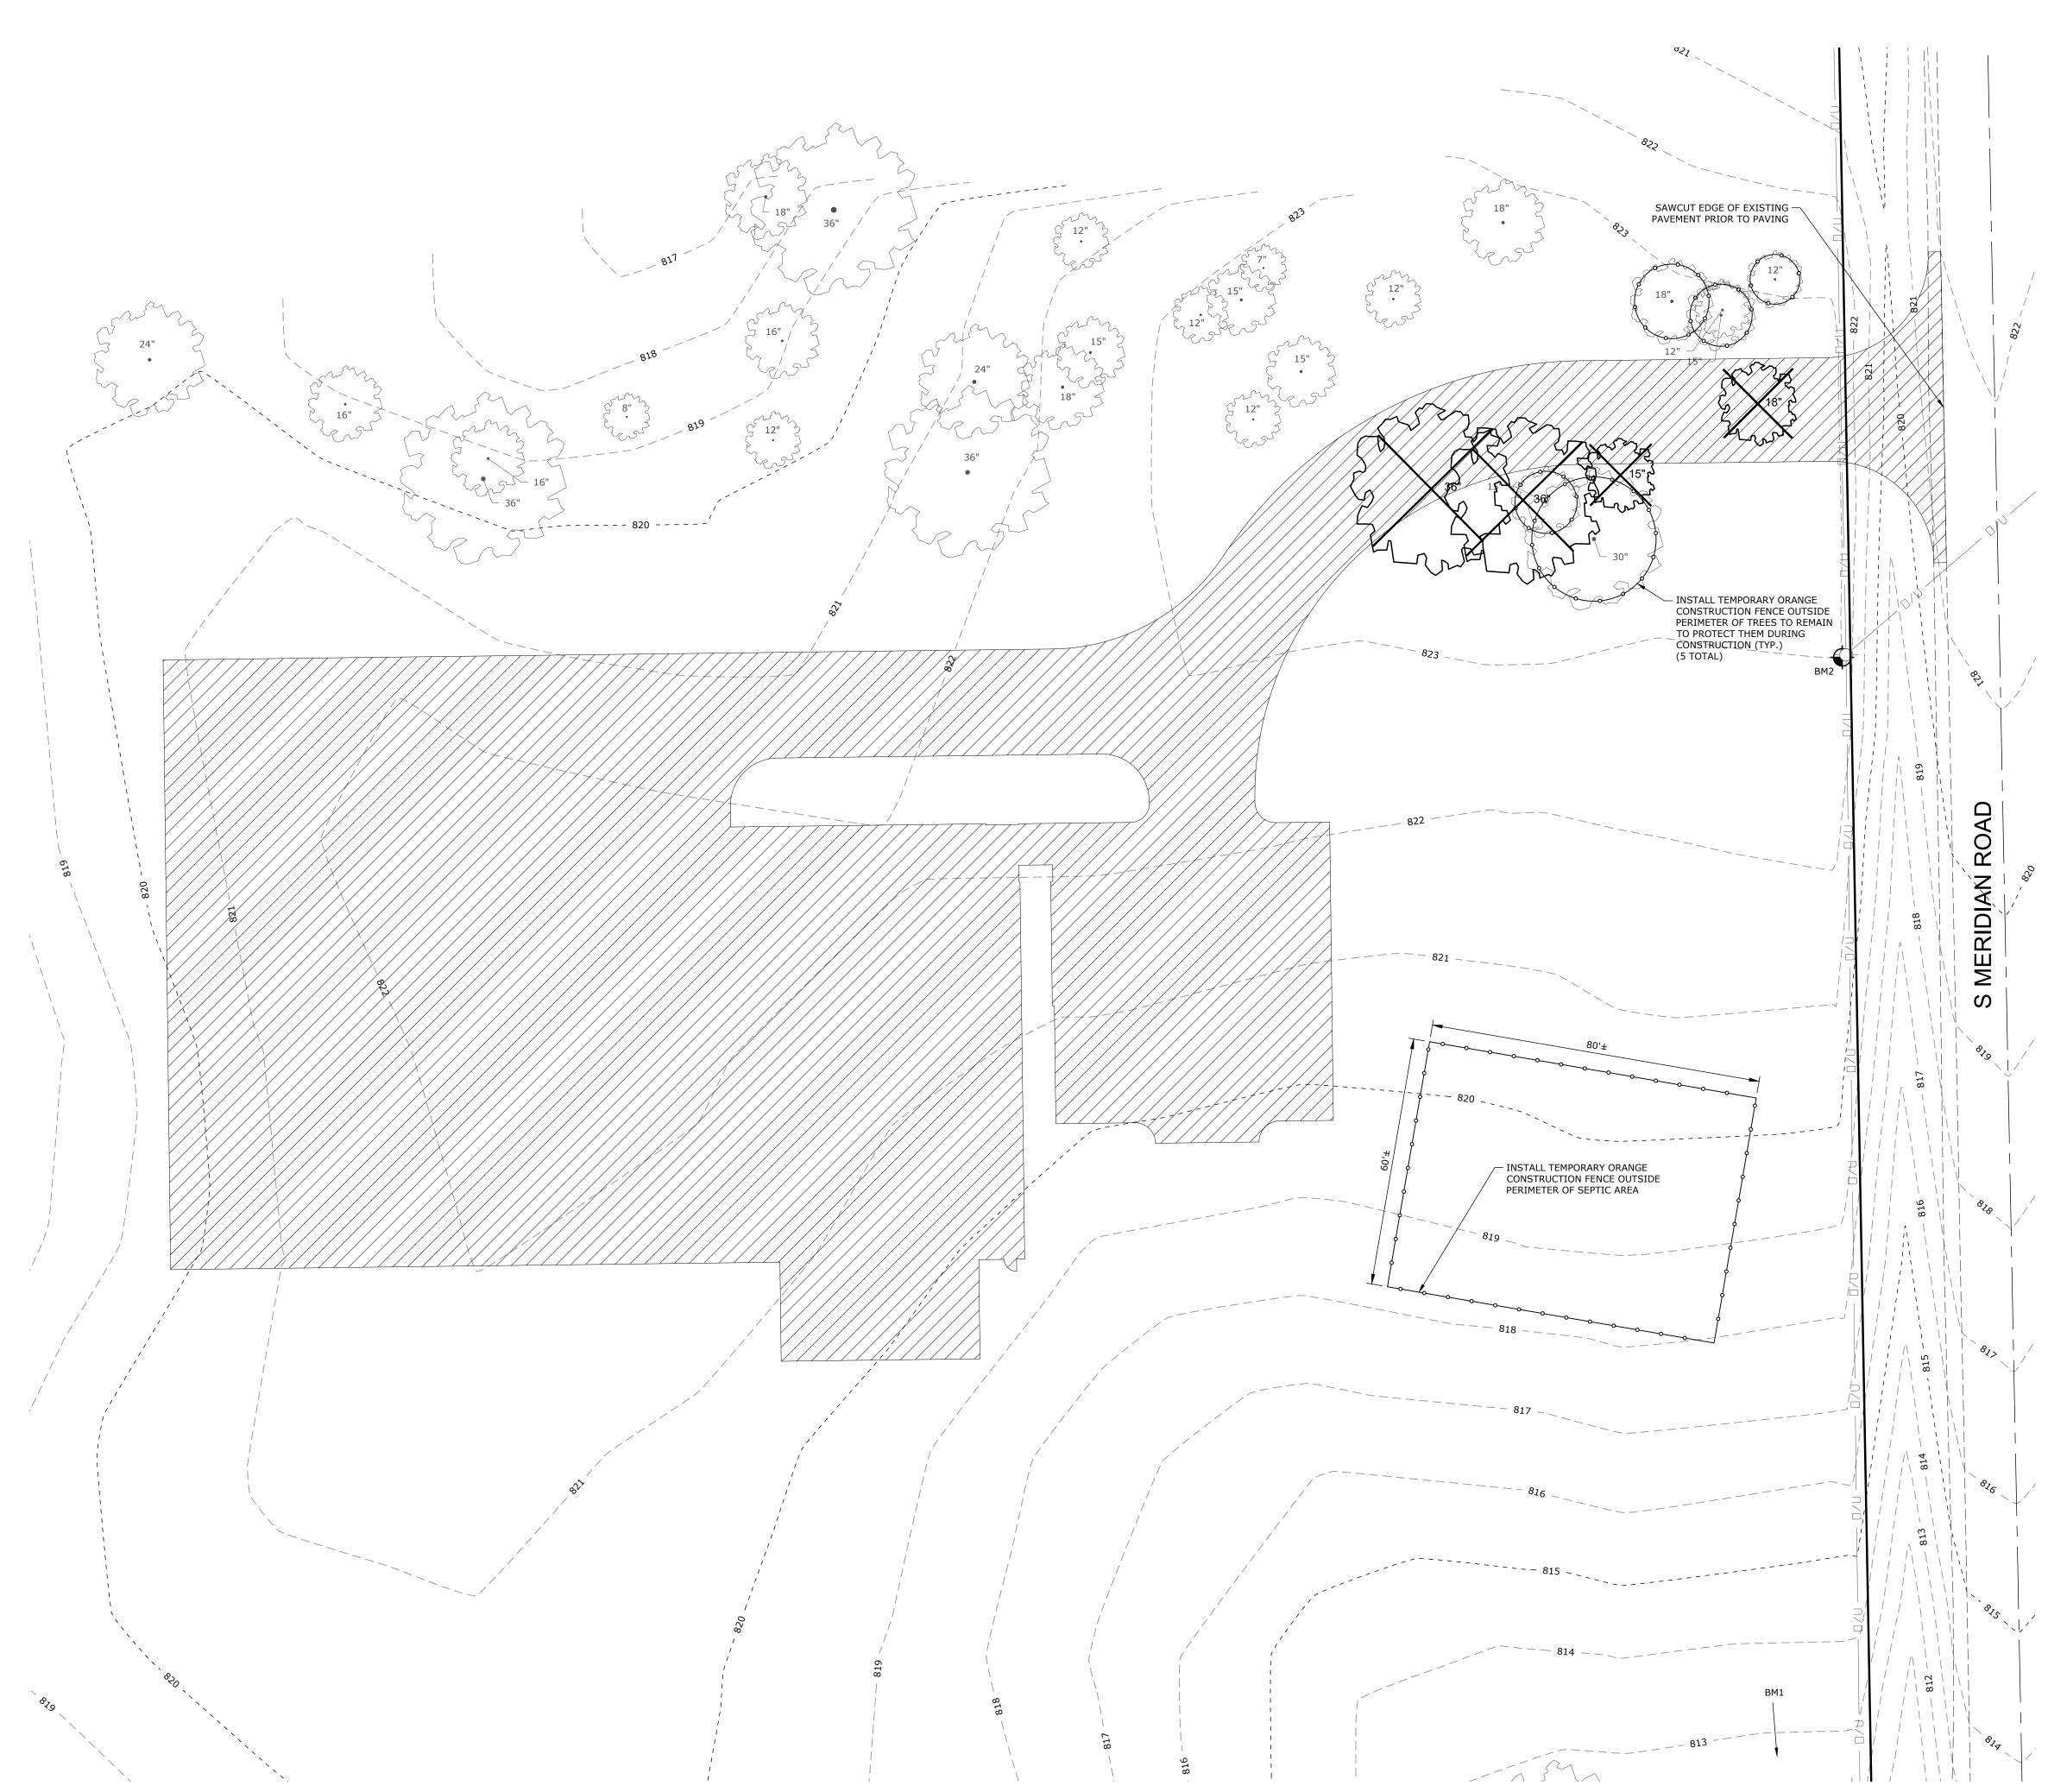
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Scale

NO. DATE

Sheet Title **EXISTING CONDITIONS** AND REMOVALS PLAN

RESOURCES INC.

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1: 20

PROFESSIONAL DESIGN FIRM REGISTRATION # 184-003342

BENCHMARKS DESCRIPTION **ELEVATION (USGS)** BENCHMARK 1 RAILROAD SPIKE IN POWER POLE 811.68 BENCHMARK 2 RAILROAD SPIKE IN POWER POLE 823.52

EXISTING STORM SEWER TO REMAIN

AREA TO BE CORED OUT FOR BUILDING FOUNDATION, PARKING LOT, SIDEWALKS, ETC.

EXISTING WATER TO REMAIN


EXISTING SIGN TO REMAIN


EXISTING LIGHT POLE TO REMAIN

BENCHMARK

- - - - 800- - - EXISTING CONTOUR LINE

LEGEND

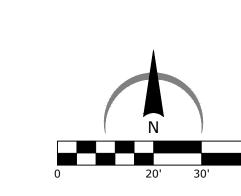

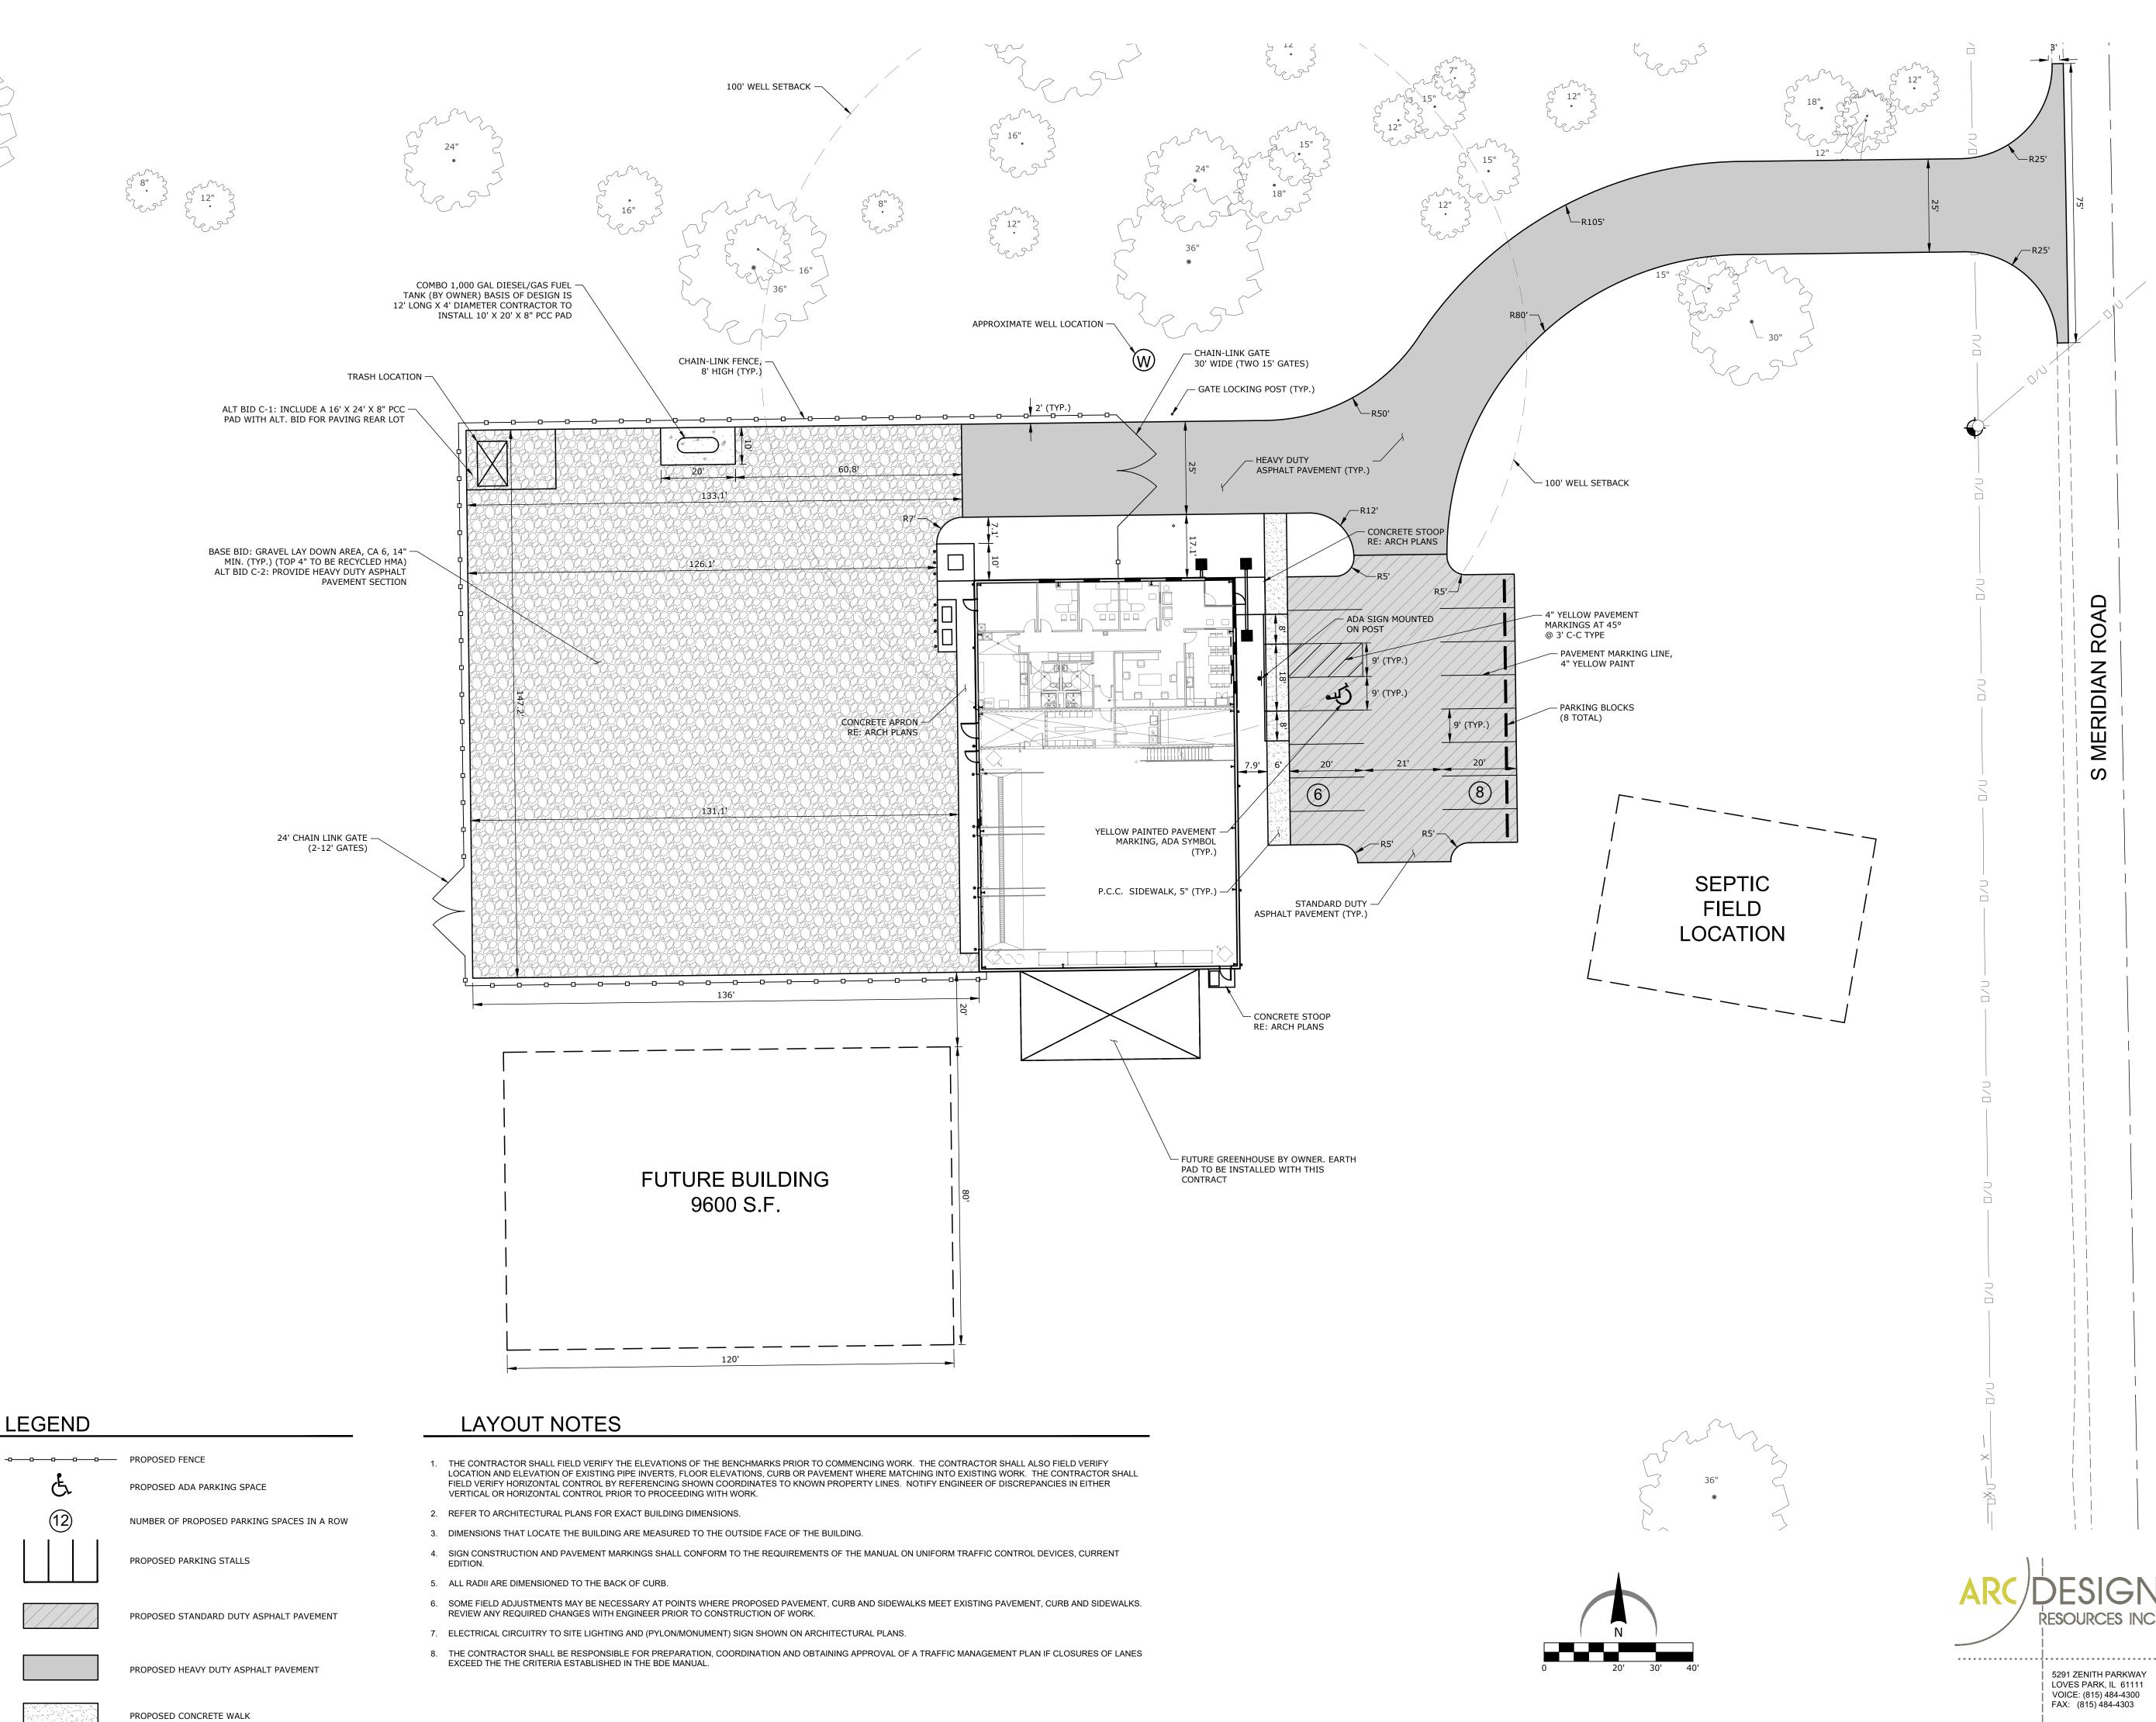

LEGEND

BLAKEMORE ARCHITECTS

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Forest Preserves of Winnebago County

Meridian Rd., Winnebago County, Illinois

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2025-09 BA Project No.

Scale

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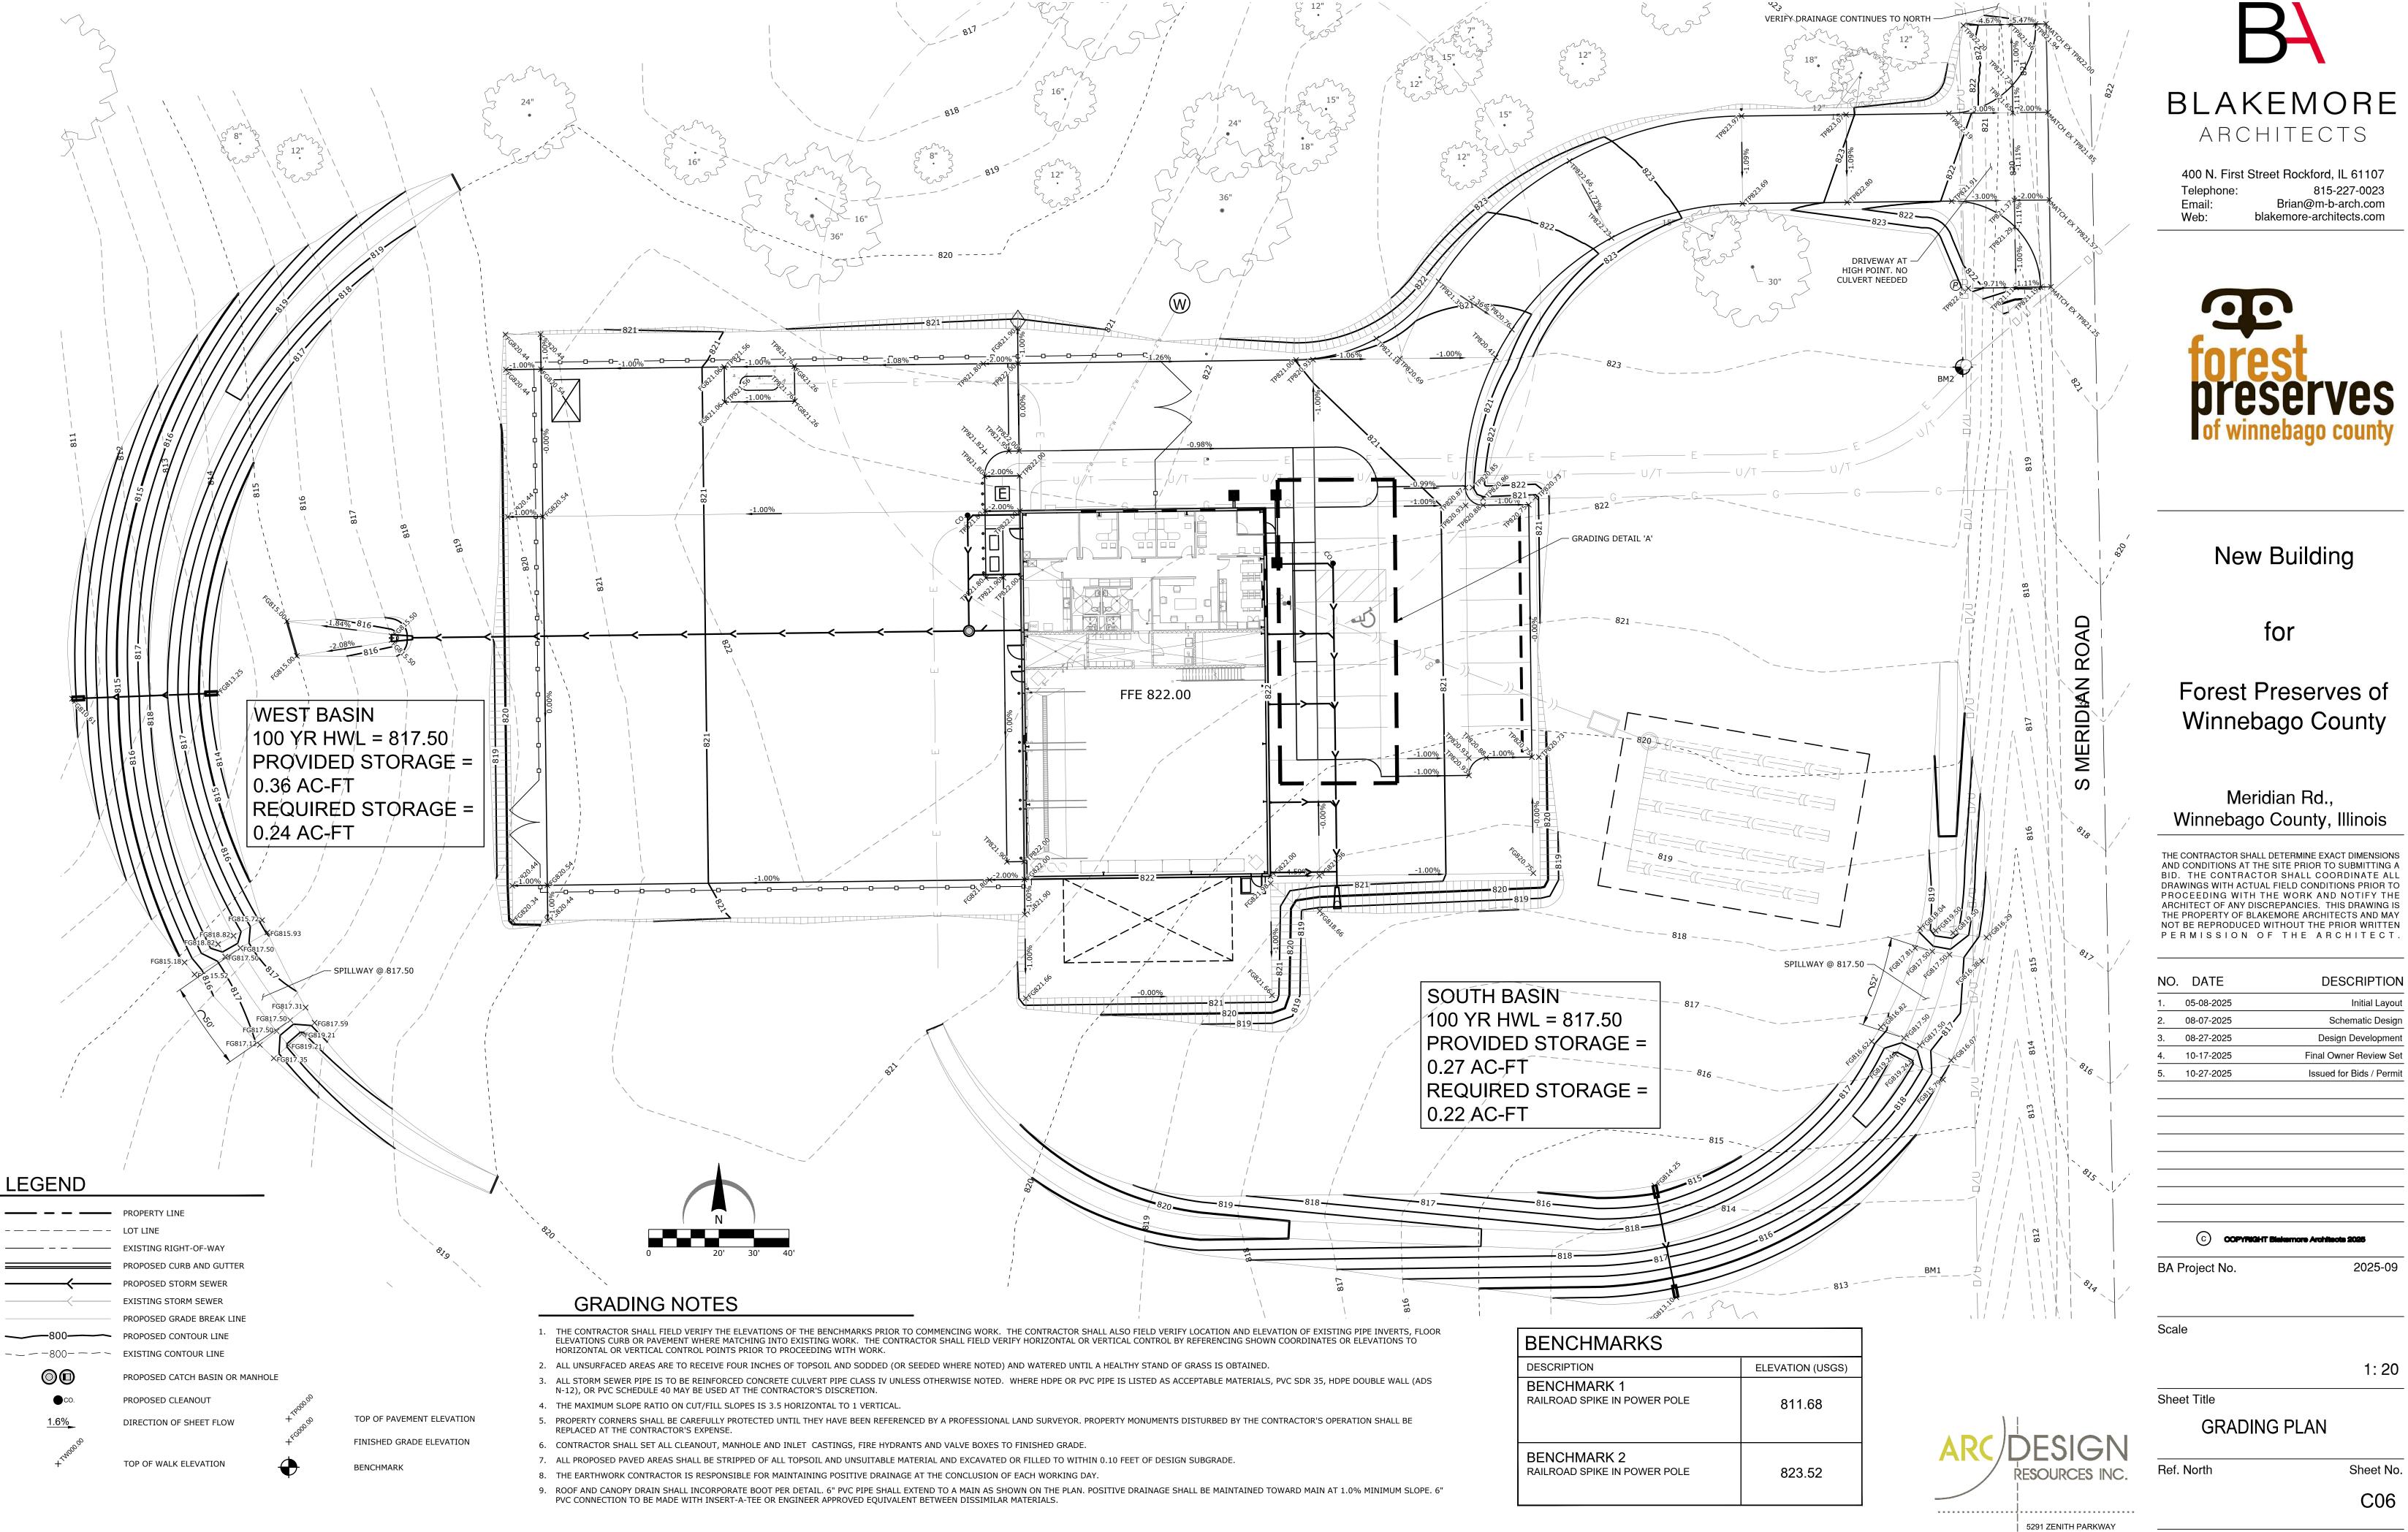
Sheet Title

LAYOUT PLAN

Ref. North

Sheet No.

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Forest Preserves of

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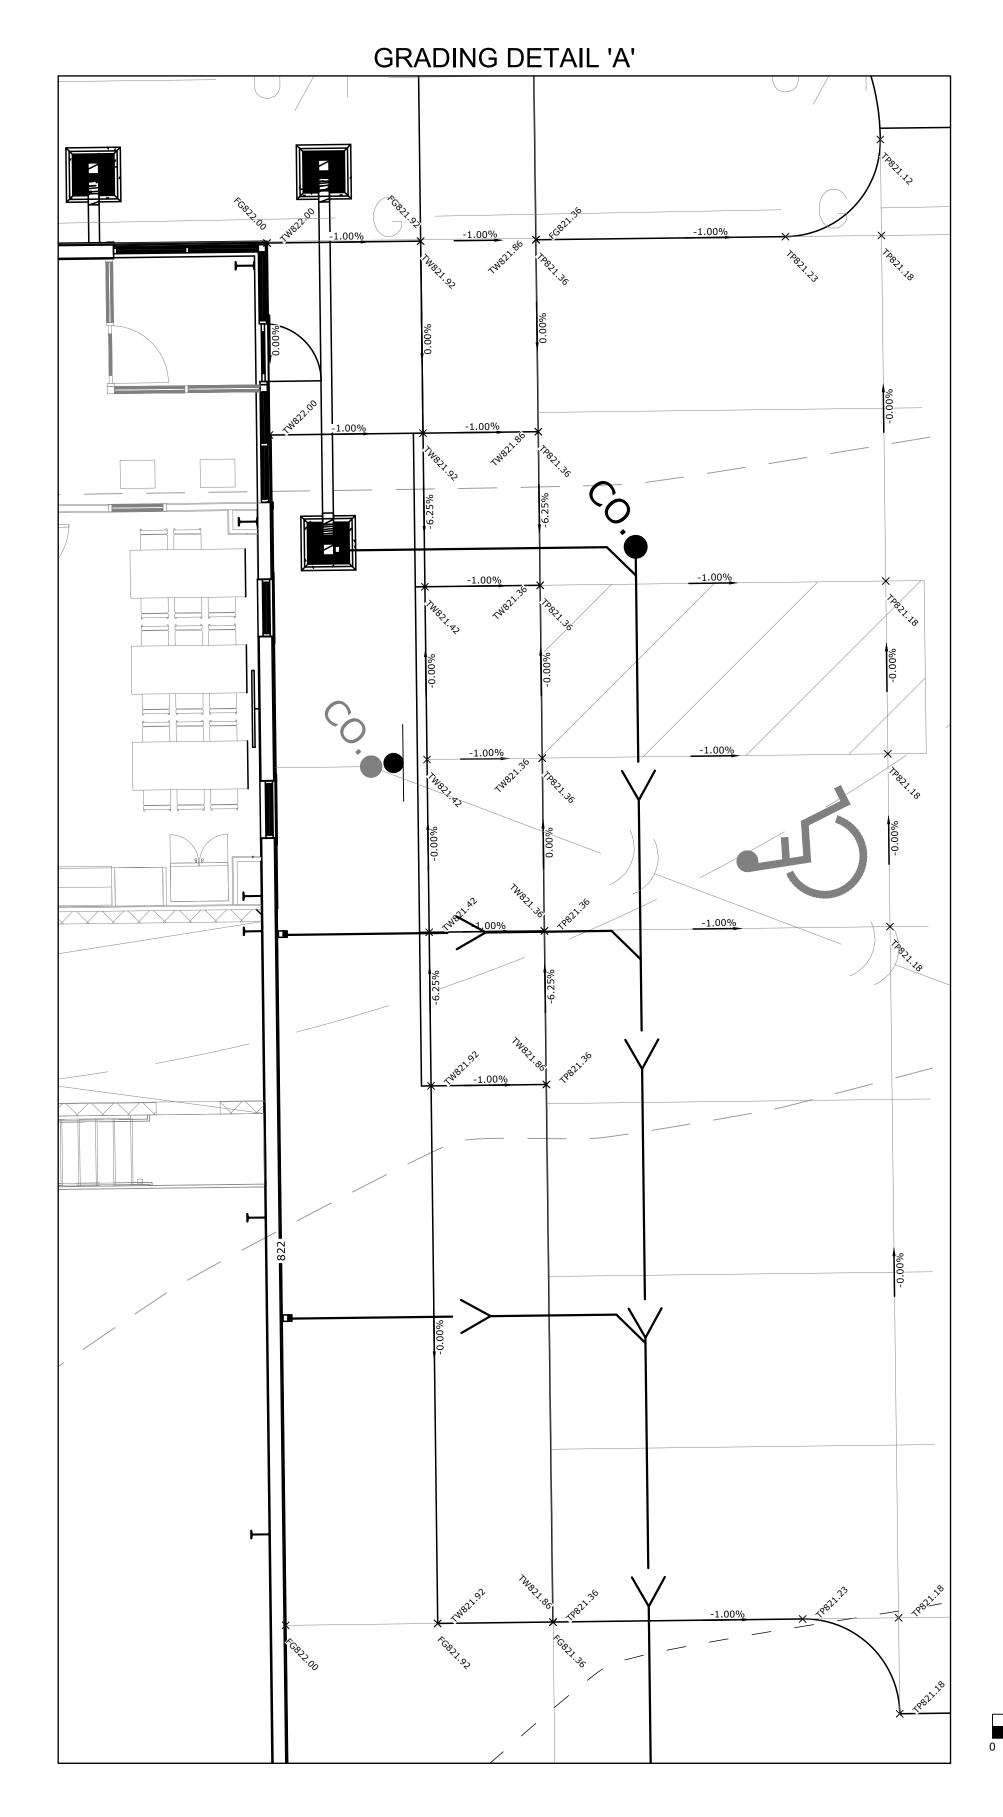
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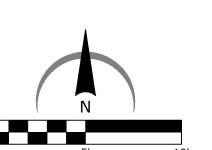
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New Building

for

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Meridian Rd., Winnebago County, Illinois

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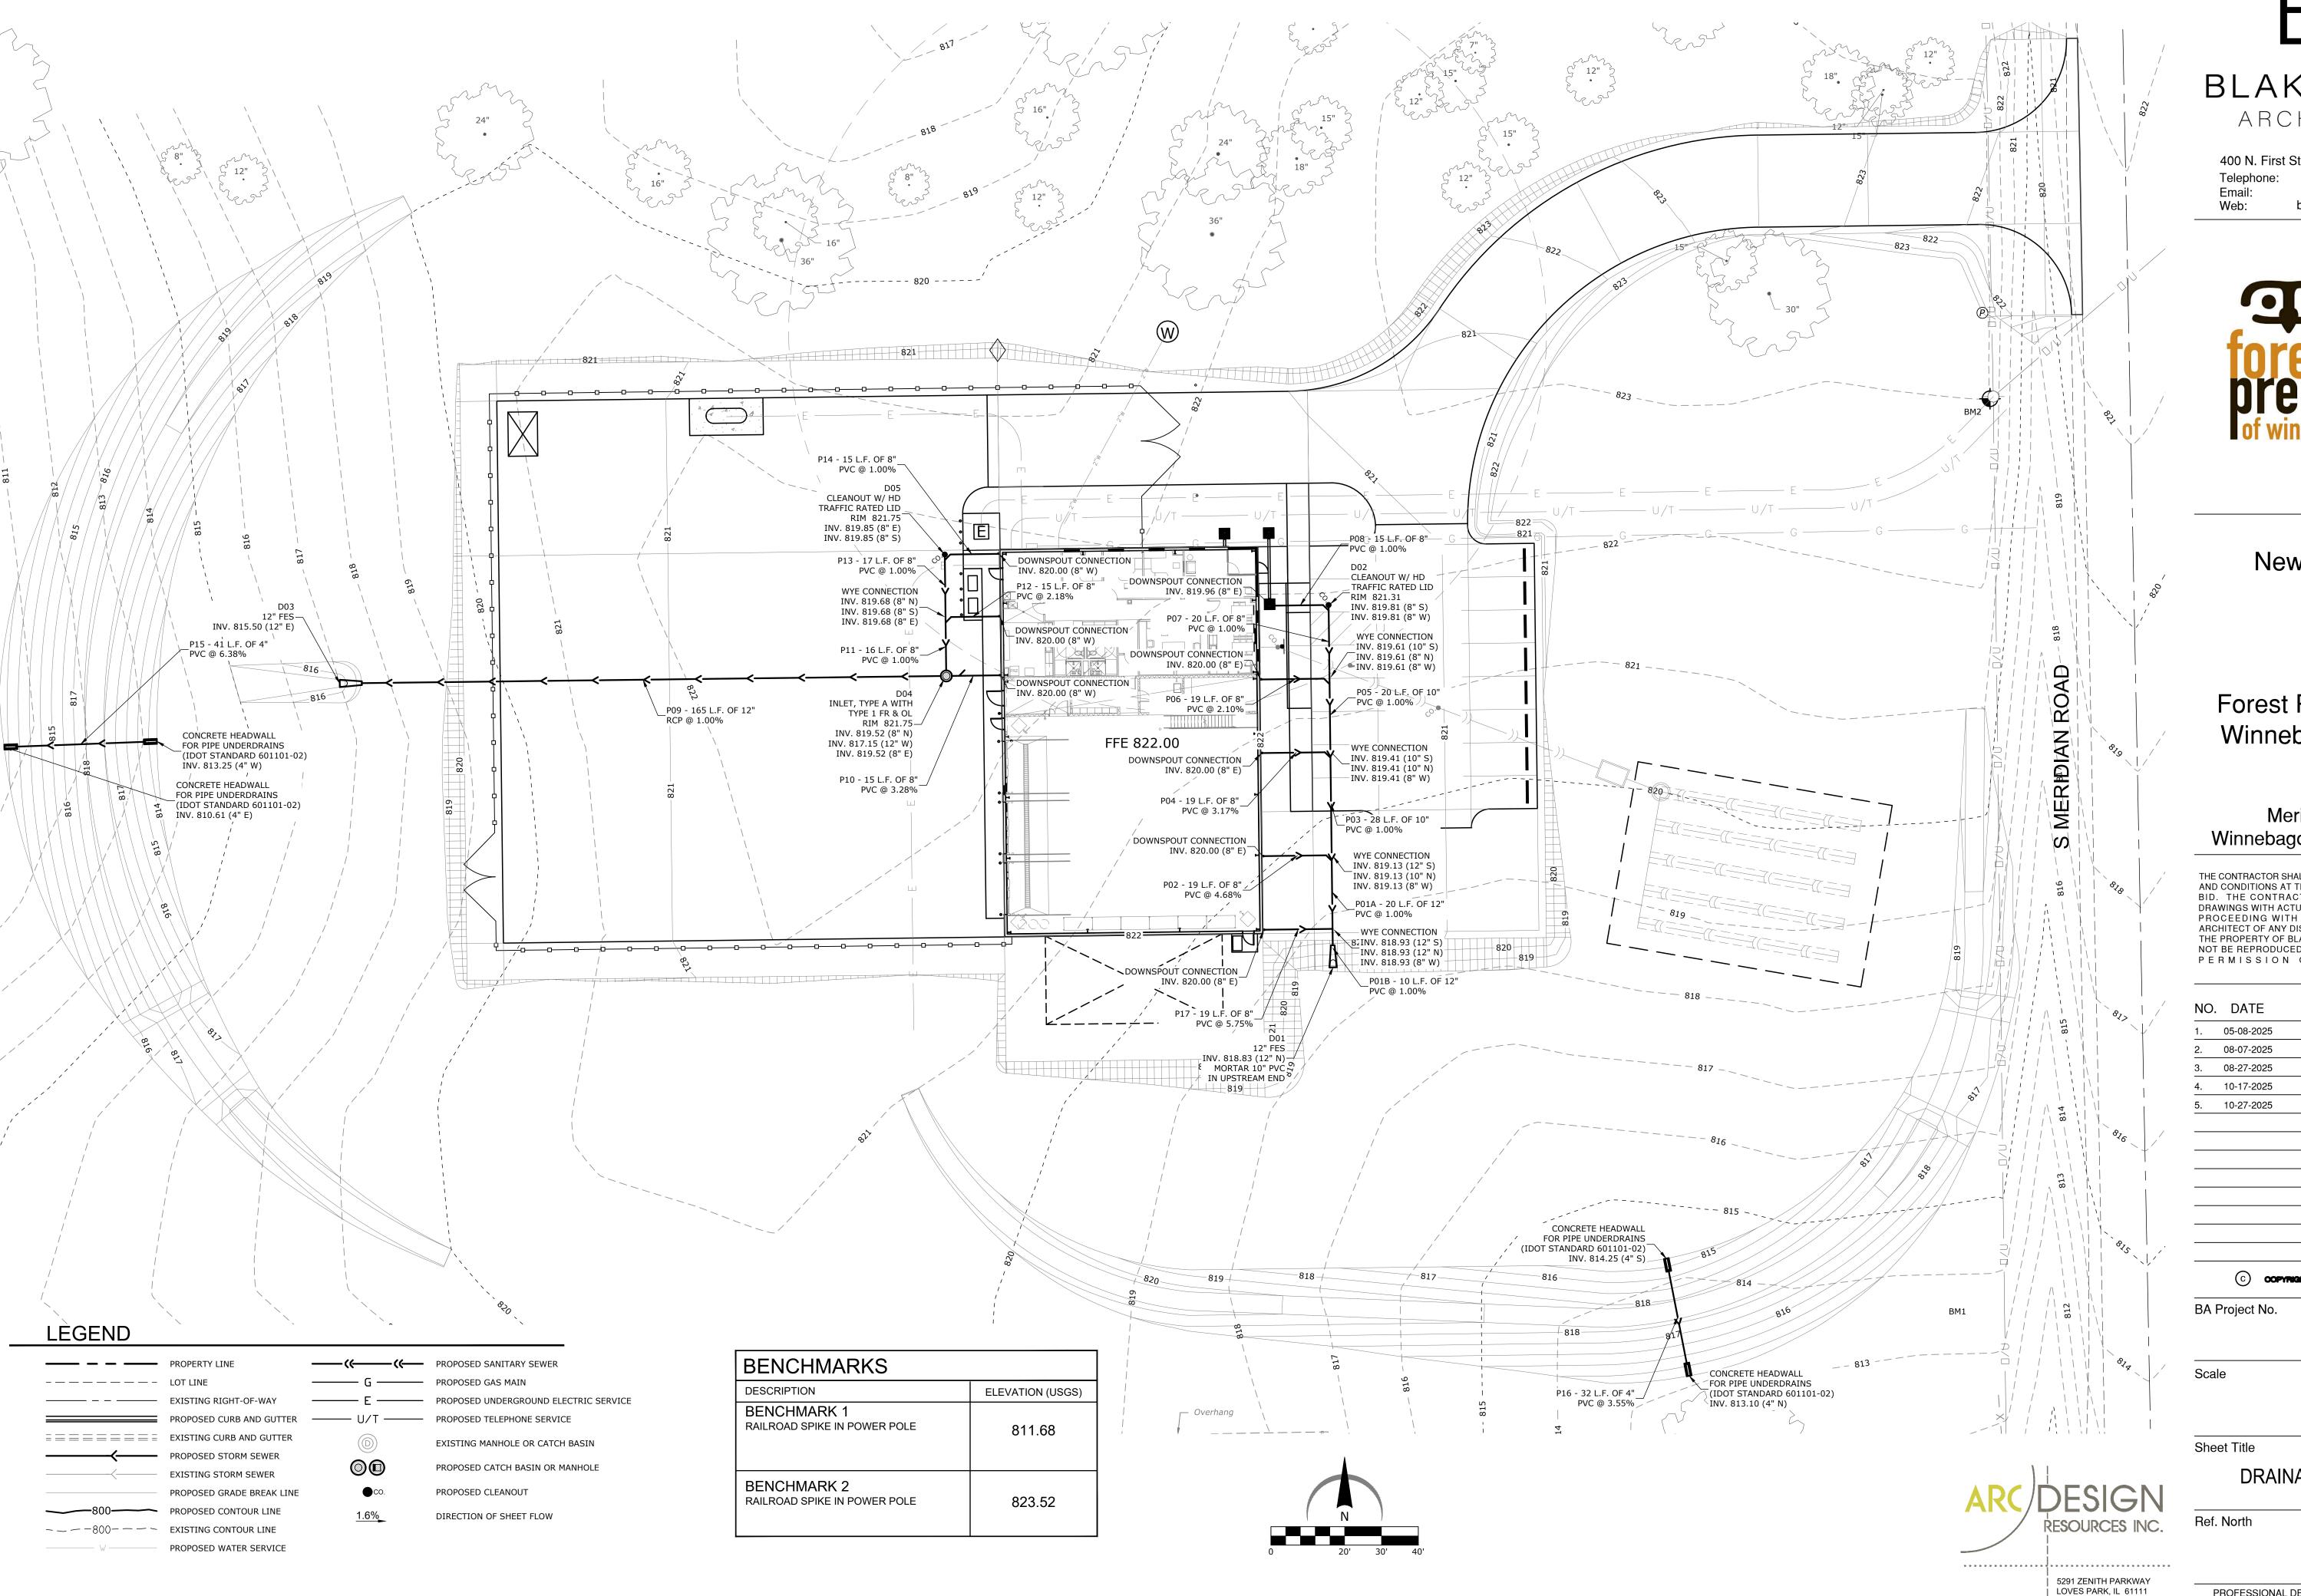
Sheet Title
GRADING PLAN

DETAILS

Sheet No.

C07







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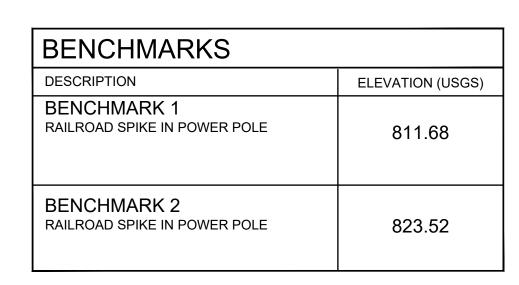
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DRAINAGE PLAN

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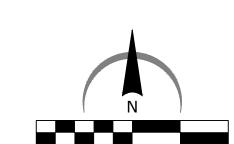


SEPTIC SYSTEM NOTES


- THE AREA IN WHICH THE SEPTIC SYSTEM WILL BE INSTALLED SHALL BE PROTECTED FROM HEAVY EQUIPMENT, EXCESSIVE DISTURBANCE, AND COMPACTION.
- CAREFULLY REMOVE EXISTING VEGETATION FROM THE SEPTIC FIELD AREA. SHRUBS OR TREES WITH A MAIN STEM LARGER THAN 4" DIAMETER SHALL BE CUT AT THE GROUND SURFACE, AND THE REMAINING STUMPS SHALL BE GROUND TO A DEPTH OF 4"-6" MAXIMUM. SMALLER VEGETATION MAY BE UPROOTED.
- 3. THE SEPTIC FIELD HAS BEEN DETERMINED TO BE OUT OF A FLOOD HAZARD ZONE. 4. THE SEPTIC TANK MUST HAVE AN ACCESS MANHOLE RISER EXTENDING TO THE GROUND
- 5. SEWER PIPES SHALL BE 4" PVC SCHEDULE 40 OR CAST IRON. HEADER LINES SHALL BE 4" PVC
- 6. THE SEPTIC FIELD PIPE SHALL BE PERFORATED SEPTIC PIPE MEETING ASTM F810 STANDARD AND
- WINNEBAGO COUNTY SEPTIC CODES. 7. ALL CONSTRUCTION METHODS AND MATERIALS SHALL ALSO COMPLY WITH LOCAL PUBLIC HEALTH
- 8. CONTACT J.U.L.I.E. PRIOR TO CONSTRUCTION TO CONFIRM UNDERGROUND UTILITY CLEARANCE
- NO POOLING WATER IS ALLOWED ABOVE THE SEPTIC FIELD UPON COMPLETION.
- 10. CLEAR WATER FROM THE BUILDING SUCH AS CONDENSATE DRAIN LINES OR FOUNDATION DRAINS
- SHALL NOT BE DISCHARGED TO THE SEPTIC SYSTEM. 11. SEED AND FERTILIZE THE TOPSOIL FILL OVER THE SEPTIC FIELD. WATER UNTIL A HEALTHY STAND OF GRASS IS IN PLACE.
- 12. CONTACT WINNEBAGO COUNTY DEPARTMENT OF HEALTH FOR ALL REQUIRED FIELD OBSERVATIONS PRIOR TO BACKFILLING OR COMPLETION OF THE SYSTEM.
- a. NO PRIVATE WATER WELLS ARE LOCATED WITHING 100' MEASURED RADIALLY FROM THE MOST OUTER PERIMETER OF THE SEPTIC FIELD. b. ESTIMATED HYDRAULIC LOADING RATE FROM THE SOIL CLASSIFIER AT DESIGN DEPTH IS
- 0.52 GALLONS PER SQUARE FOOT PER DAY. ALL FOUR BORINGS SHOW SOIL WITH THE SAME
- c. THE ESTIMATED DAILY USE IS 425 GALLONS PER DAY.
- d. 425 GPD / 0.52 GPDPSR = 817.31 SQUARE FEET OF ABSORPTION AREA. USE 820 SQUARE
- e. 820SF / 3' WIDE TRENCH BOTTOM WIDTH = 273.3 LINEAL FEET OF TRENCH. USE 275 FEET OF
- f. 5 RUNS OF 55' EACH RESULTS IN 275 FEET OF TRENCH. SEE PLAN FOR LOCATIONS AND PIPE


ESTIMATED WASTWATER FLOWS


y units each	(gpd per unit) 15	total flow 225
	15	225
a acces he		
each	100	100
each	5	100
		5 5 5 5 5 5 5 5 5 5 5 5 5 5 5 5 5 5 5 5



Total anticipated waste flows

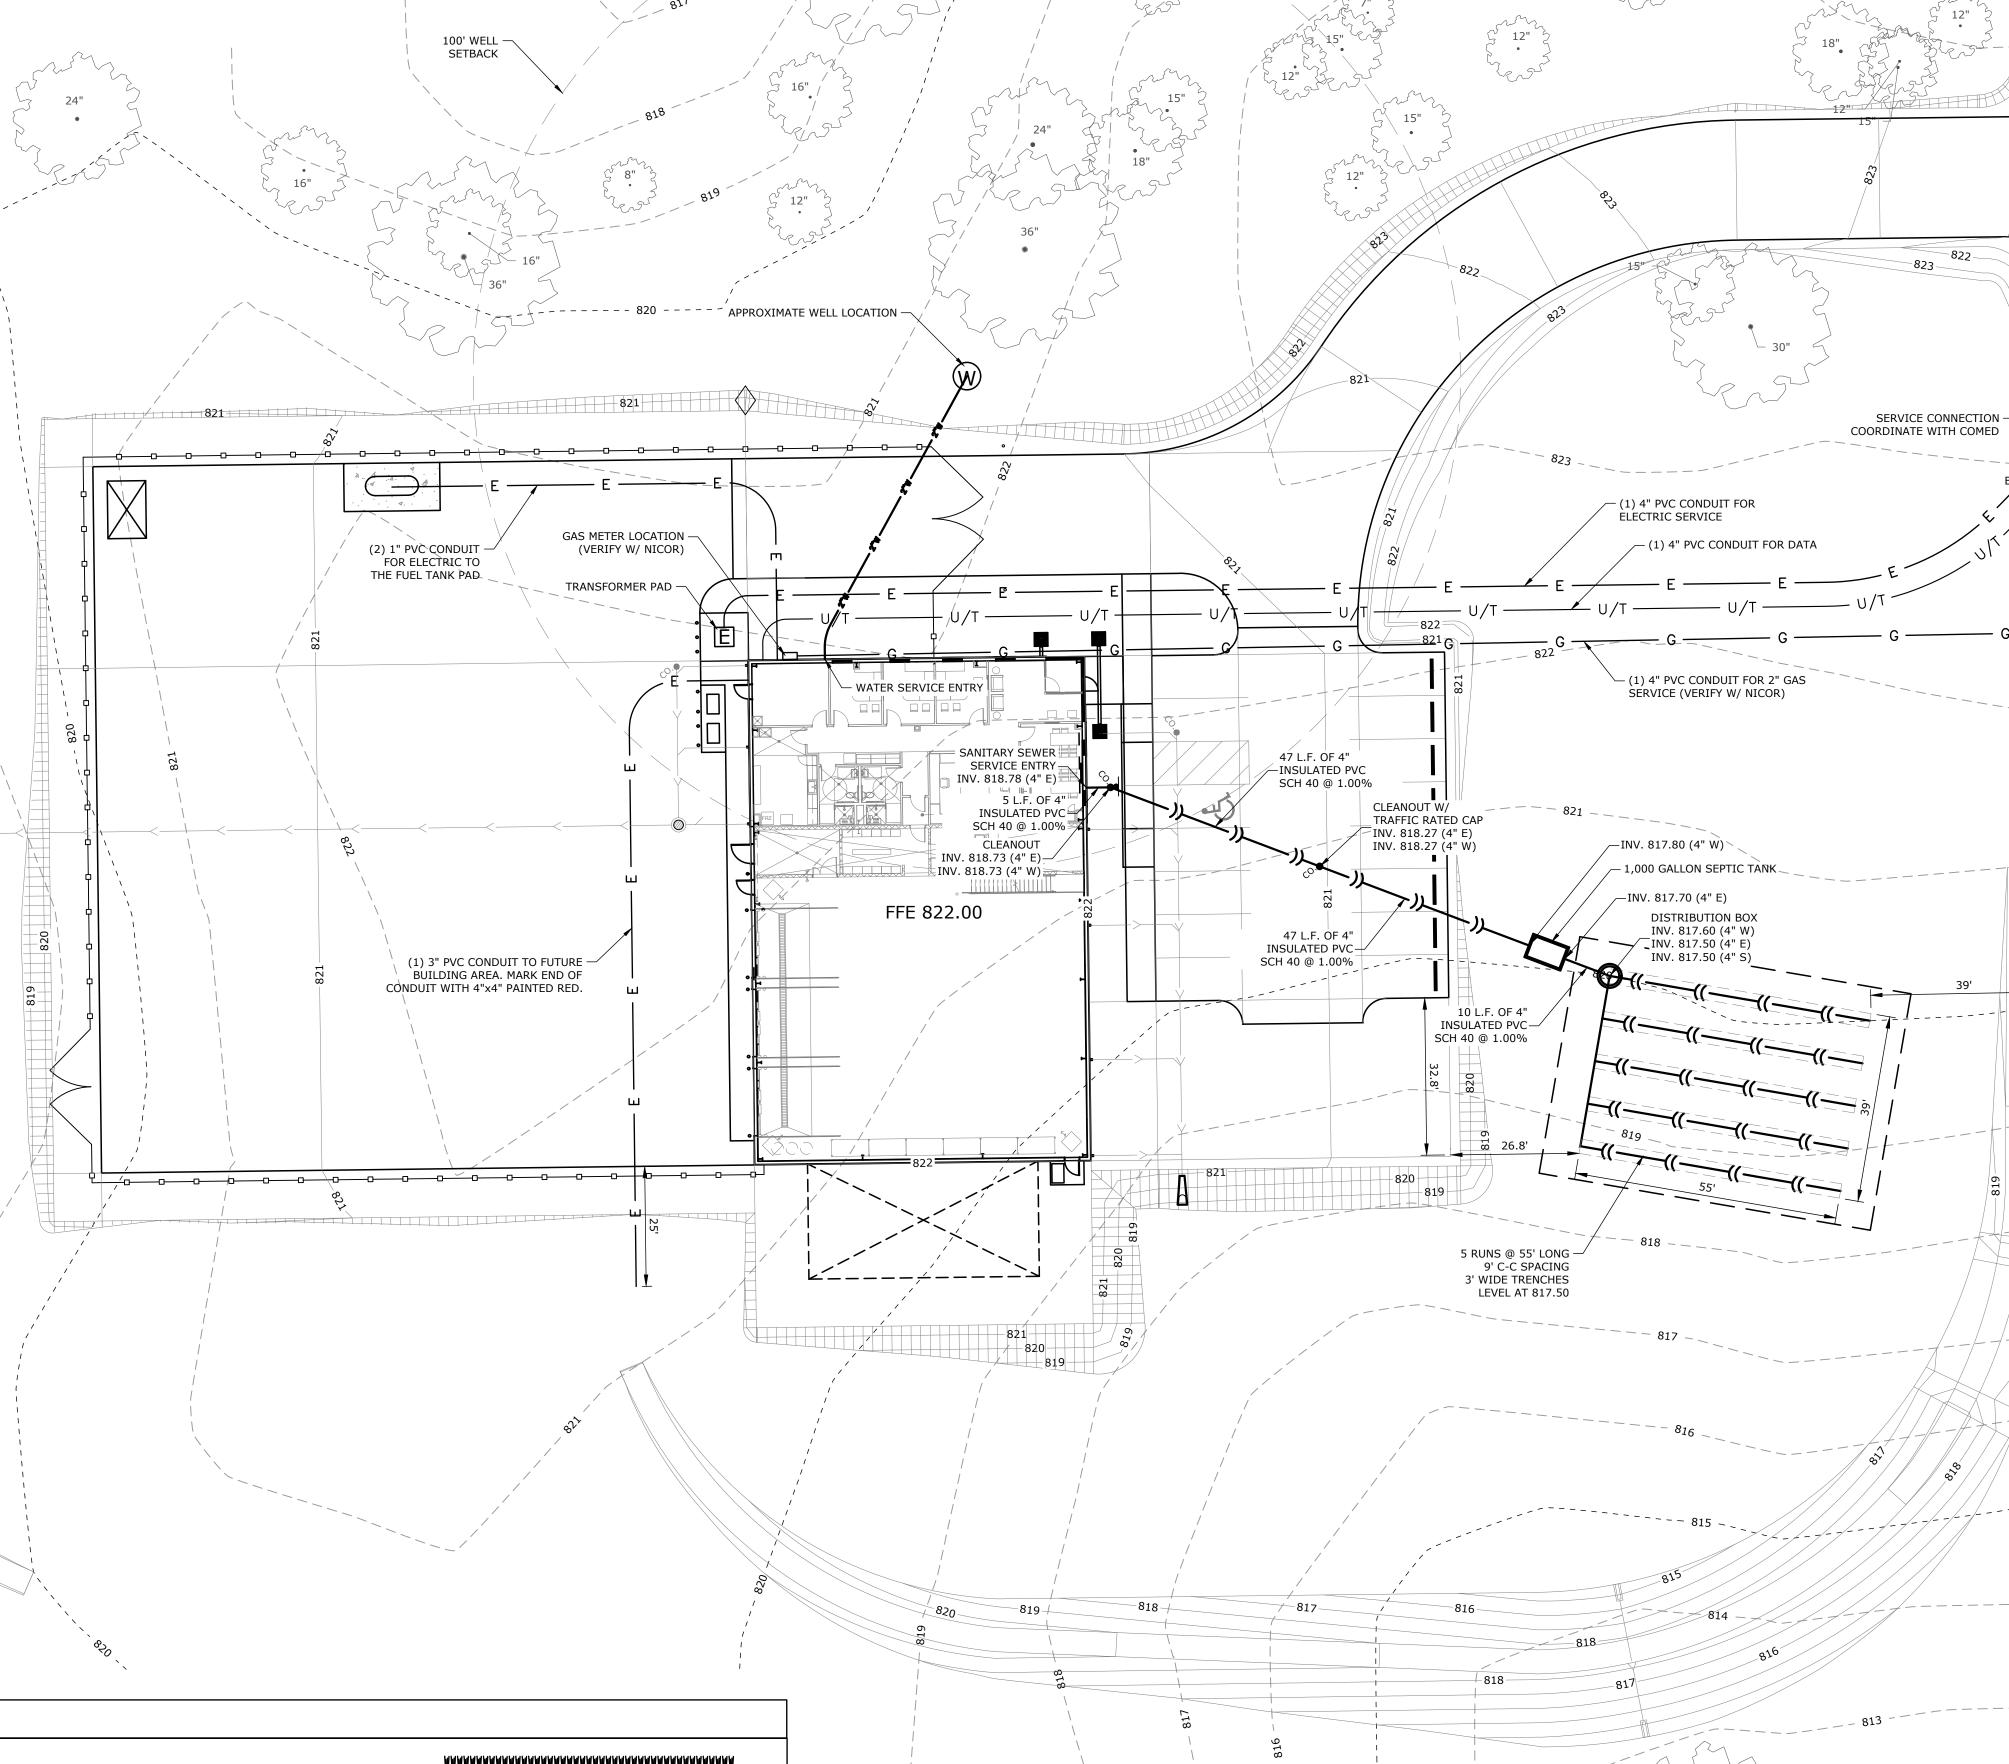

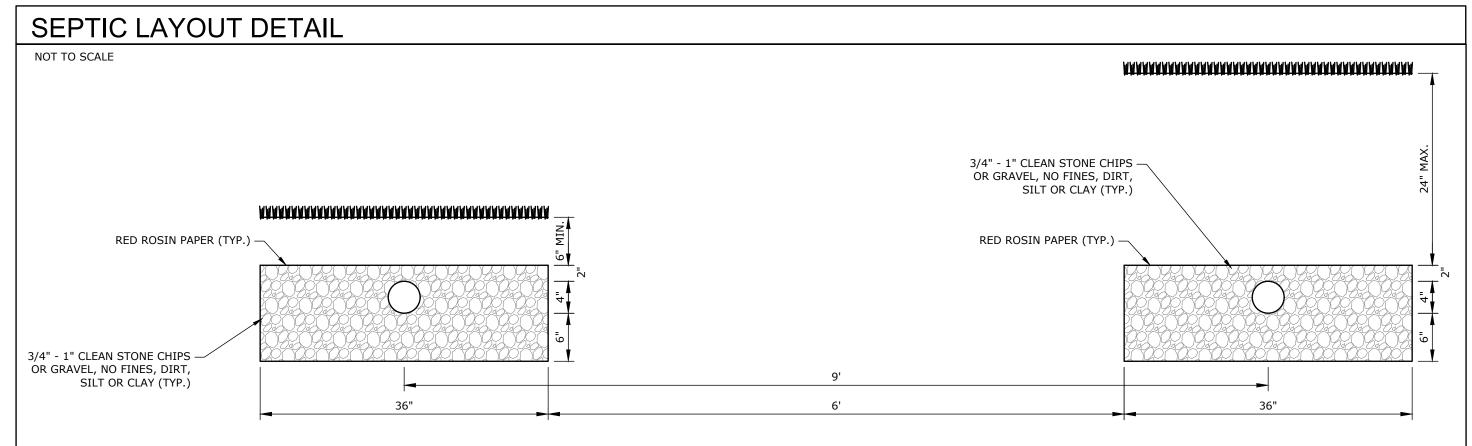

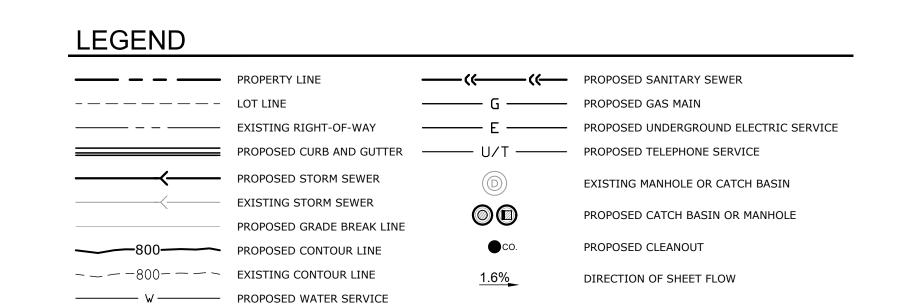



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New Building

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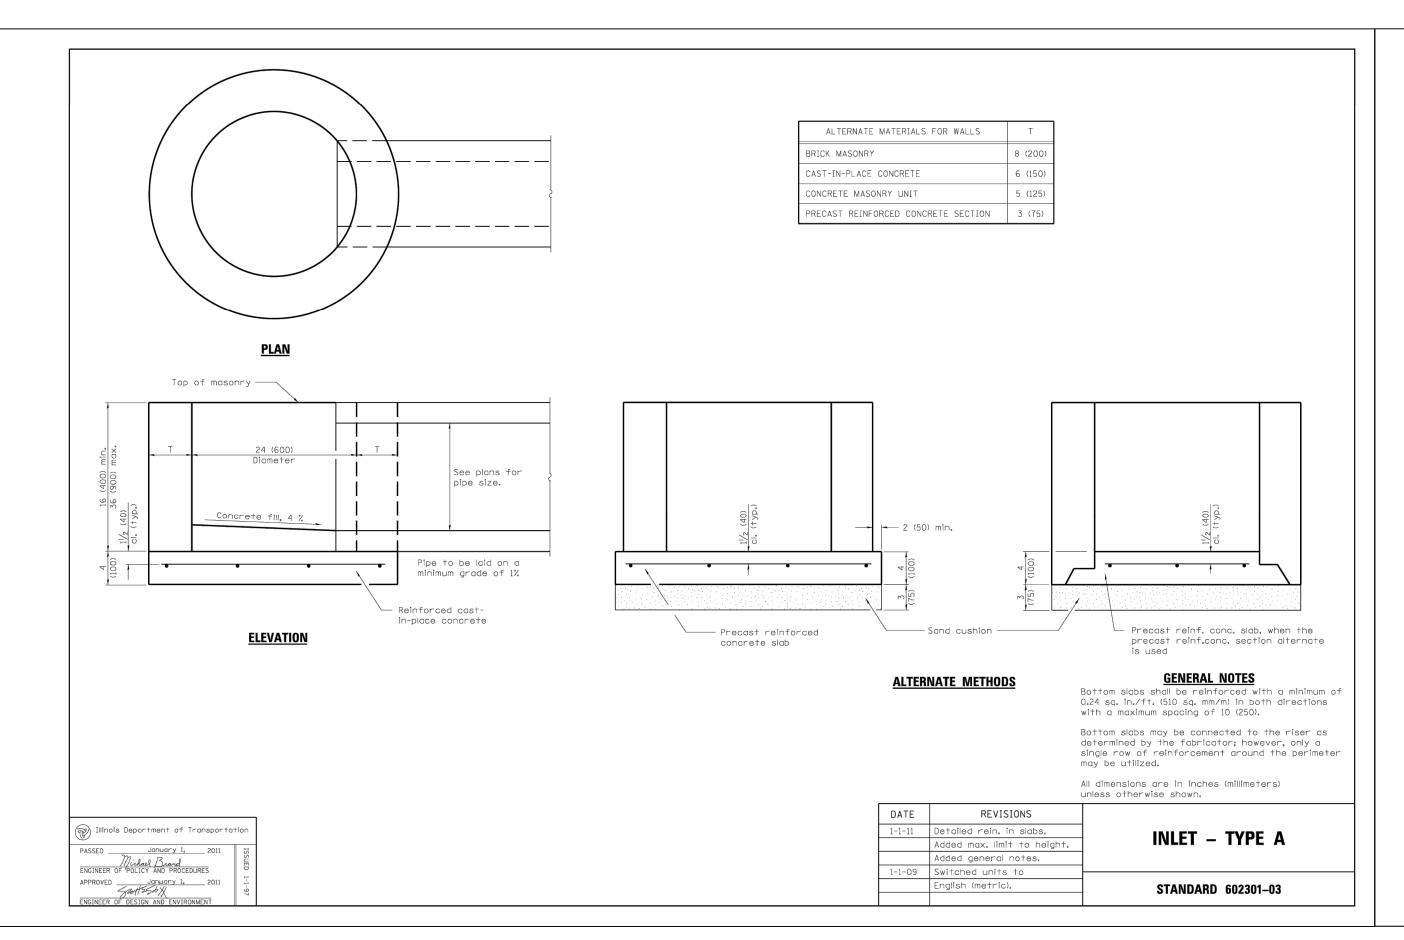
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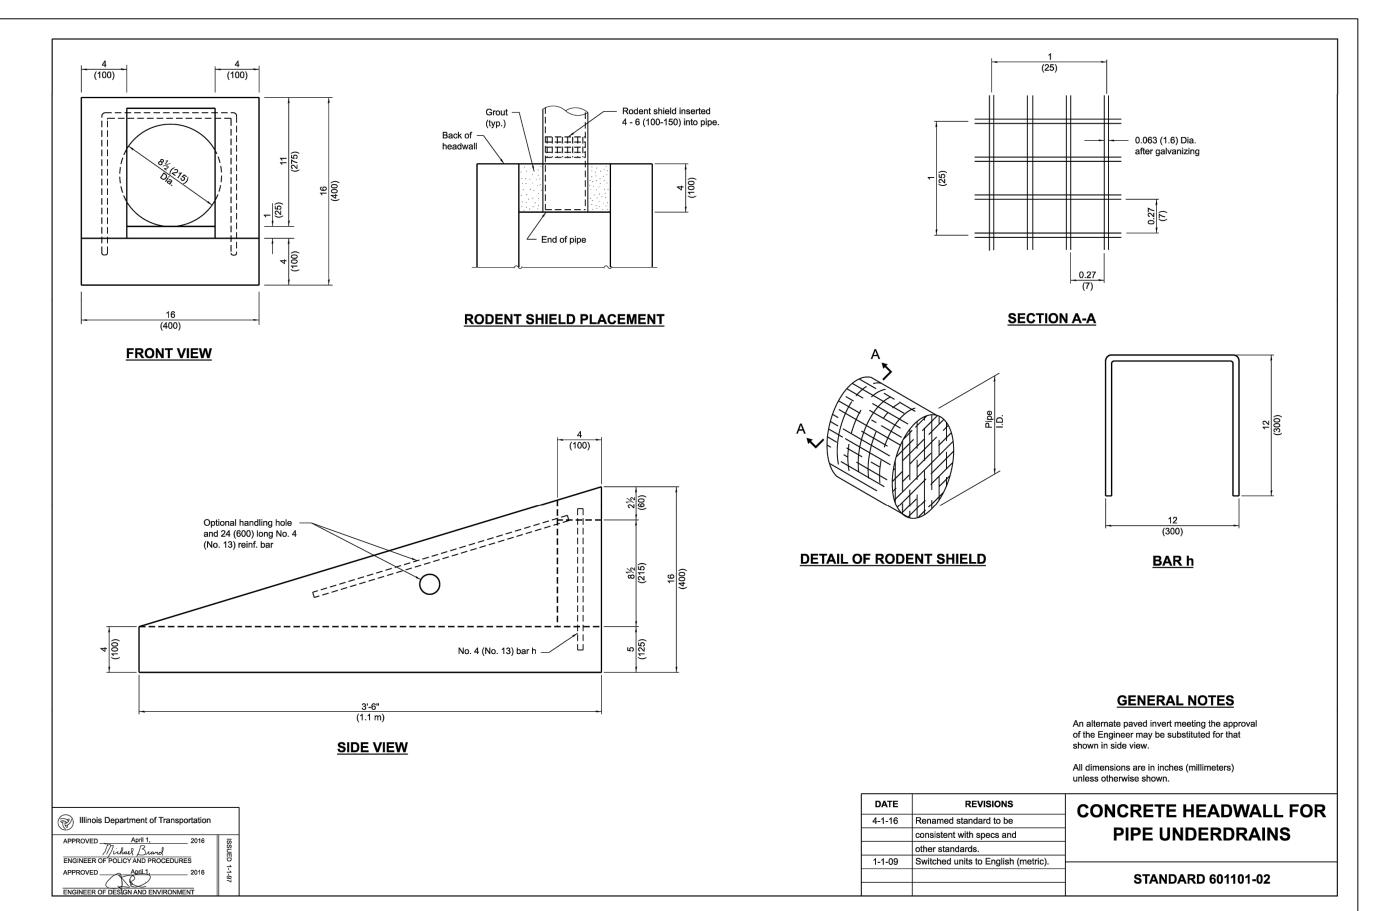
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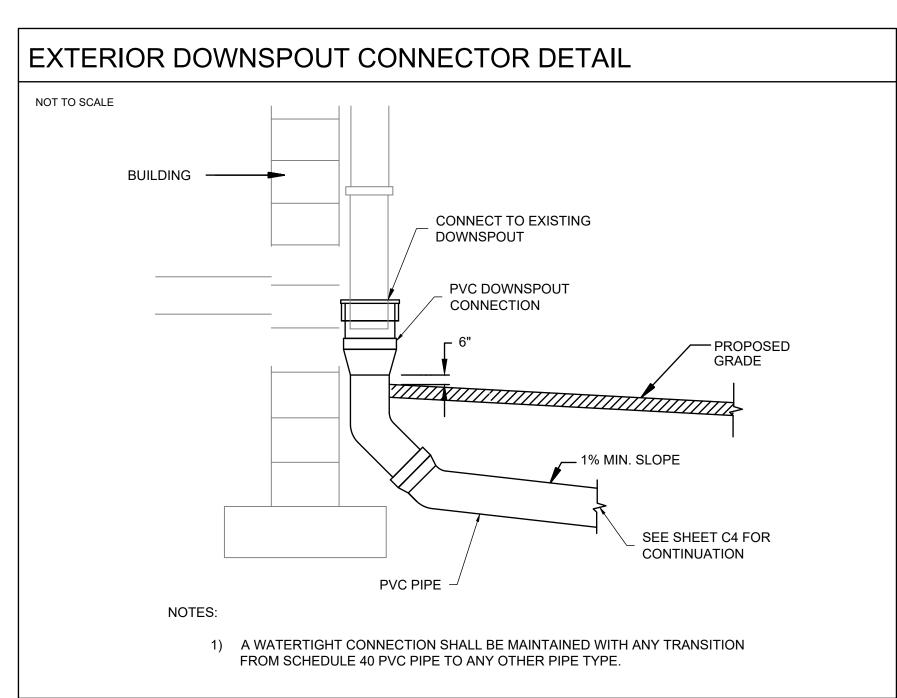
UTILITY PLAN


Ref. North Sheet No.

1: 20







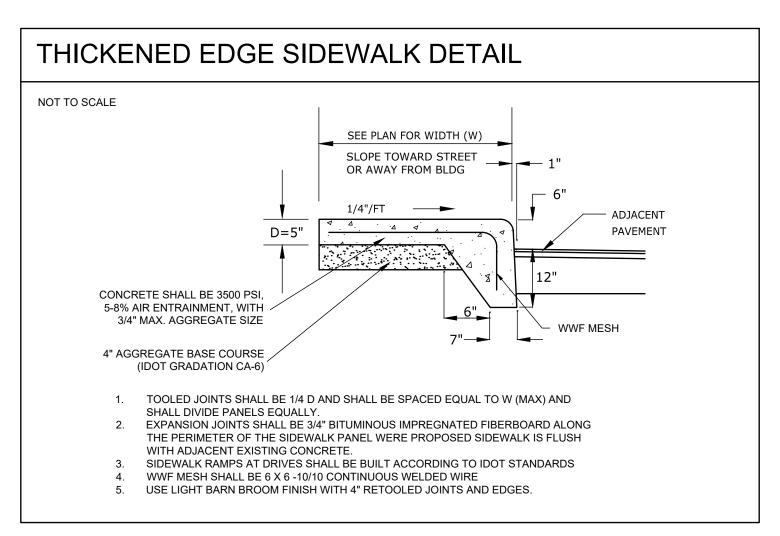

PLANTING SOIL: MIN. OF 3" MUSHROOM


COMPOST ROTOTILLED INTO SOIL TO A


MIN. DEPTH OF 9". DO NOT COMPACT UNNECESSARILY AFTER PLANTING


APPLY 18-6-12 OSMOCOTE (270 DAY) TIMED RELEASED FERTILIZER TO

GROUNDCOVER & PERENNIAL BEDS &


NOT TO SCALE

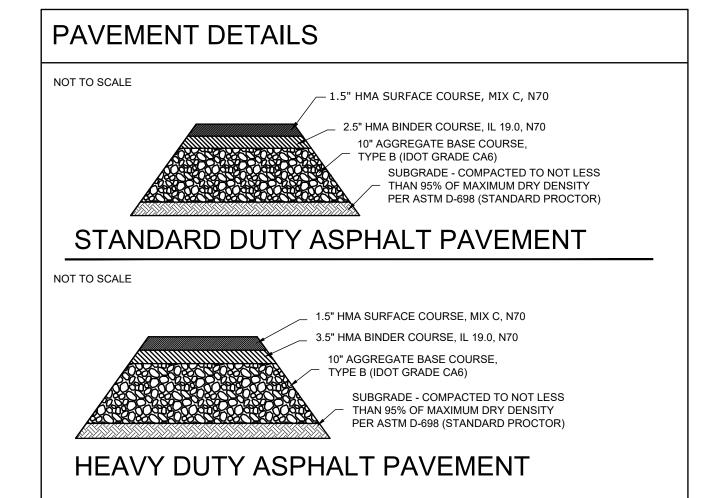

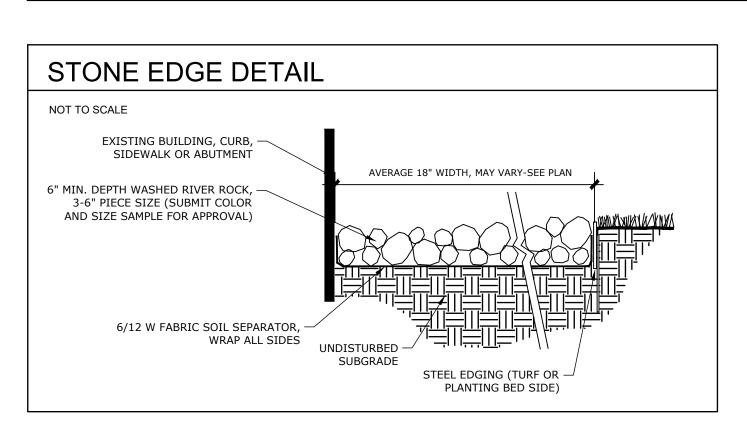

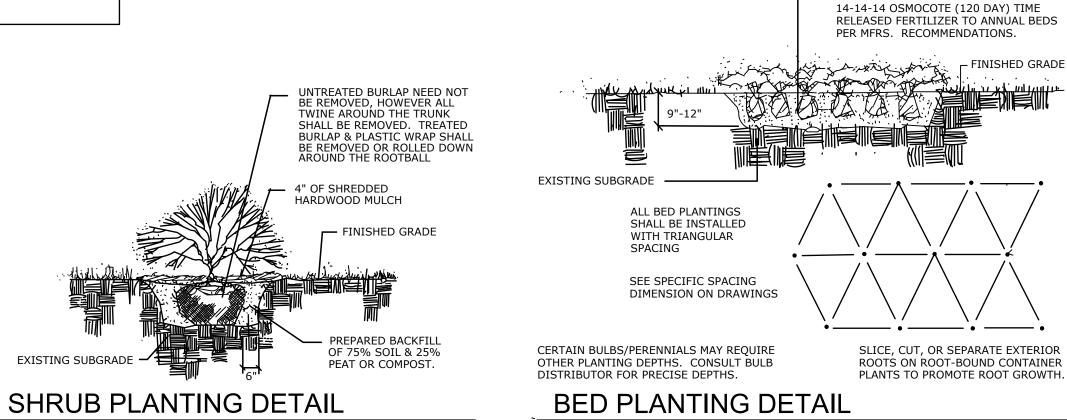

(GROUNDCOVER, PERENNIALS, VINES & ANNUALS)

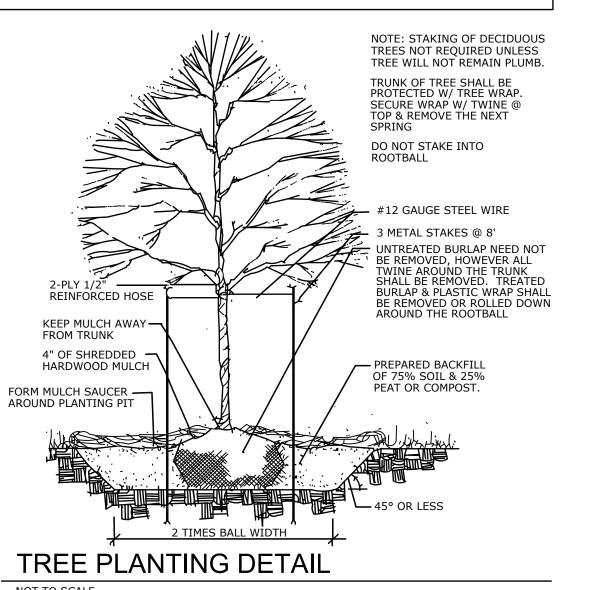



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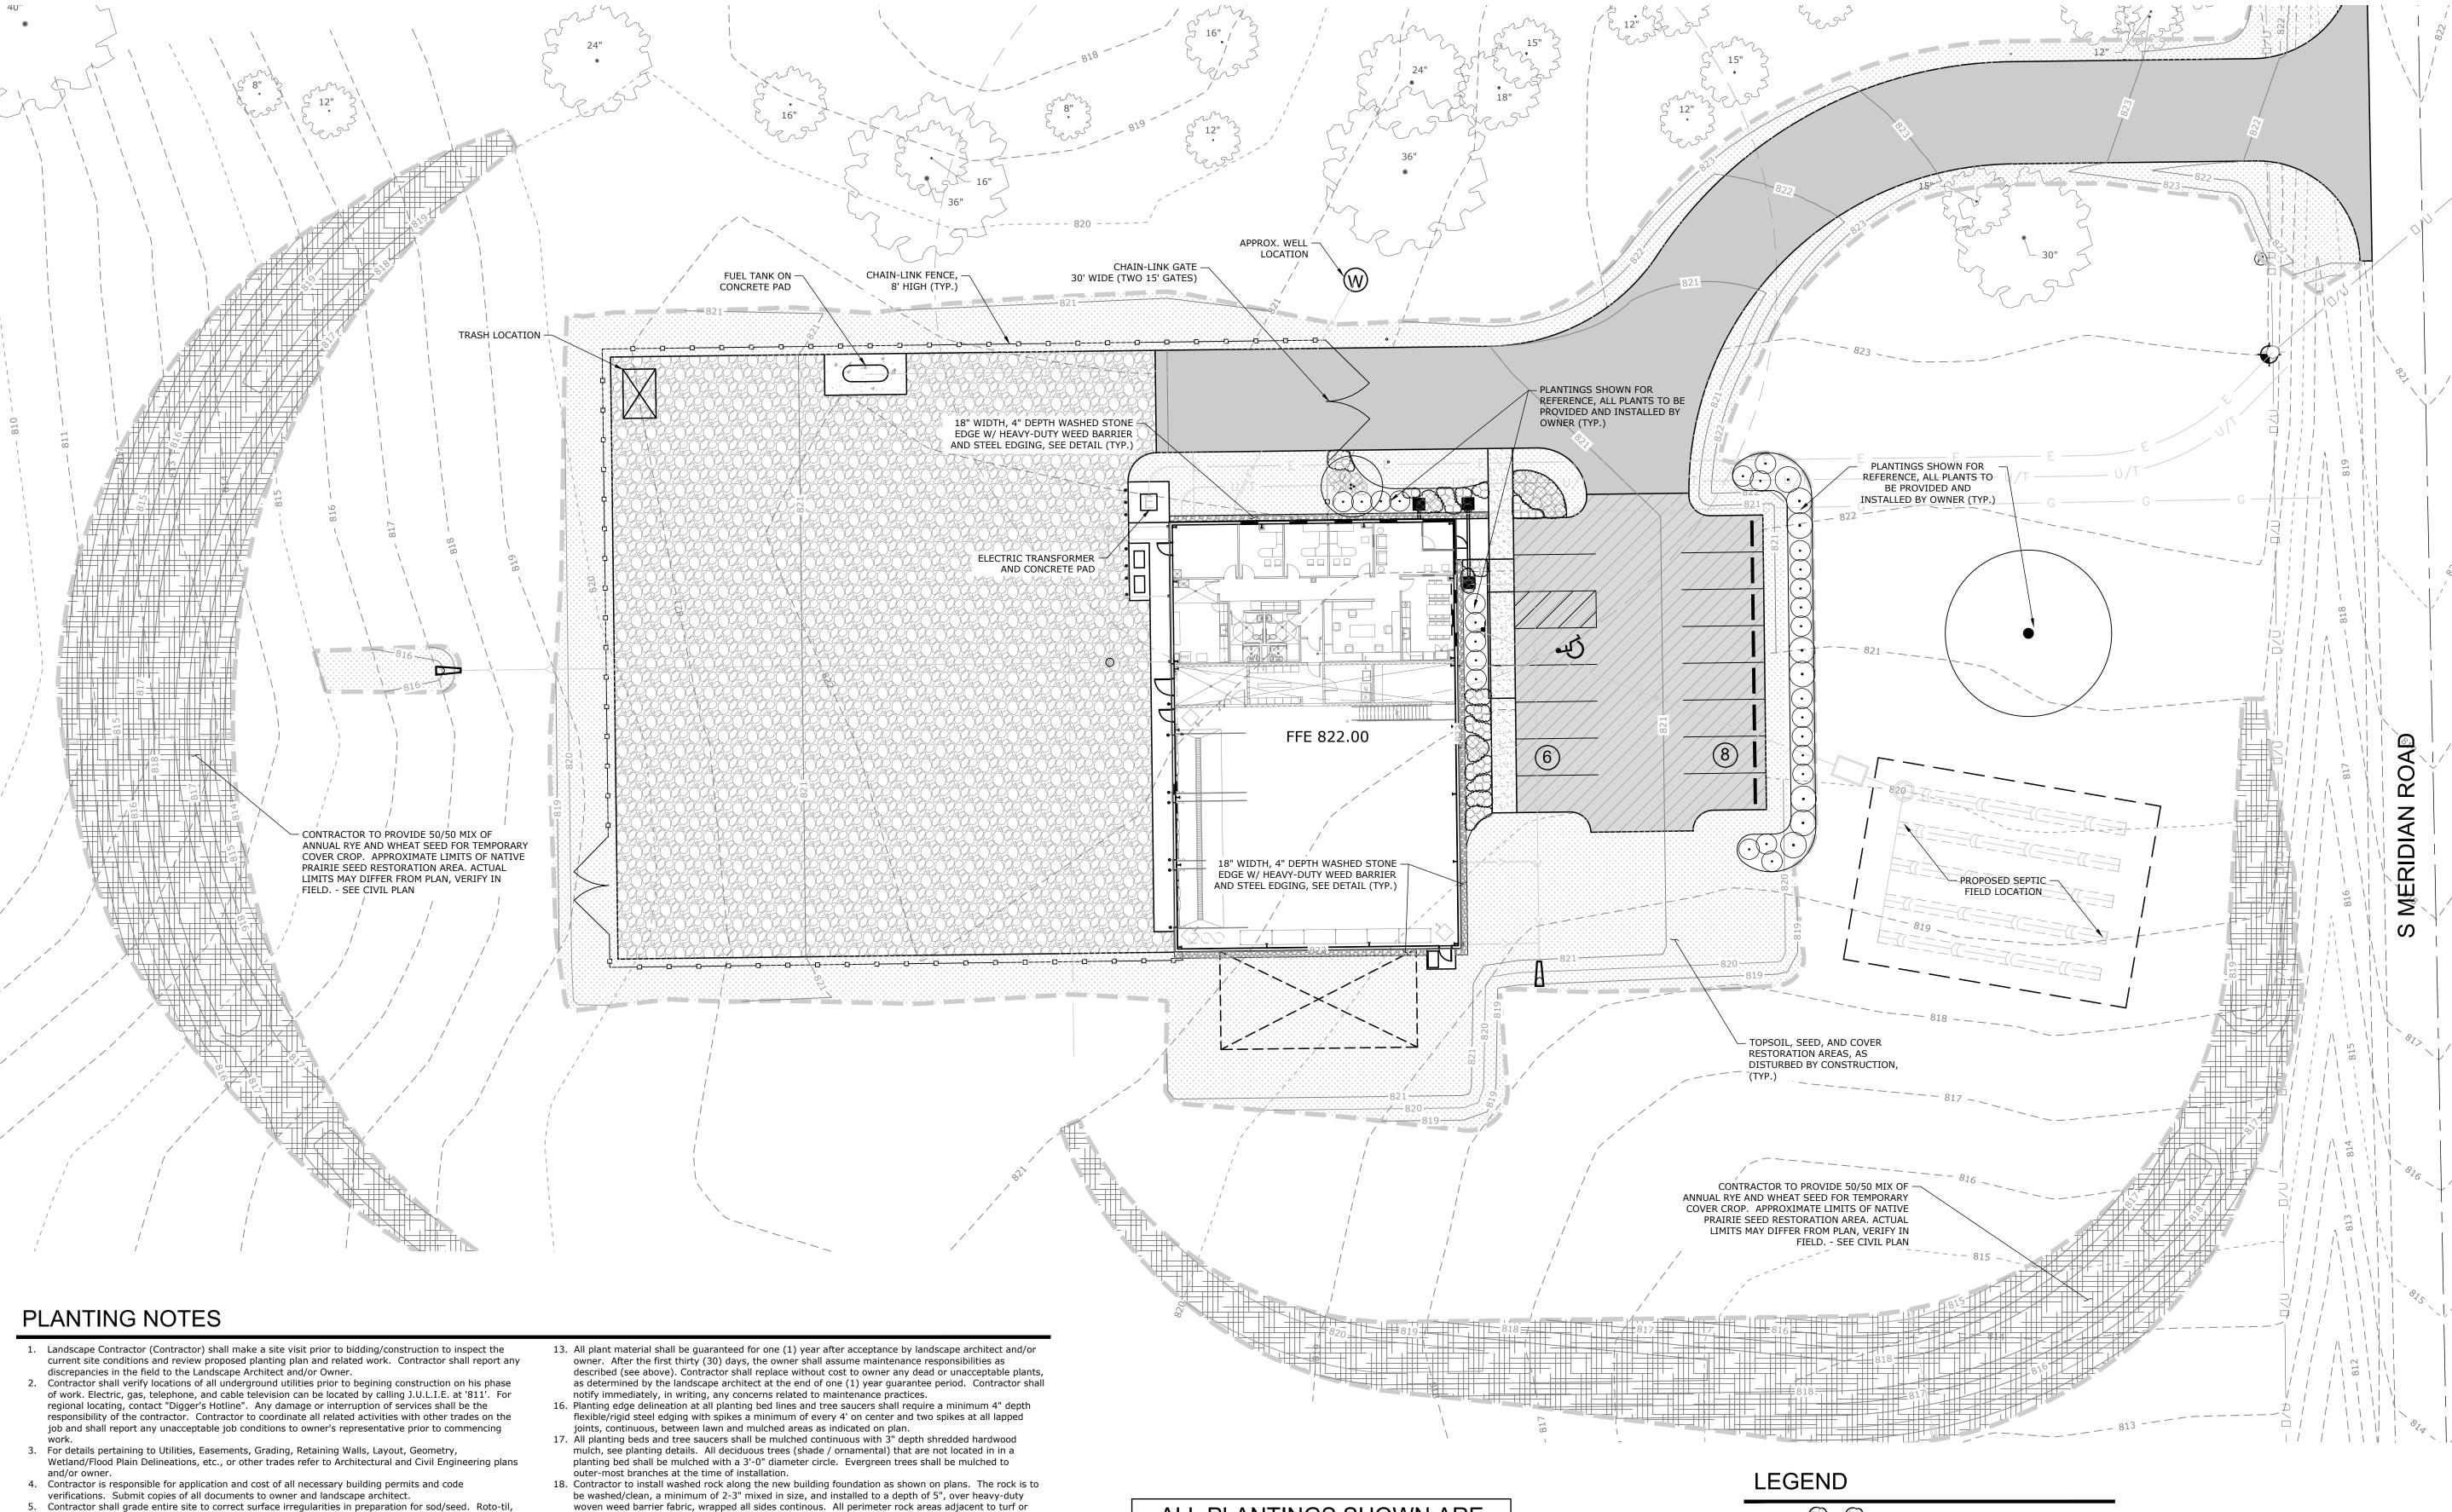
DETAILS

Ref. North

C10

PROFESSIONAL DESIGN FIRM REGISTRATION #

Sheet No.



- 5. Contractor shall grade entire site to correct surface irregularities in preparation for sod/seed. Roto-til, disc, drag, harrow or hand rake sub grade to a depth of 4" in all lawn areas and remove construction debris, foreign matter or stones larger than 2". Grading shall provide slopes which are smooth, continuous, free from depressions or ridges. Level, rake and roll as necessary to an even and true condition and obtain positive drainage in all areas. Finish grades shall meet the approval of owner prior to lawn installation.
- 6. All disturbed areas are to receive minimum 6" of topsoil and be finished with mulch, straw mulch, seed, sod, etc. or as noted. All lawn areas to be watered until a healthy stand of grass is established. (see seed/sod notes for acceptance details).
- 7. Quantity lists are supplied as a convenience; however, the contractor should verify all quantities. The drawings shall take precedence over the lists.
- 8. Plantings may need to be adjusted in the field to accommodate utilities, easements, drainage ways, downspouts, etc.; however, quantities and sizes shall remain consistent with these plans.
- 9. Size & grading standards of plant material shall conform to the latest addition of ANSI Z60.1 AMERICAN STANDARD OF NURSERY STOCK, by the American Nursery & Landscape Association. Plant material
- shall be nursery grown and be either balled and burlap or container grown.
 10. All plant species specified are subject to availability. Material shortages in the landscape industry may require substitutions. All substitutions must be approved by the Landscape Architect and/or Owner.
 11. Any plant materials with damaged or crooked/disfigured leaders, bark abrasion, sun scald, insect damage, etc. are not acceptable and will be rejected by Landscape Architect and/or Owner. Trees with
- multiple leaders will be rejected unless called for in the plant list as multi-stem or clump.


 12. Upon inspection and acceptance of all landscape items by Landscape Architect and/or Owner the contractor shall assume maintenance responsibilities for a period of thirty (30) days, for all plant material, to include: watering, cultivating, weeding, pruning, mulching and spraying as necessary to keep plants free of insects and in a healthy, vigorous condition until responsibility is transferred to the owner (see below).
- be washed/clean, a minimum of 2-3" mixed in size, and installed to a depth of 5", over heavy-duty woven weed barrier fabric, wrapped all sides continous. All perimeter rock areas adjacent to turf or planting beds are to be edged with 4" steel edging with metal stakes a maximum of 4'-0" on-center.


 19. Contractor to seed all general disturbed lawn areas as indicated on plan. Seed mix shall be IDOT Class 1 seed mix, or approved equal. Seed mix to be a combination of bluegrass, perennial rye and red fescue with the suggested following analysis by weight: 30% rugby Kentucky bluegrass, 20% park Kentucky bluegrass, 20% creeping red fescue, 20% scaldis hard fescue, and 10% perennial ryegrass. Seed to be applied at a rate of 4 lbs. per 1,000 s.f.. All seeded lawn areas shall be covered with straw mulch or erosion control netting (netting only necessary for sloped or depressed areas), consisting of hand or machine application at a rate of 2 ton per acre. Mulch shall be compact enough to reduce


erosion of seed and topsoil but loose enough to allow air to circulate. Install per Method 1, Section

- 251, of the Standard Specifications for Road and Bridge Construction.20. Contractor to seed all future native areas (approximate) as noted on plans with a 50/50 mix of annual rye and wheat seed for temporary cover crop. Owner to provide and install final native prairie or other
- 21. Acceptance of grading and seed shall be by landscape architect and/or owner. Contractor shall assume maintenance responsibilities for a minimum of sixty (60) days or until second cutting, whichever is longer. Maintenance shall include watering, weeding, re-seeding (wash-offs), replacement (sod) and other operations necessary to keep lawn in a thriving condition. Upon final acceptance, owner shall assume all maintenance responsibilities. After lawn areas have germinated, areas which fail to show a uniform stand of grass for any reason whatsoever shall be re-seeded or replaced repeatedly until all areas are covered with a satisfactory stand of grass. Minimum acceptance of seeded lawn areas may include scattered bare or dead spots, none of which are larger than one (1) square foot and when combined do not exceed 2% of total lawn area.

ALL PLANTINGS SHOWN ARE
FOR REFRENCE, OWNER TO
SELF-PERFORM PLANT
SELECTIONS AND
INSTALLATION, TYP.

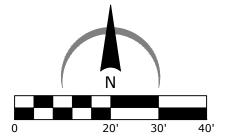

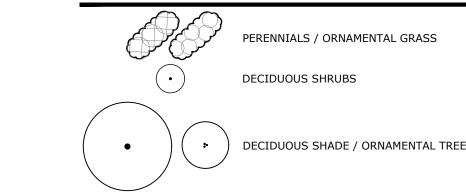

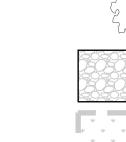

4" DEPTH (WIDTH VARIES) WASHED STONE AREAS W/ HEAVY-DUTY WEED BARRIER AND STEEL EDGING, PER DETAIL

EXISTING TREE

IDOT CLASS 1 SEED MIX - FOR ALL GENERAL DISTURBED AREAS WITHIN P.L. AND ROW UNLESS OTHERWISE DIRECTED BY OWNER

50/50 SEED MIX OF ANNUAL RYE AND WHEAT FOR TEMPORARY COVER CROP. APPROXIMATE AREAS, VERIFY IN FIELD



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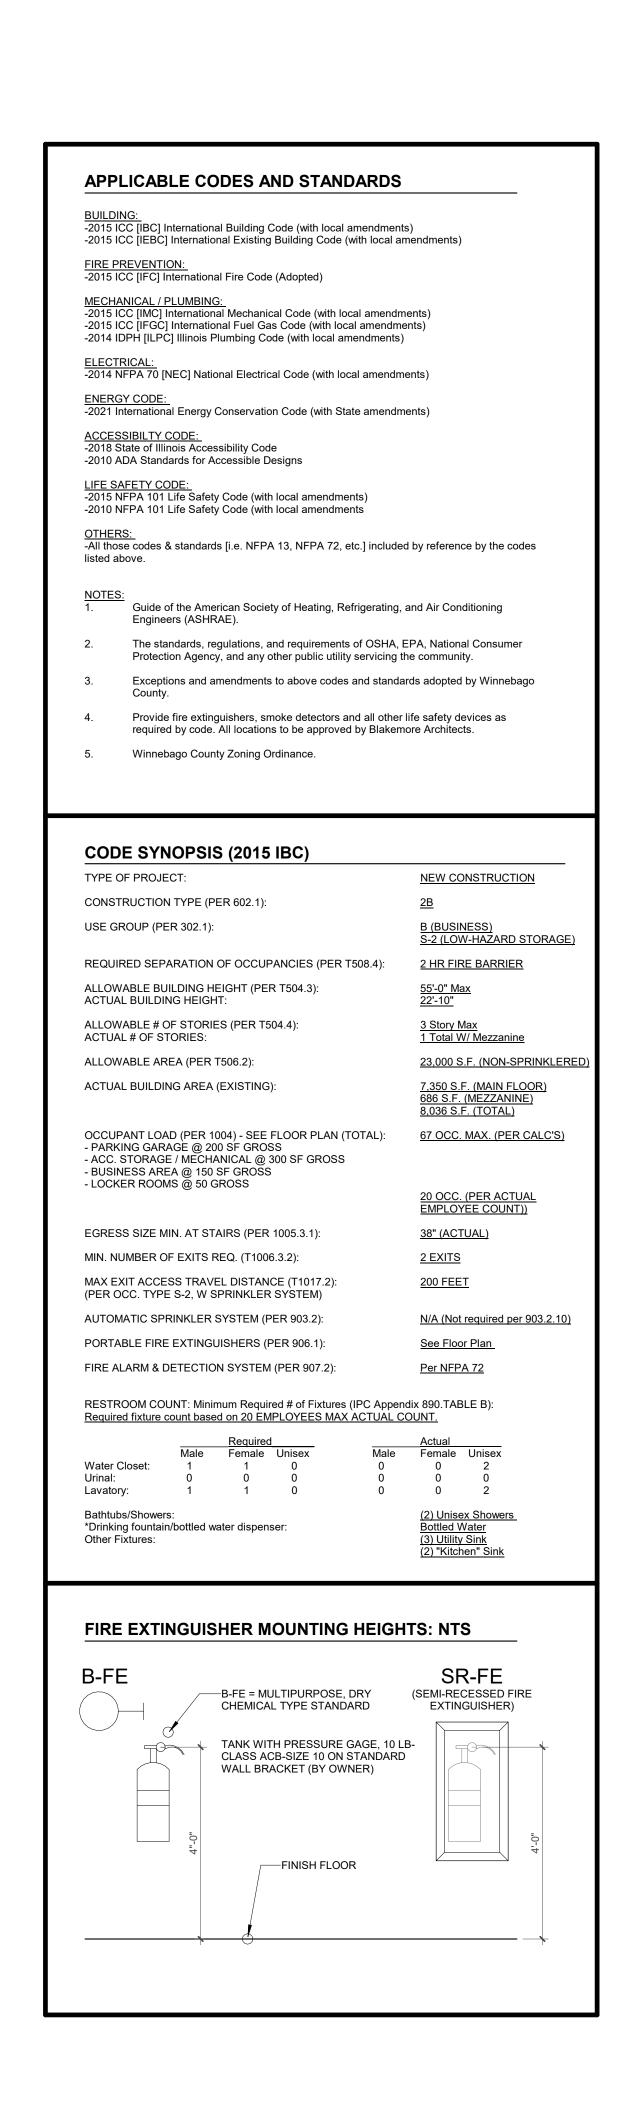
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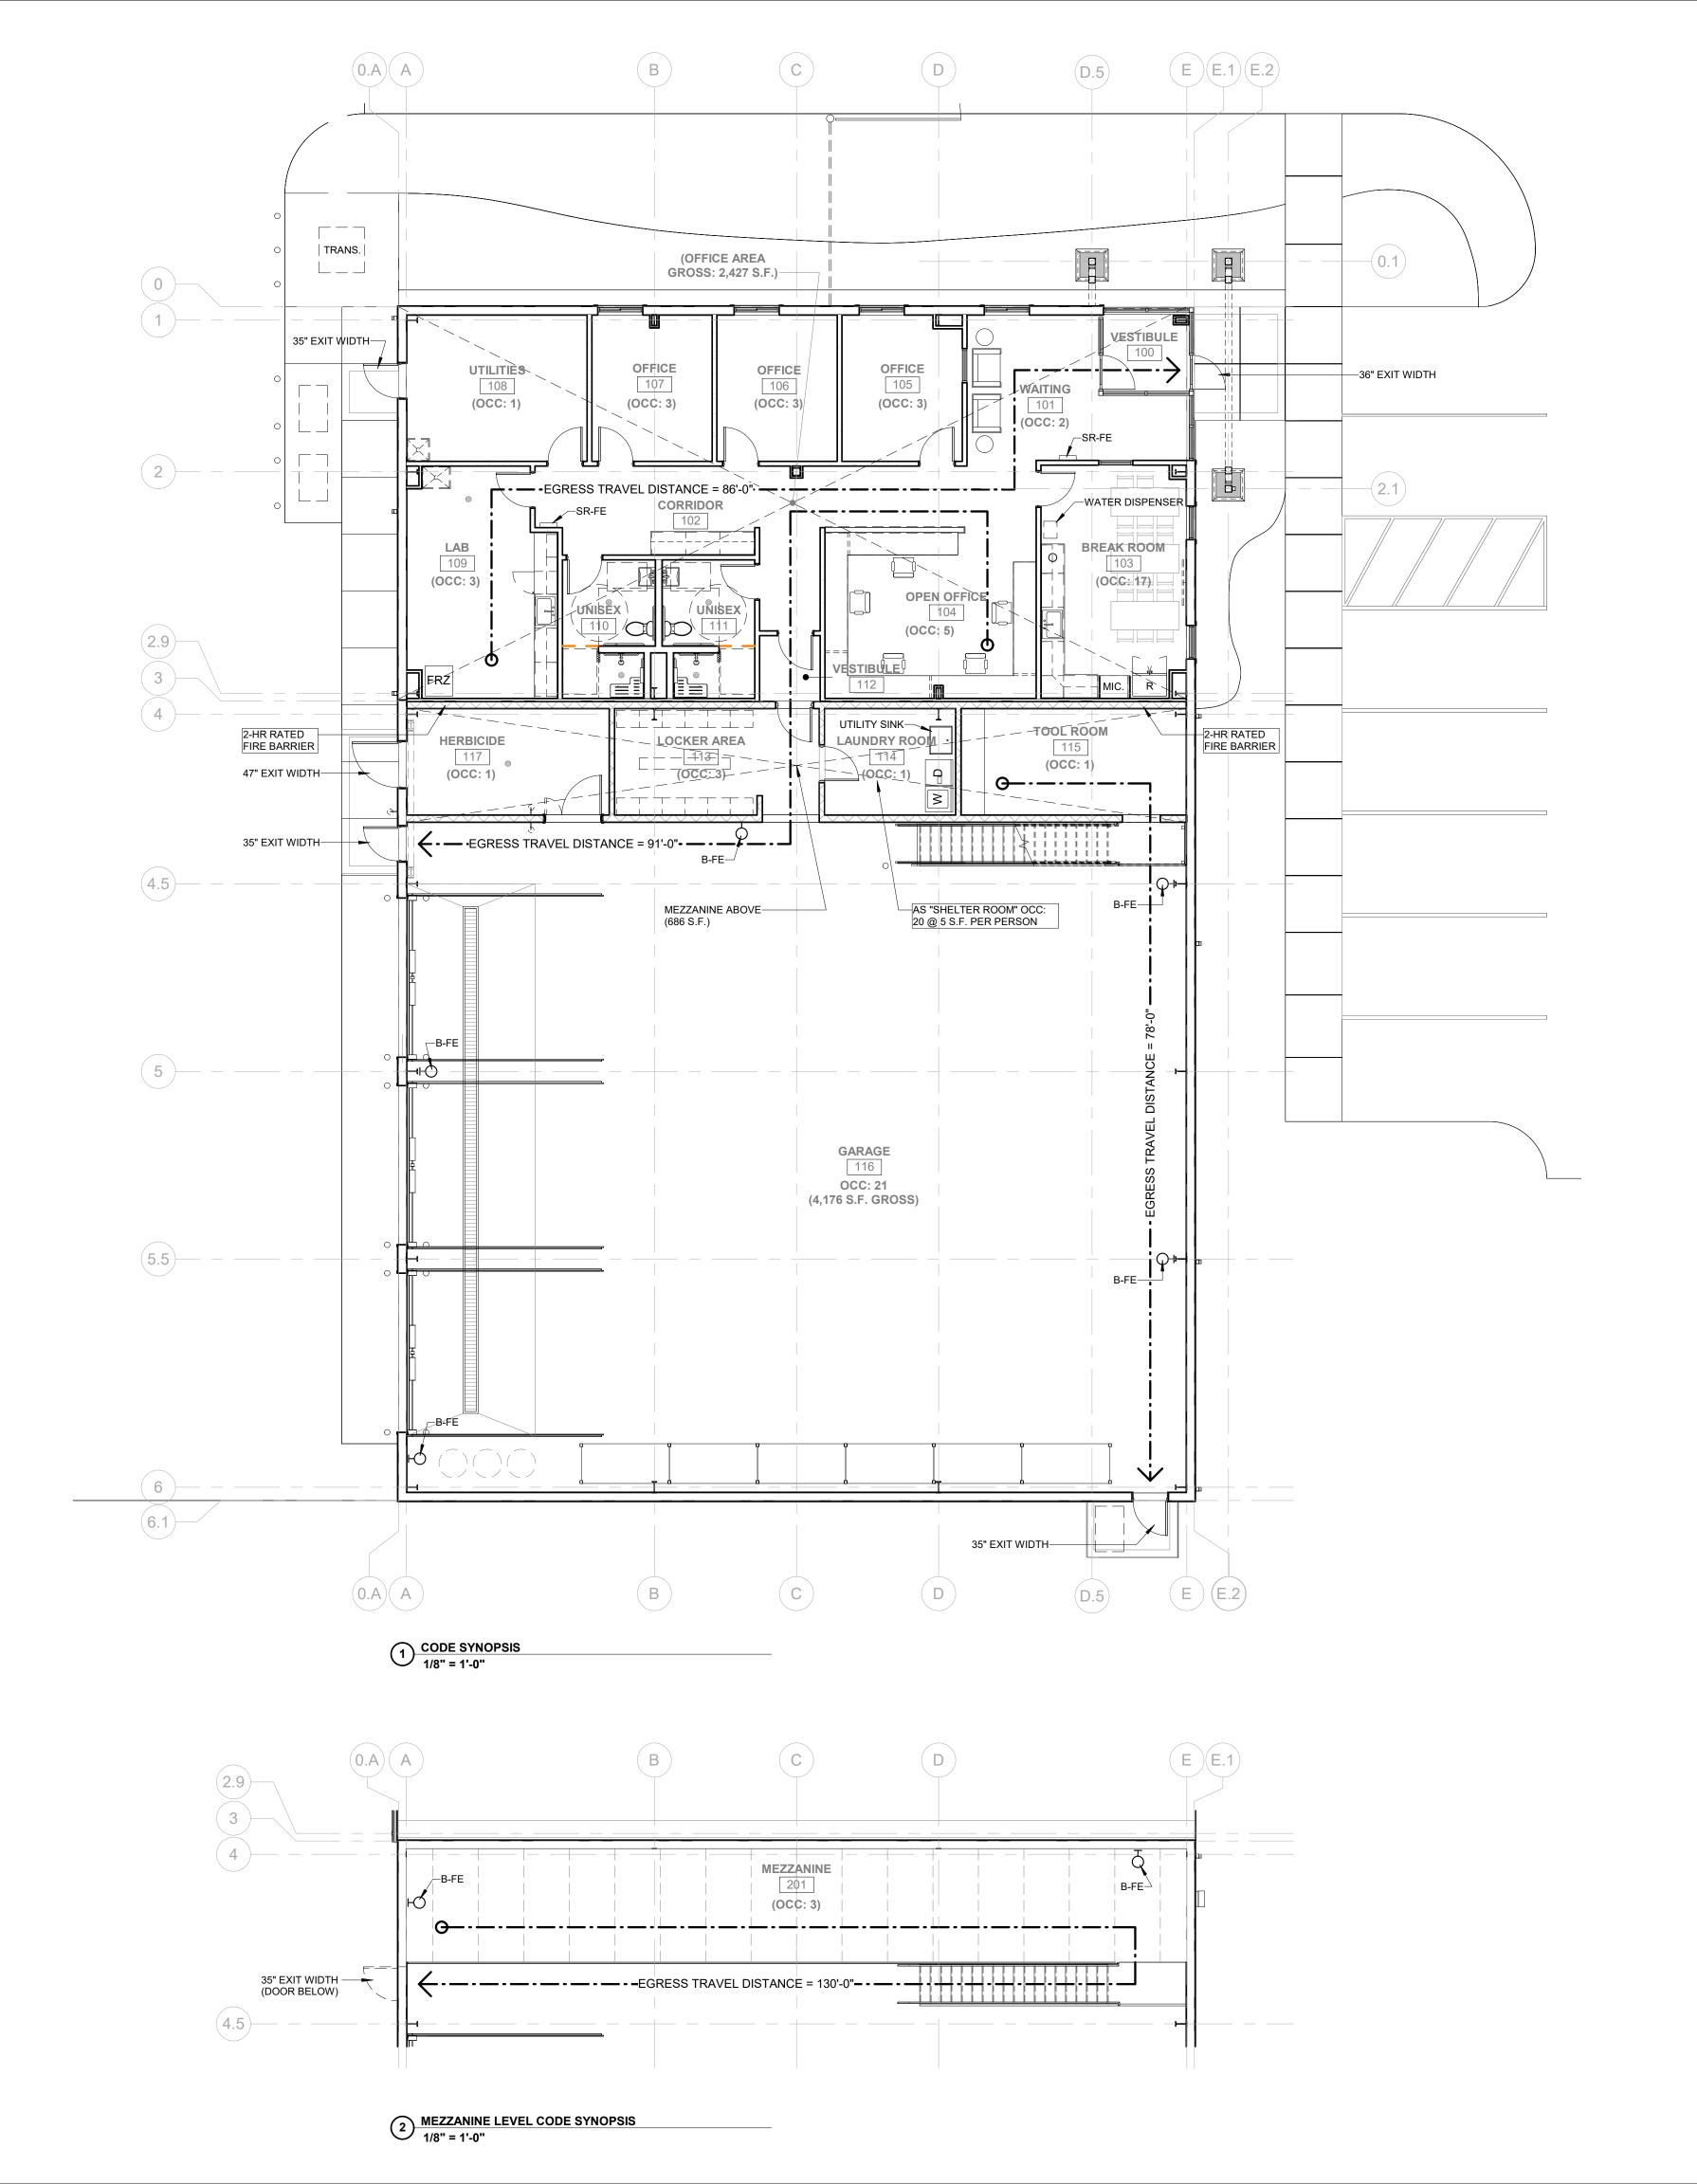
Scale

Sheet Title

LANDSCAPE PLAN

Ref. North Sheet No.







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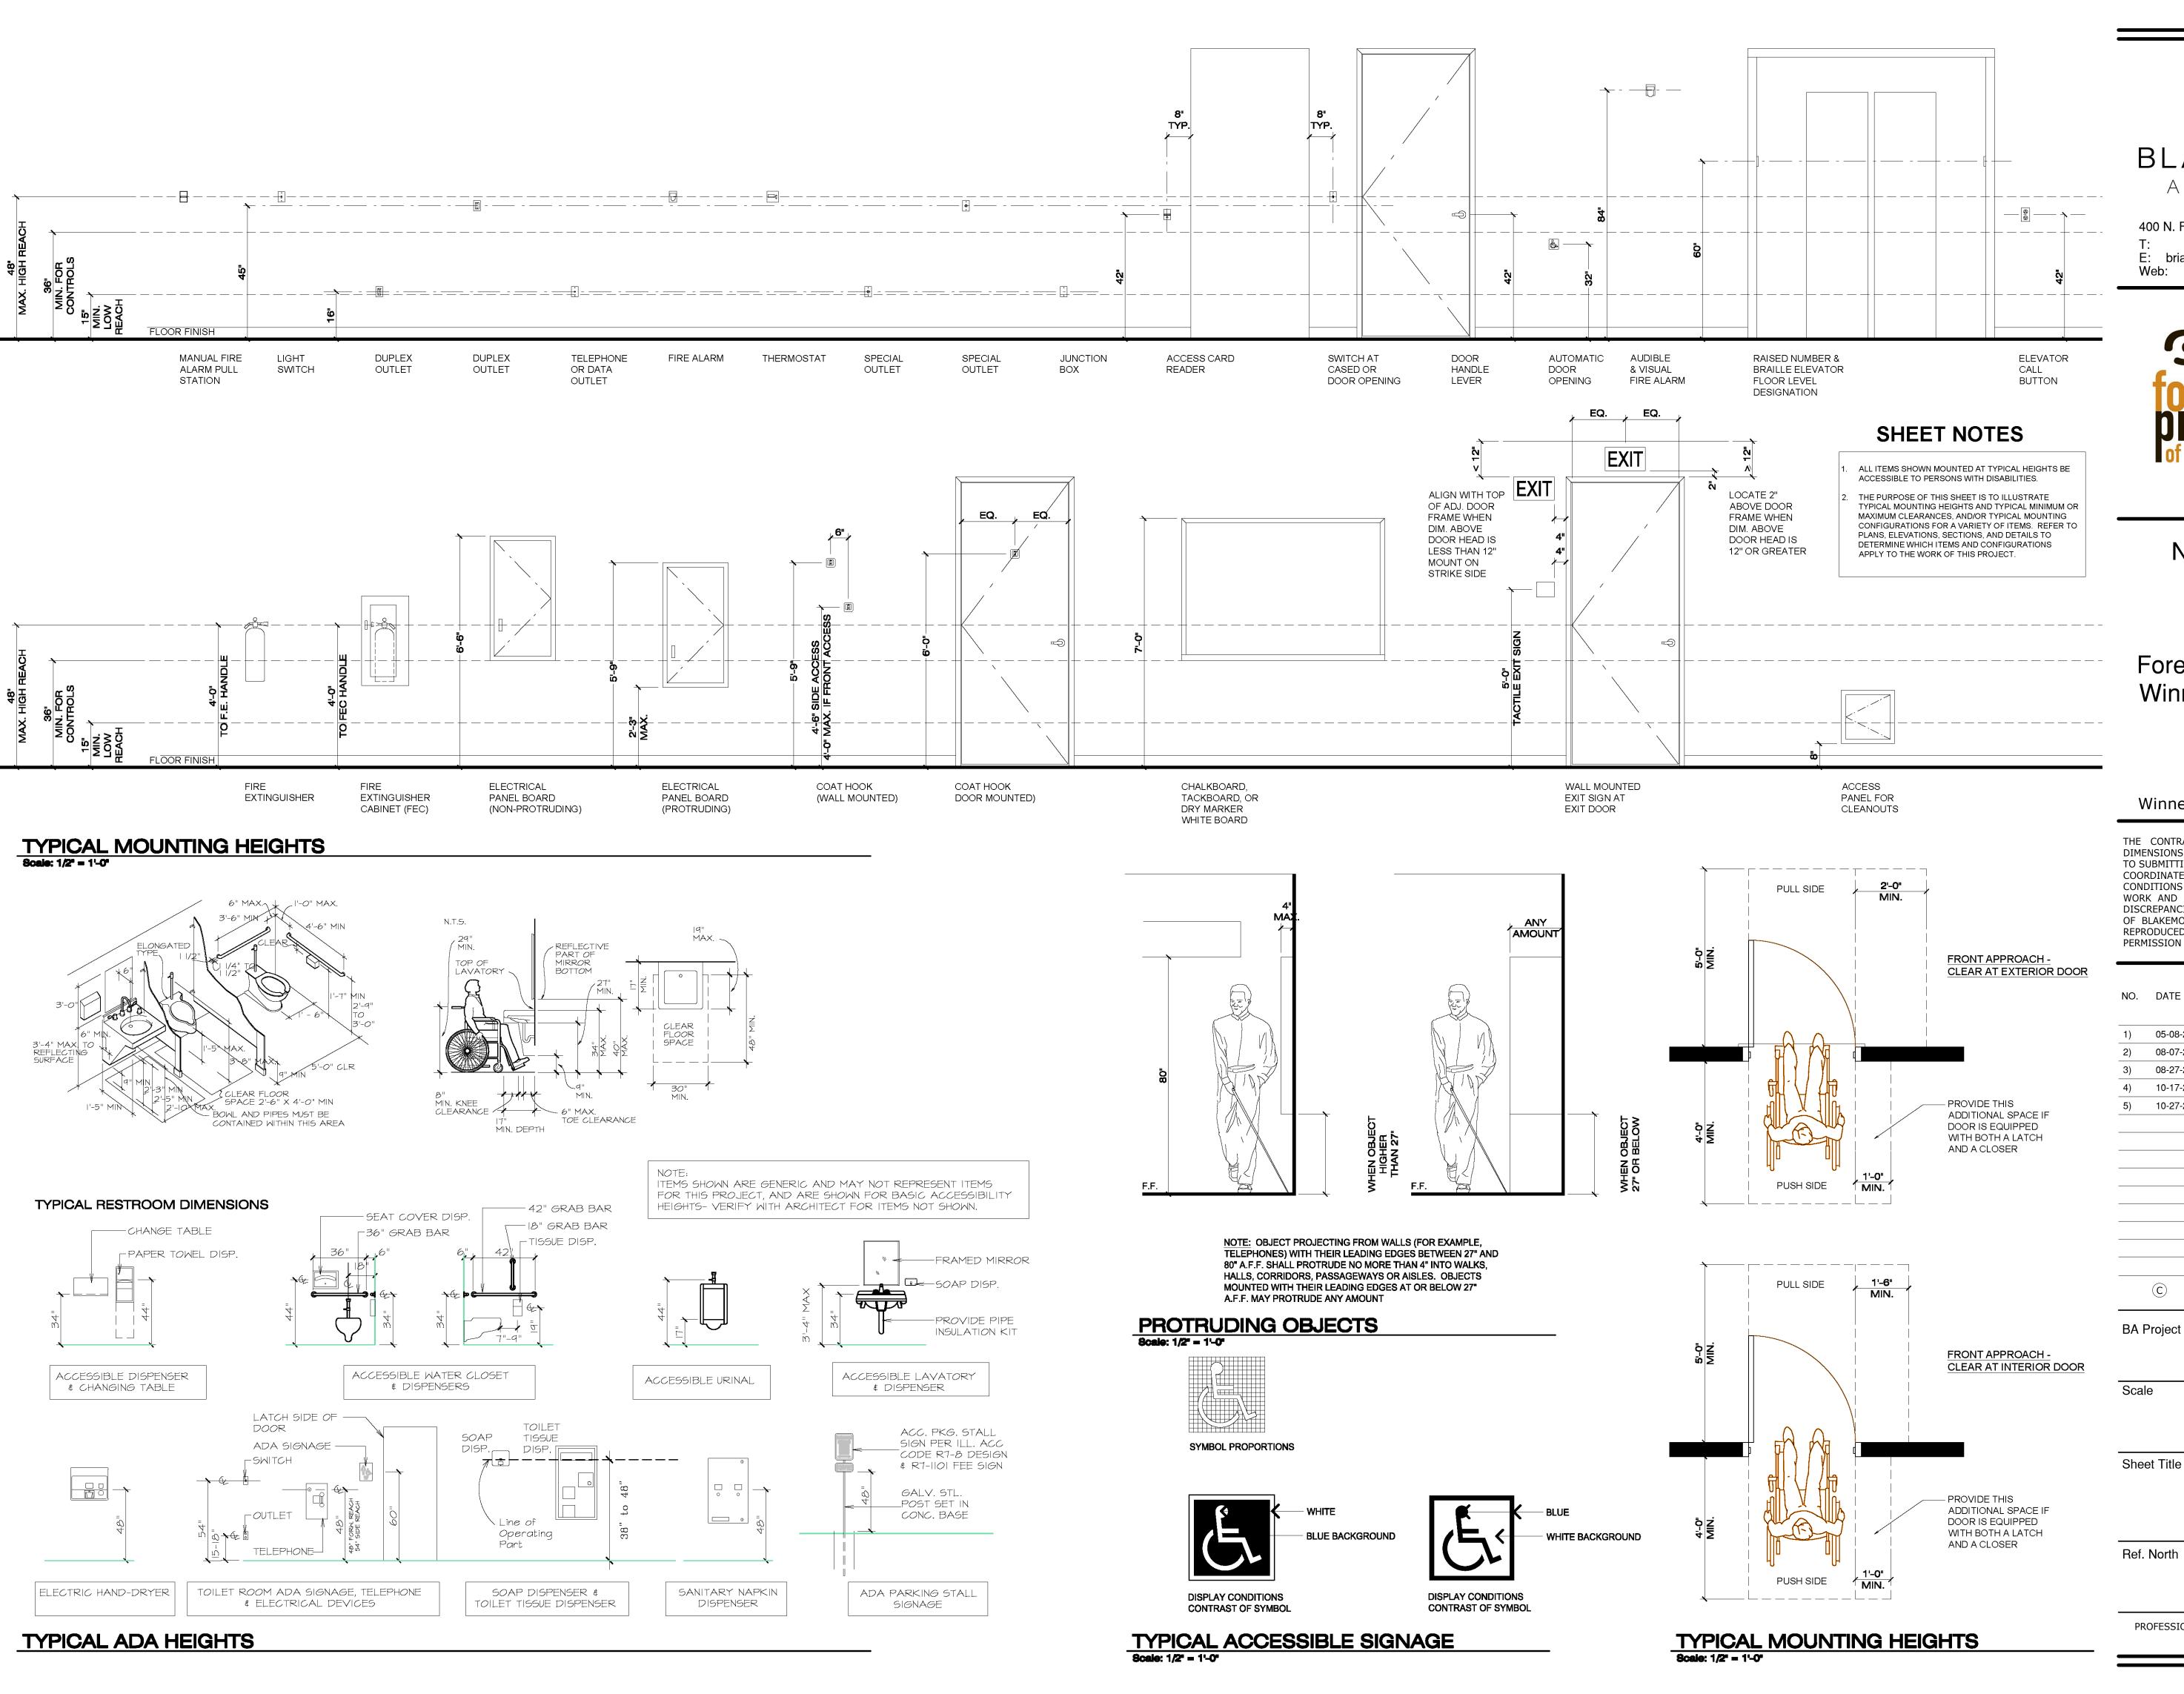
2025-09

Sheet Title

CODE SYNOPSIS

Ref. North

Sheet No. CODE 1



BLAKEMORE ARCHITECTS

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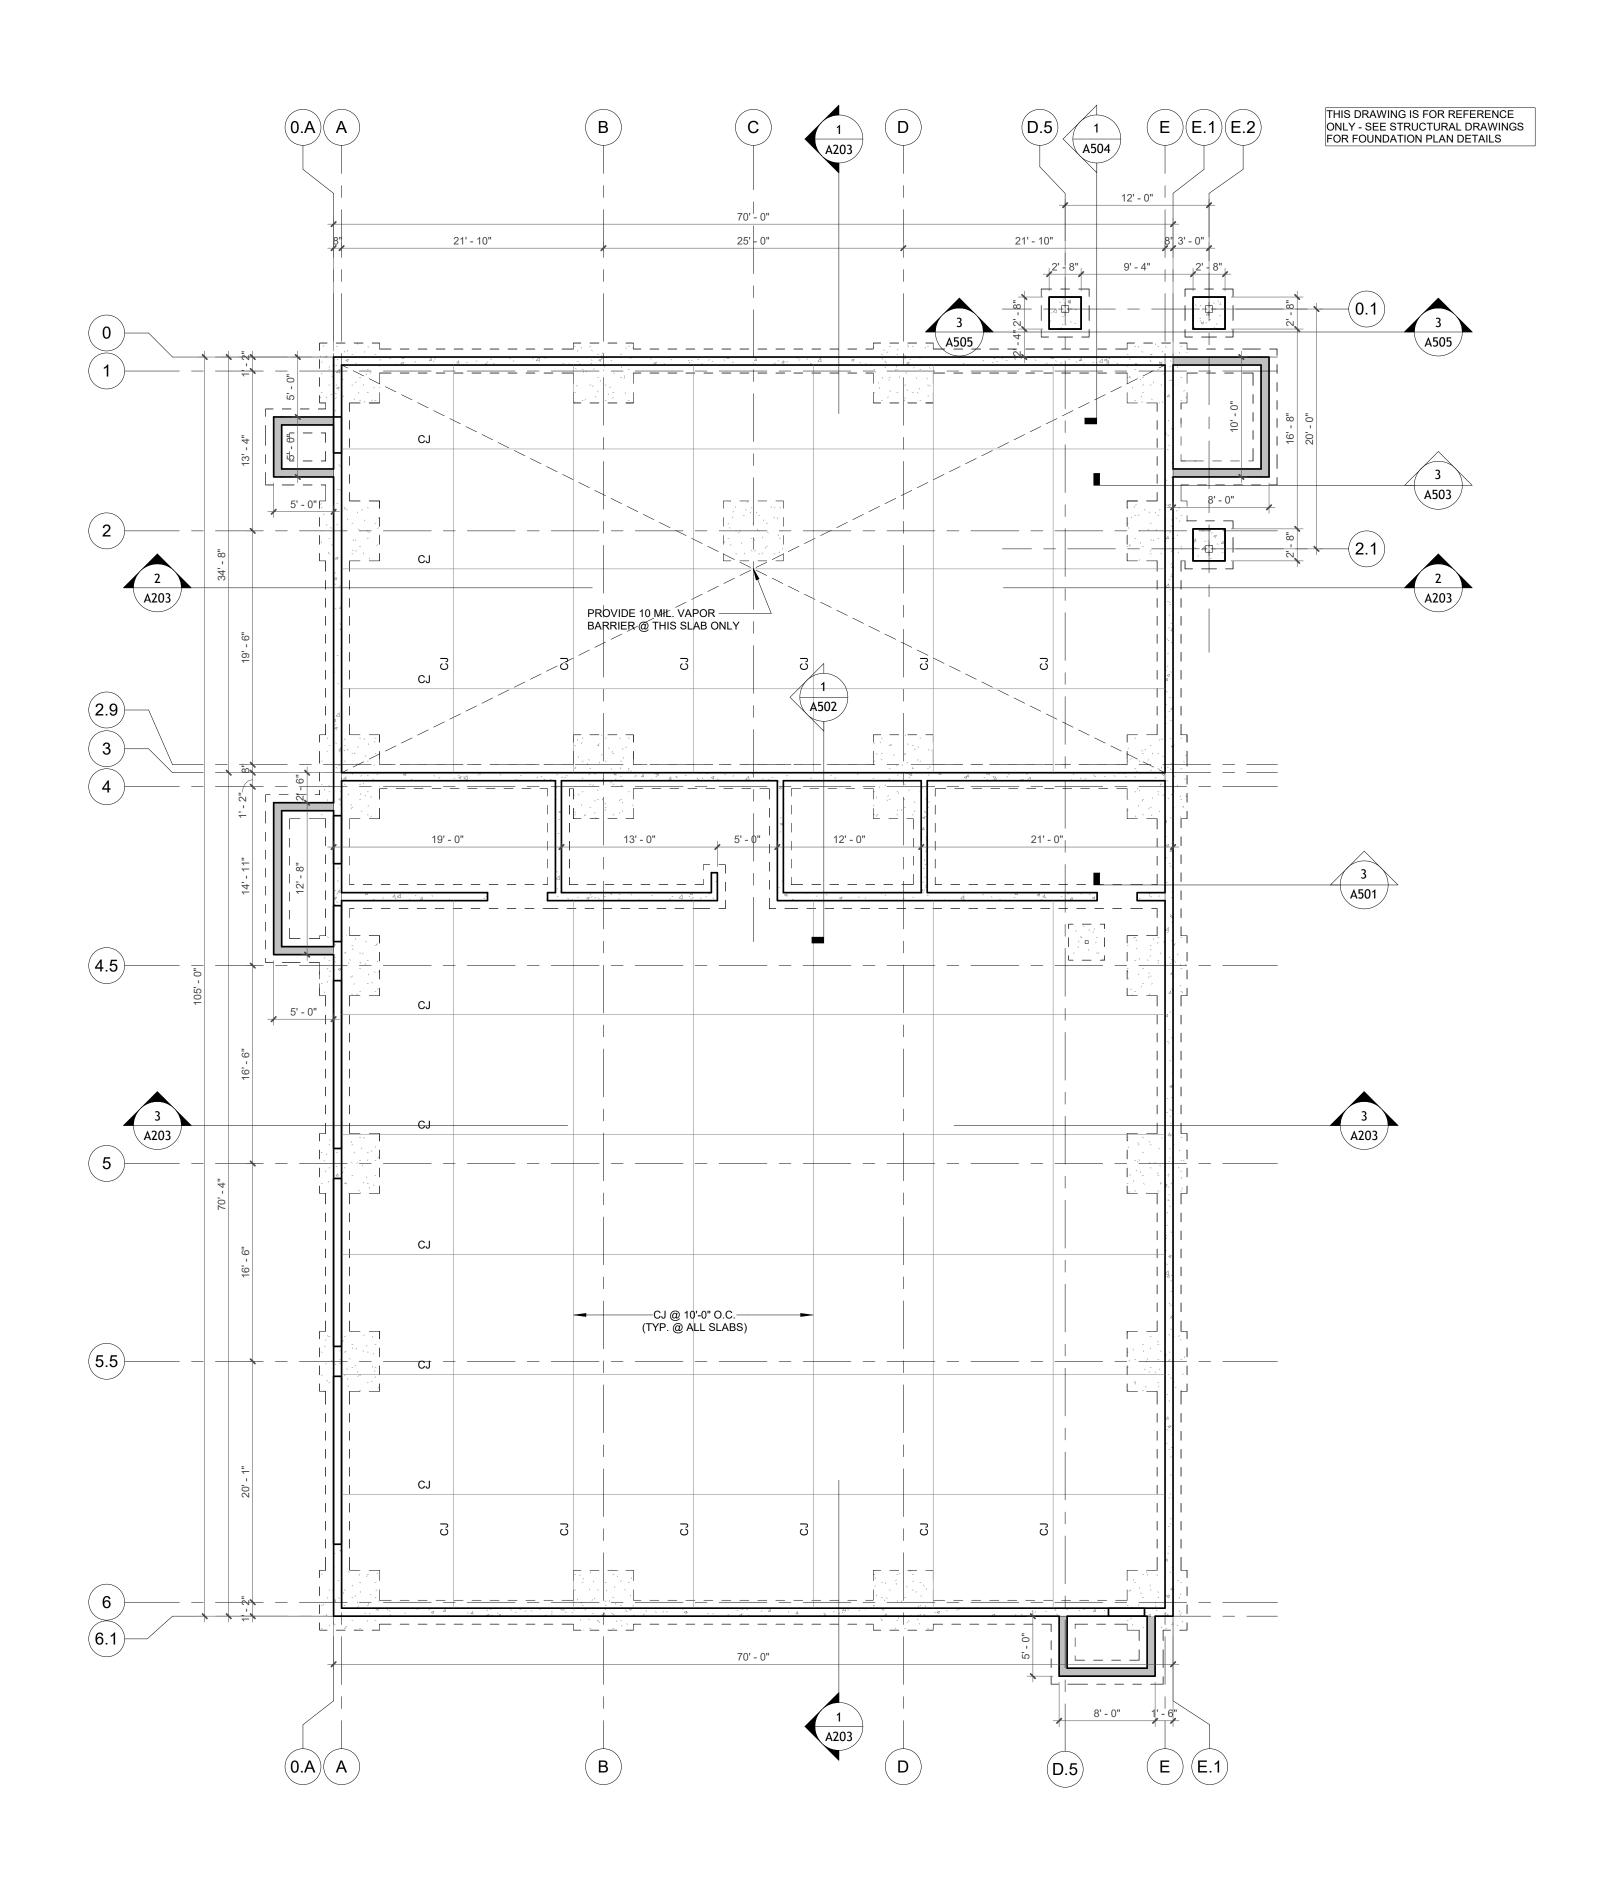
ADA STANDARDS

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CODE 2

Sheet No.

2025-09



1/8" = 1'-0"



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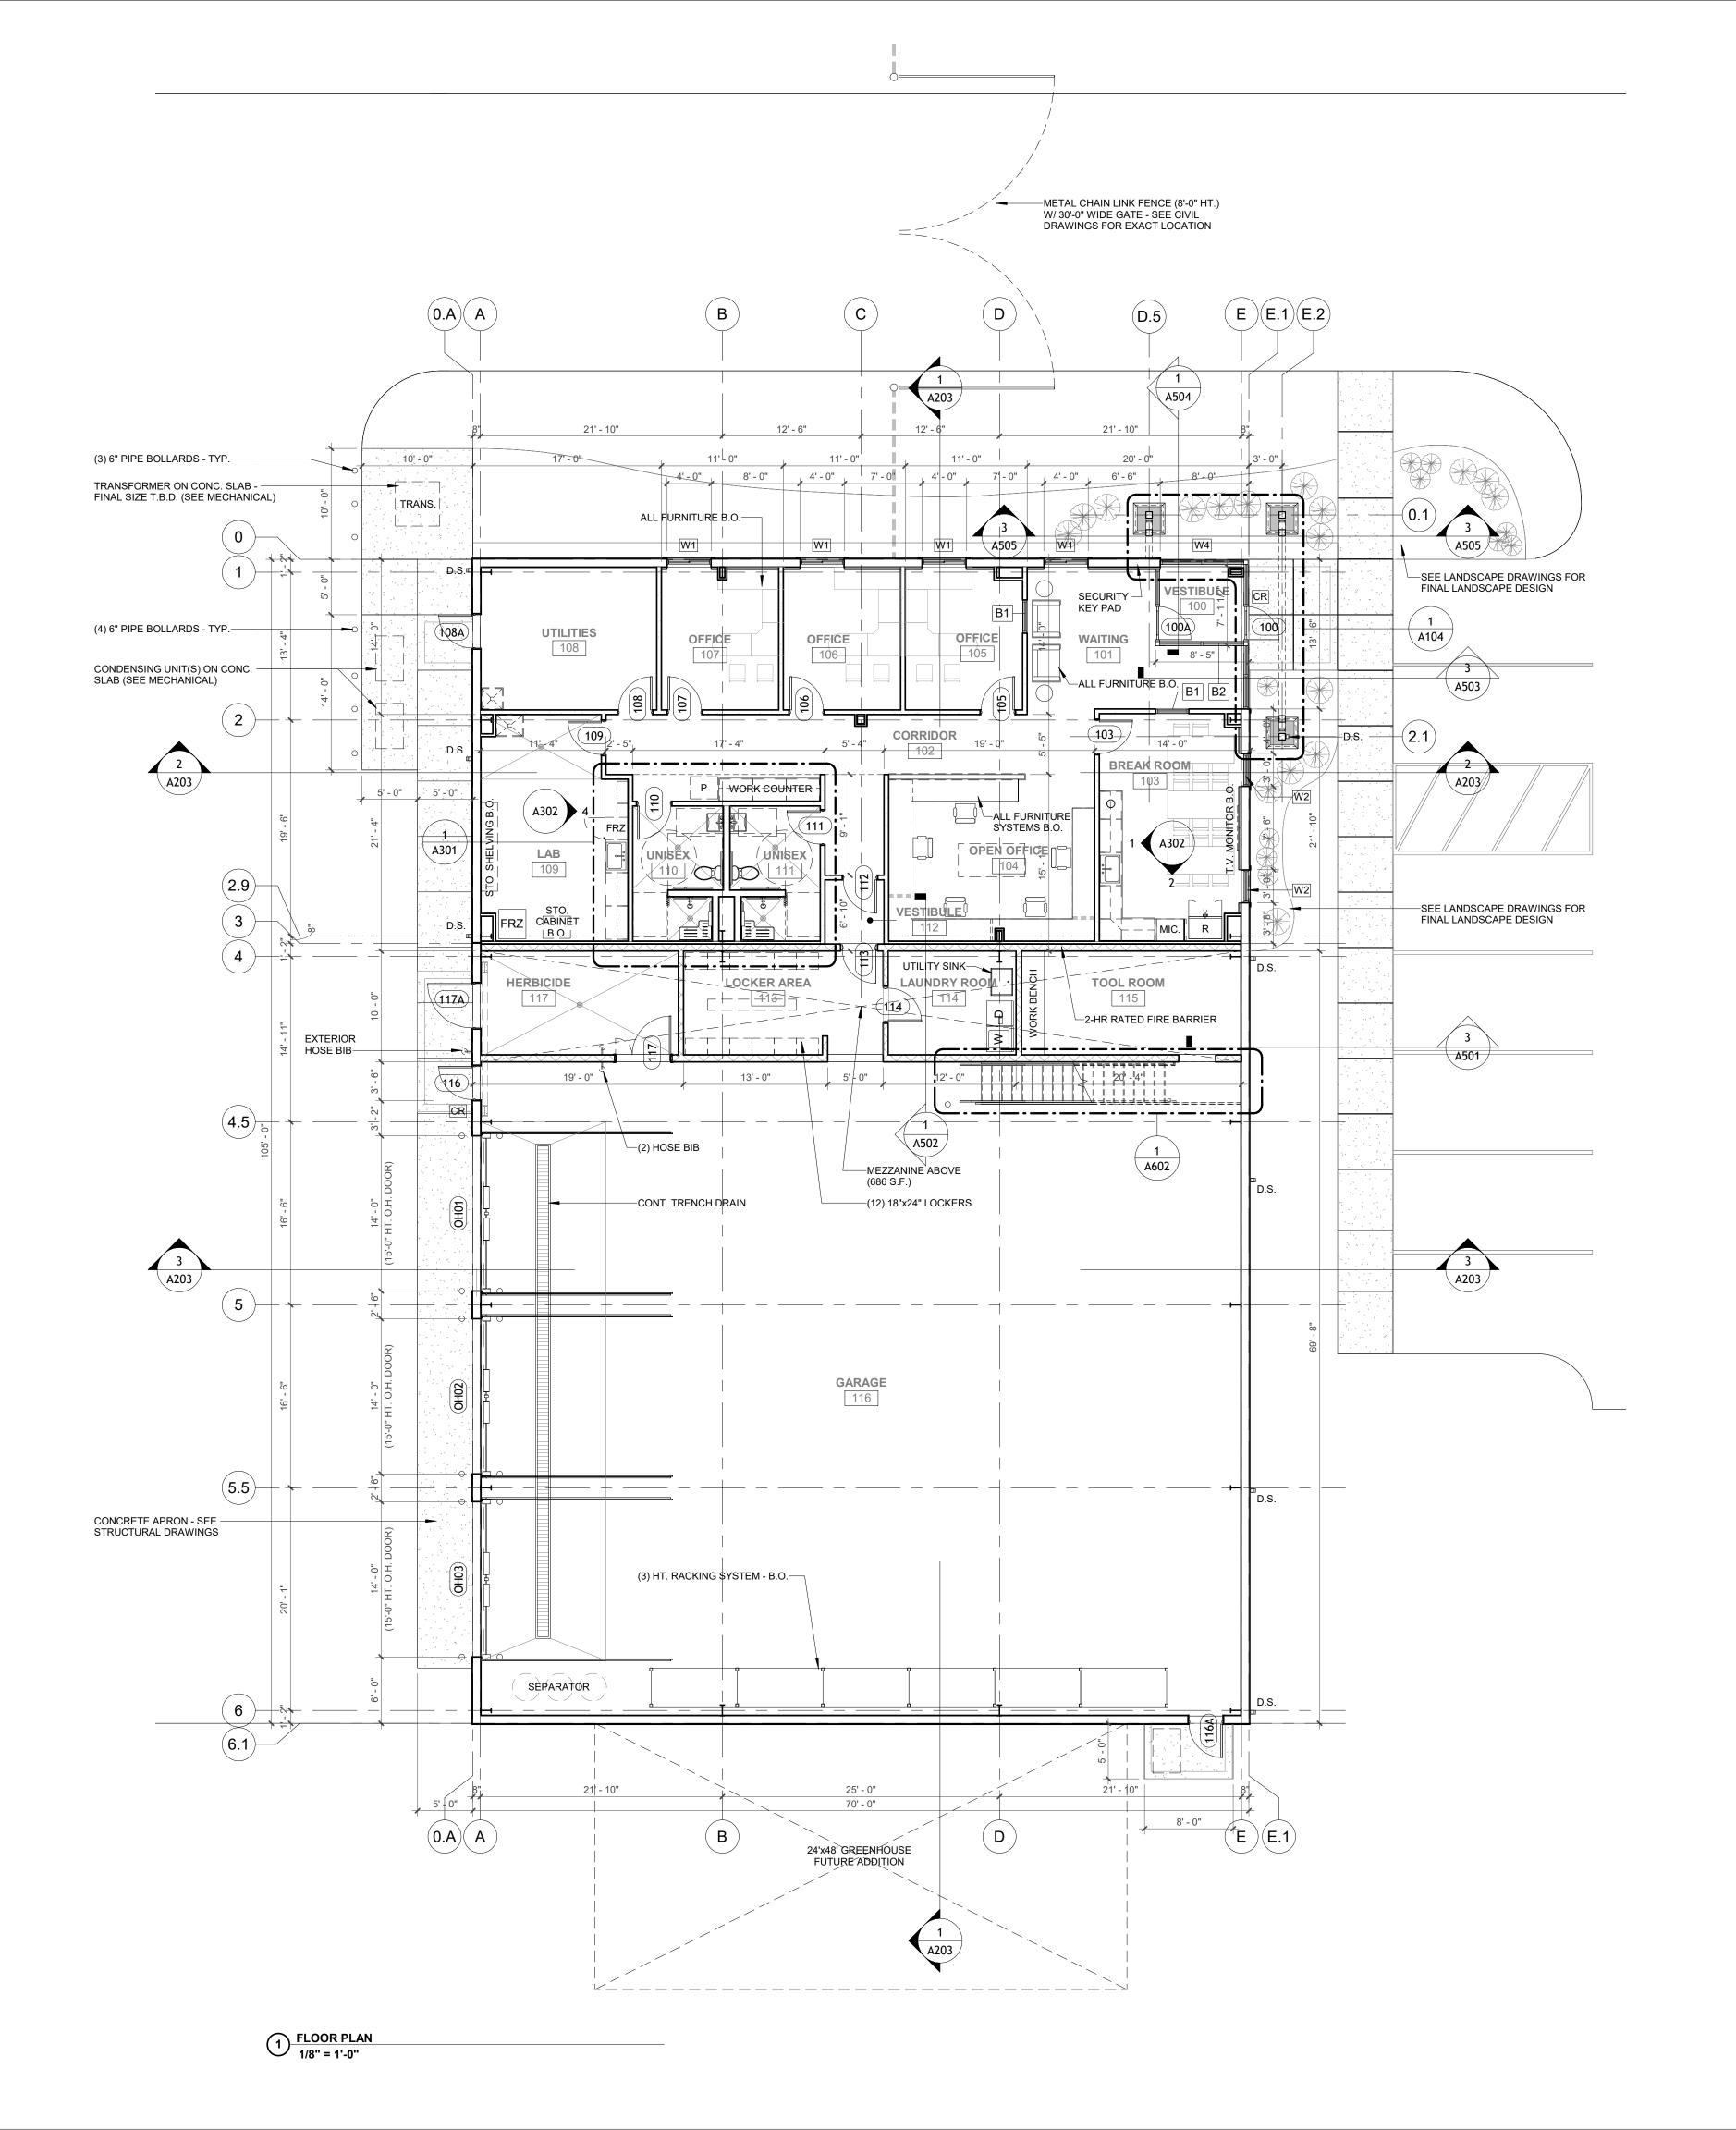
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FOUNDATION PLAN

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2025-09





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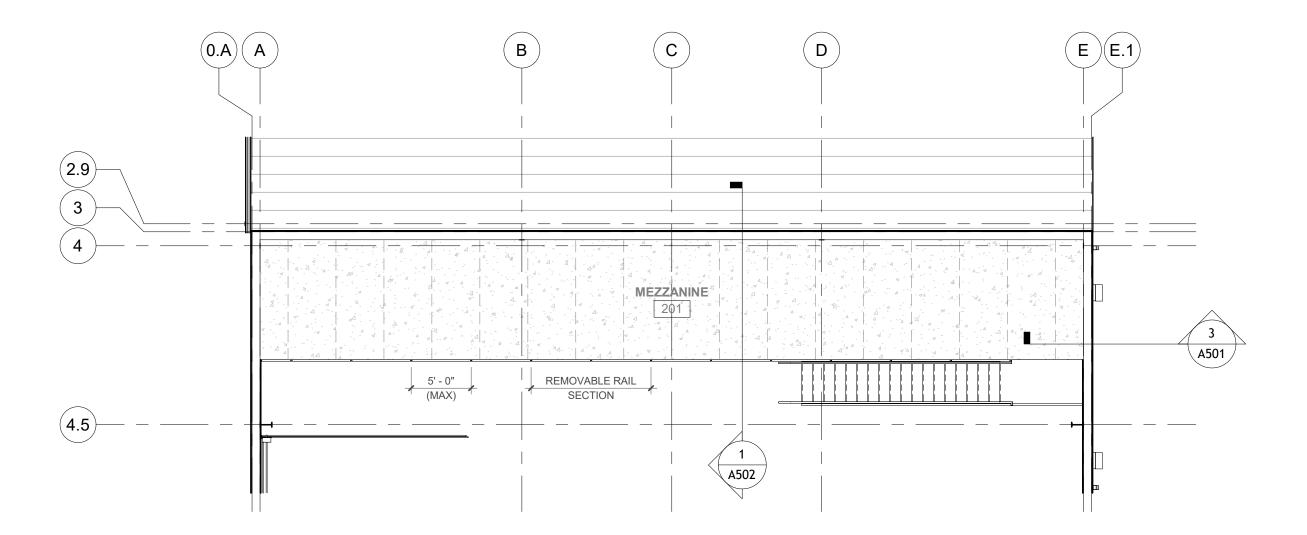
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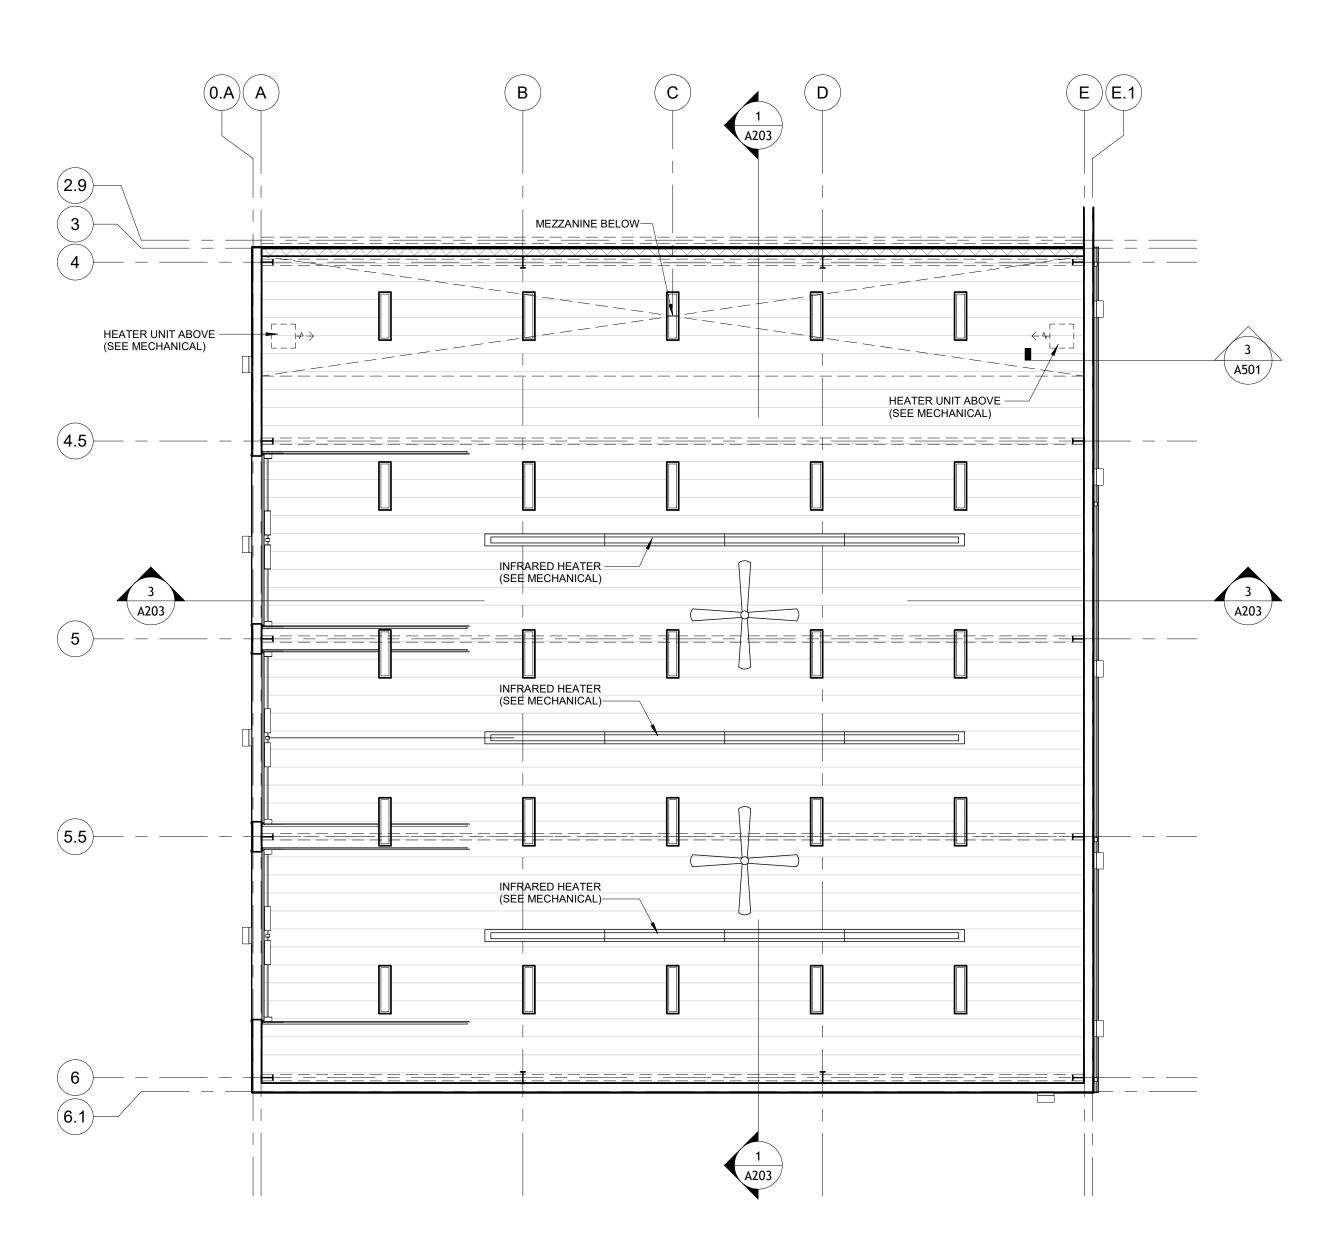
FLOOR PLAN

Ref. North

Sheet No.



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Forest Preserves of Winnebago County

Meridian Rd., Winnebago County, Illinois

THE CONTRACTOR SHALL DETERMINE EXACT DIMENSIONS AND CONDITIONS AT THE SITE PRIOR TO SUBMITTING A BID. THE CONTRACTOR SHALL COORDINATE ALL DRAWINGS WITH ACTUAL FIELD CONDITIONS PRIOR TO PROCEEDING WITH THE WORK AND NOTIFY THE ARCHITECT OF ANY DISCREPANCIES. THIS DRAWING IS THE PROPERTY OF BLAKEMORE ARCHITECTS AND MAY NOT BE REPRODUCED WITHOUT THE PRIOR WRITTEN PERMISSION OF THE ARCHITECT.

1	NO.	DATE	DESCRIPTION
_			
	1)	05-08-2025	Initial Layou
	2)	08-07-2025	Schematic Design
	3)	08-27-2025	Design Developmen
_	4)	10-17-2025	Final Owner Review Se
_	5)	10-27-2025	Issued for Bids / Permi
			
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COLINION DIRREMOTE ALCHITECTS 2025

BA Project No.

Scale

1/8" = 1'-0"

Sheet Title


MEZZANINE FLOOR PLANS

Ref. North

Sheet No.

2025-09

A102

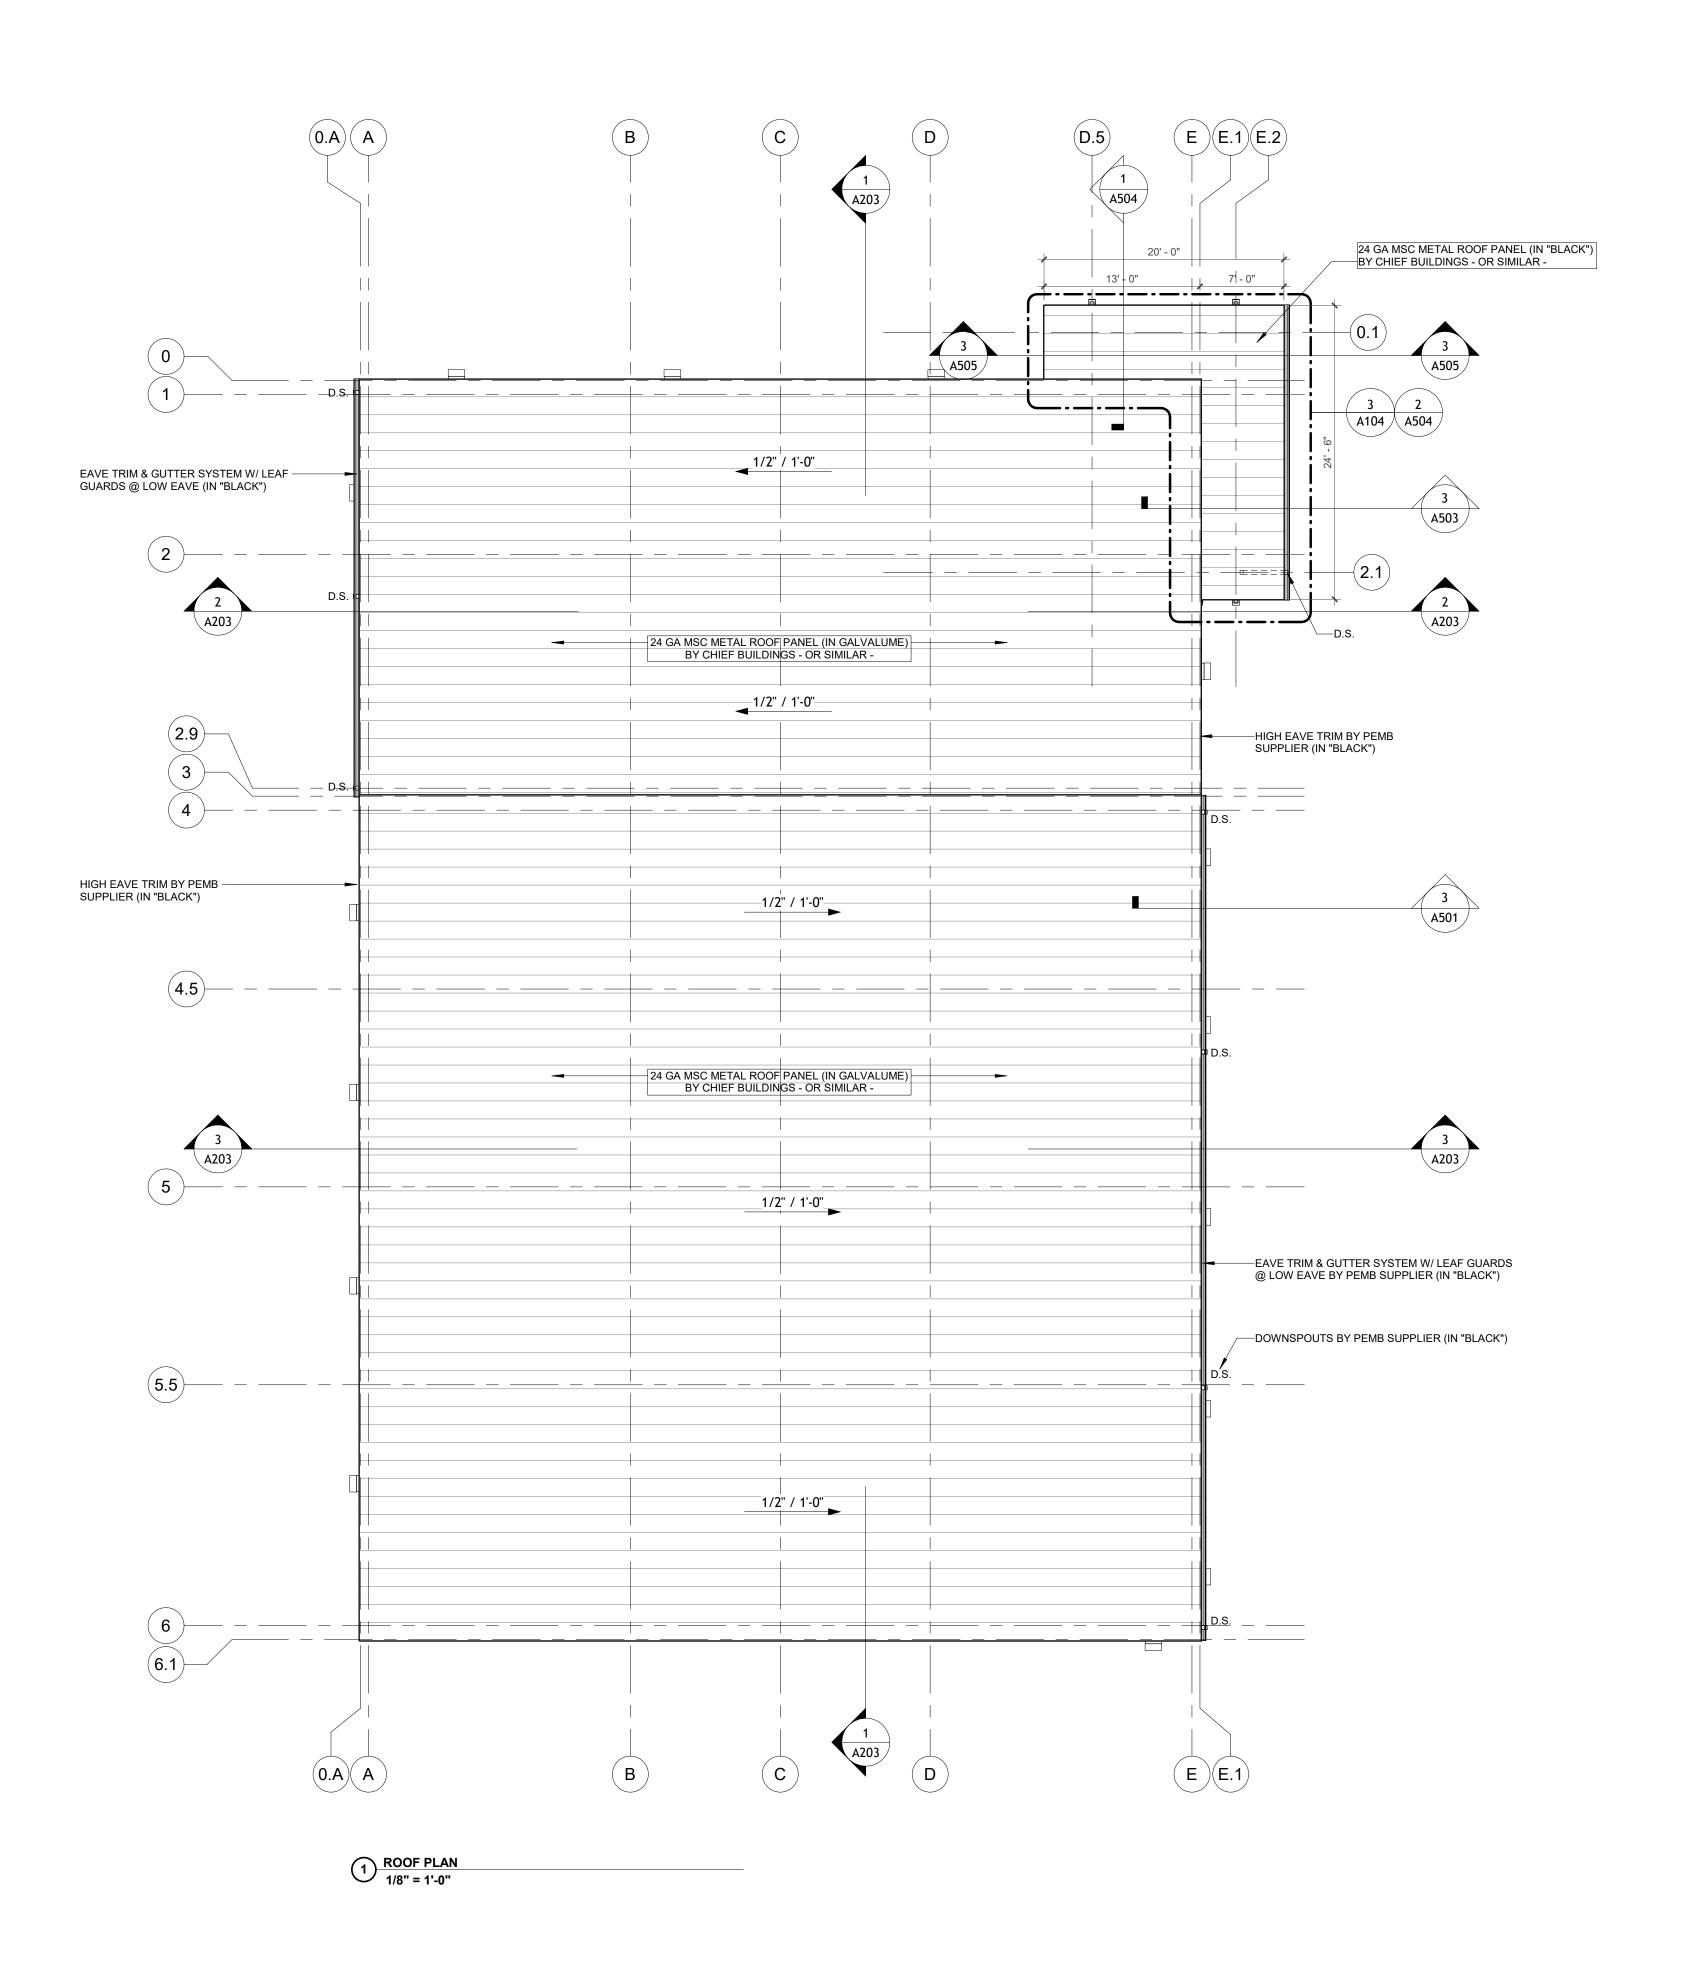



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New Building

for

Forest Preserves of Winnebago County

Meridian Rd., Winnebago County, Illinois

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Scale

1/8" = 1'-0"

2025-09


Sheet Title


ROOF PLAN

Ref. North

Sheet No.

A103

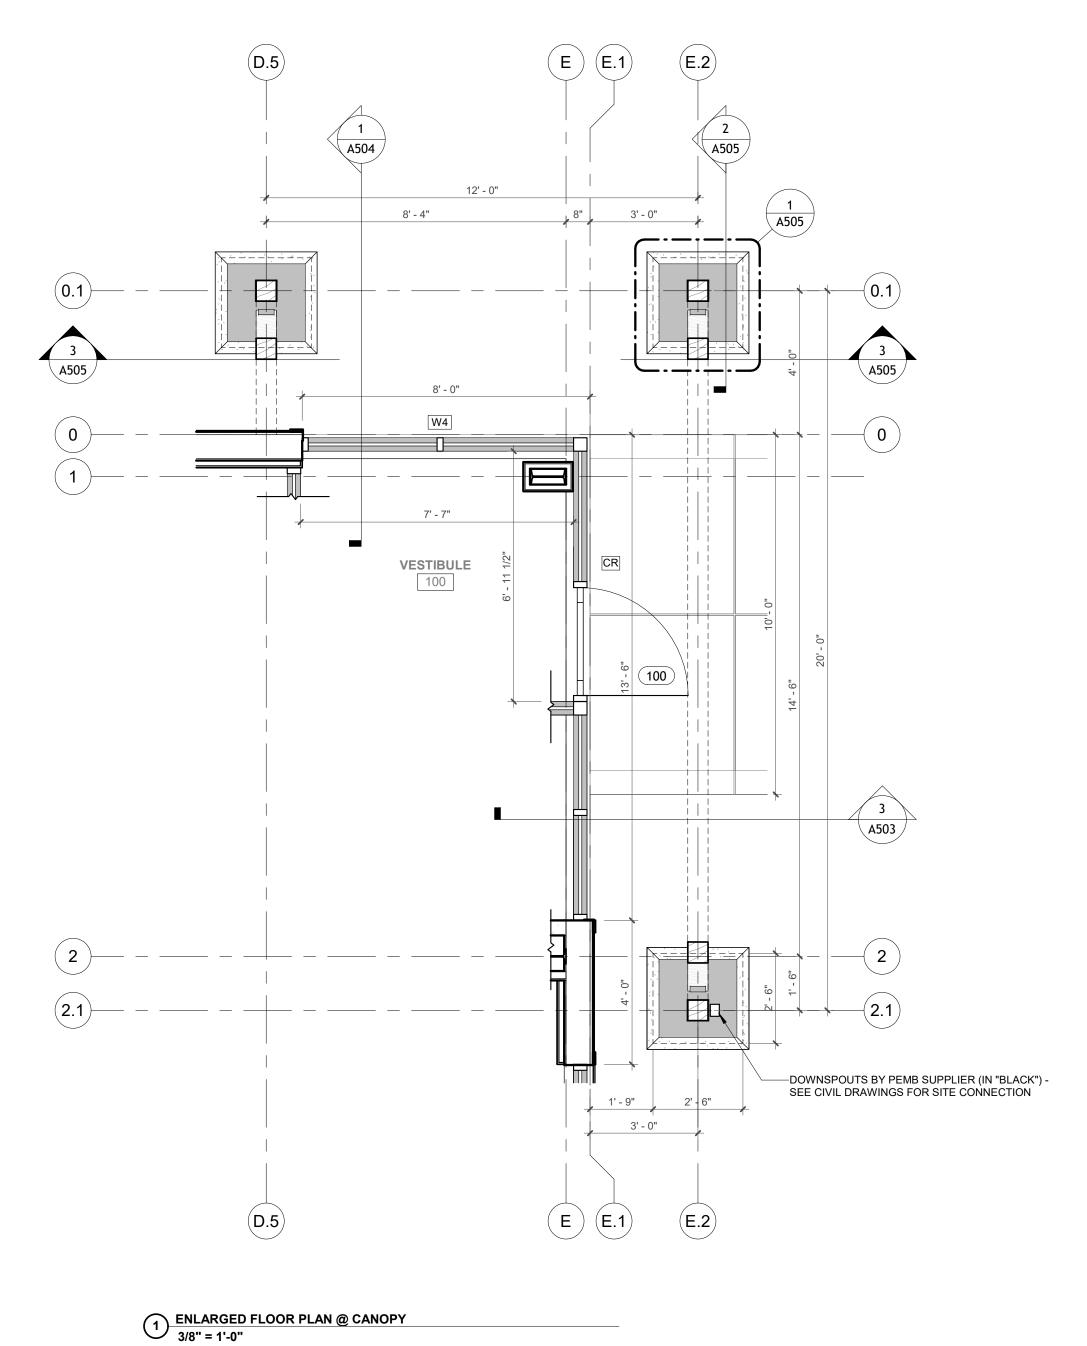

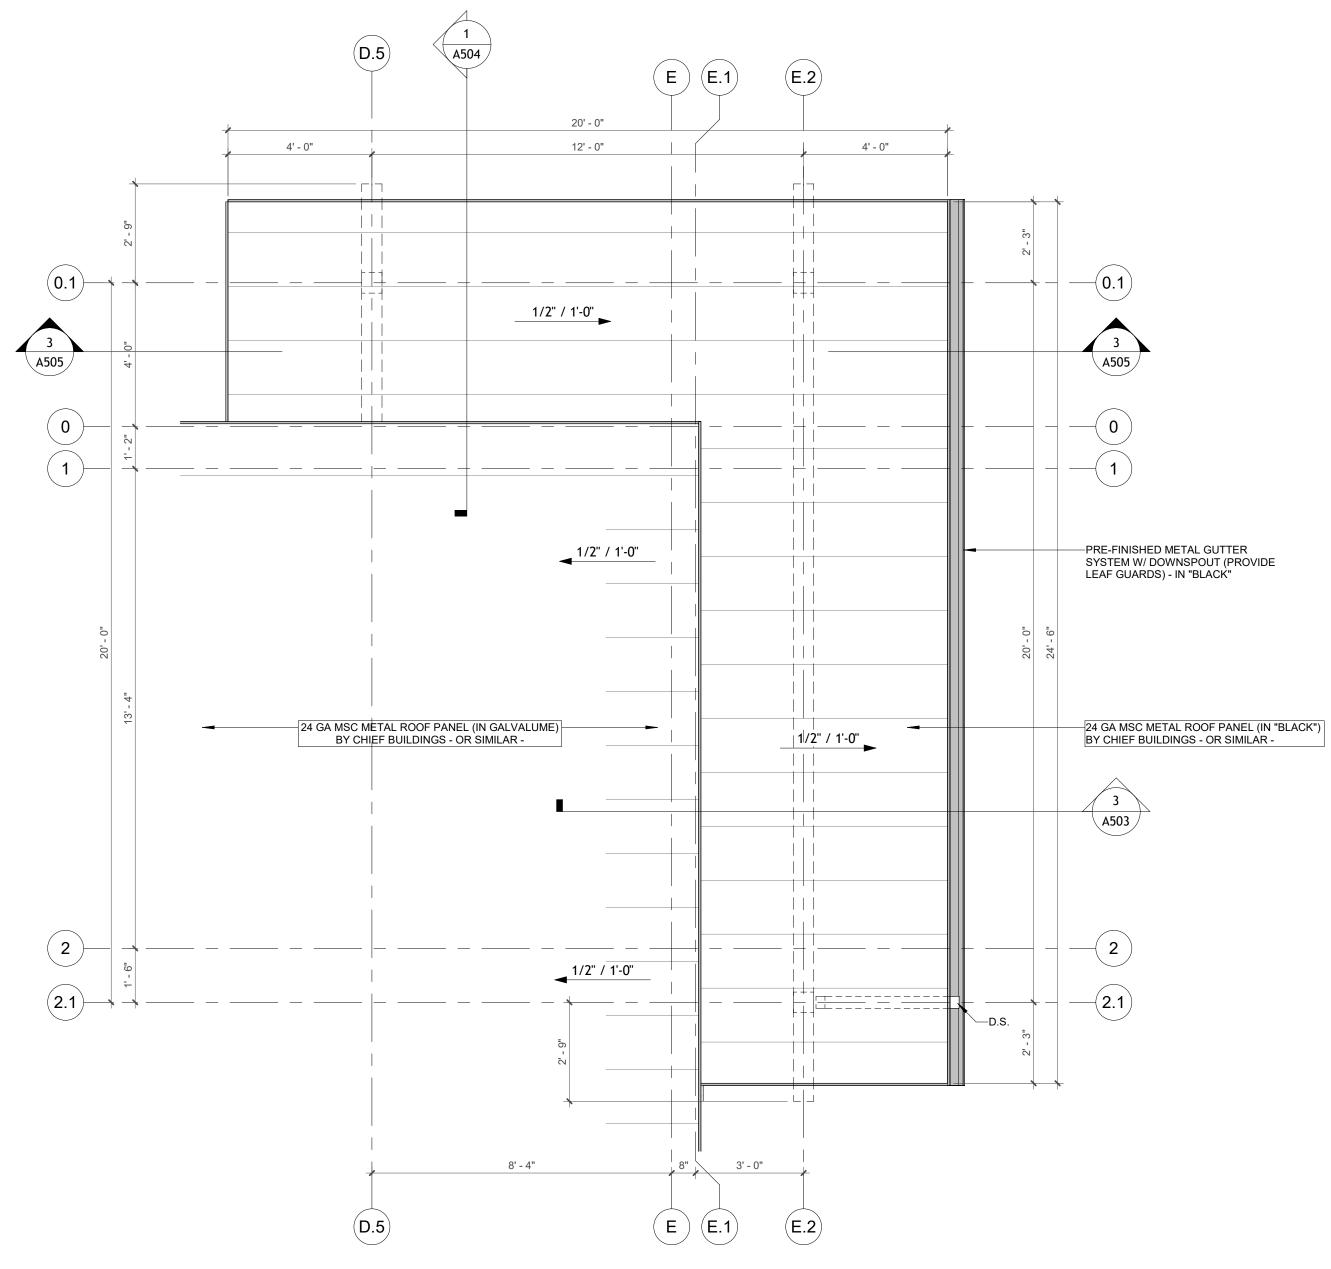

3 ENLARGED ROOF PLAN @ CANOPY
3/8" = 1'-0"



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3/8" = 1'-0"

Sheet Title

CANOPY FLOOR PLANS

Ref. North

Sheet No.

2025-09

A104

ONAL DESIGN FIRM REGISTRATION #

ROOM SCHEDULE REMARKS:

- 1. PROVIDE SCHLUTER "RENO-U" TRANSITION "T-1" BETWEEN FLOORING LVT-1 & PRT-1 AT RESTROOMS.
- 2. ALL SHOWER WALLS WITH PORCELAIN TILE TO BE FULL HEIGHT.

ROOM SCHEDULE ROOM INFO FLOOR

	ROOM INFO	FLOOF	₹		WALLS					OTHER
ROOM#	ROOM NAME	FLOOR FINISH	WALL BASE	NORTH WALL	EAST WALL	SOUTH WALL	WEST WALL	CEILING FINISH	CEILING HEIGHT	REMARKS
100	VESTIBULE	CPT-1	-	AL. STOREFRONT	AL. STOREFRONT	AL. STOREFRONT	AL. STOREFRONT	LACP-1	8' - 0"	-
101	WAITING	LVT-1	RB-1	GYP. BD. / PNT-1	AL. STOREFRONT	GYP. BD. / PNT-1	GYP. BD. / PNT-1	LACP-1	9' - 0"	-
102	CORRIDOR	LVT-1	RB-1	GYP. BD. / PNT-1	GYP. BD. / PNT-1	GYP. BD. / PNT-1	GYP. BD. / PNT-1	LACP-1	9' - 0"	-
103	BREAK ROOM	LVT-1	RB-1	GYP. BD. / PNT-1	GYP. BD. / PNT-1	GYP. BD. / PNT-1	GYP. BD. / PNT-1	LACP-1	9' - 0"	-
104	OPEN OFFICE	LVT-1	RB-1	GYP. BD. / PNT-1	GYP. BD. / PNT-1	GYP. BD. / PNT-1	GYP. BD. / PNT-1	LACP-1	9' - 0"	-
105	OFFICE	LVT-1	RB-1	GYP. BD. / PNT-1	GYP. BD. / PNT-1	GYP. BD. / PNT-1	GYP. BD. / PNT-1	LACP-1	9' - 0"	-
106	OFFICE	LVT-1	RB-1	GYP. BD. / PNT-1	GYP. BD. / PNT-1	GYP. BD. / PNT-1	GYP. BD. / PNT-1	LACP-1	9' - 0"	-
107	OFFICE	LVT-1	RB-1	GYP. BD. / PNT-1	GYP. BD. / PNT-1	GYP. BD. / PNT-1	GYP. BD. / PNT-1	LACP-1	9' - 0"	-
108	UTILITIES	S.CONC.	RB-1	GYP. BD. / PNT-1	GYP. BD. / PNT-1	GYP. BD. / PNT-1	GYP. BD. / PNT-1	EXPOSED / SIMPLE SAVER SYSTEM	-	-
109	LAB	LVT-1	RB-2	GYP. BD. / PNT-4	GYP. BD. / PNT-4	GYP. BD. / PNT-4	GYP. BD. / PNT-4	LACP-2	9' - 0"	-
110	UNISEX	LVT-1	RB-2	GYP. BD. / PNT-4	GYP. BD. / PNT-4	GYP. BD. / PNT-4	GYP. BD. / PNT-4	GYP. BD. / PNT-6	8' - 0"	-
110A	SHOWER	PRT-1	PRT-1	PRT-1	PRT-1	PRT-1	-	GYP. BD. / PNT-6	8' - 0"	#1, 2
111	UNISEX	LVT-1	RB-2	GYP. BD. / PNT-4	GYP. BD. / PNT-4	GYP. BD. / PNT-4	GYP. BD. / PNT-4	GYP. BD. / PNT-6	8' - 0"	-
111A	SHOWER	PRT-1	PRT-1	PRT-1	-	PRT-1	PRT-1	GYP. BD. / PNT-6	8' - 0"	#1, 2
112	VESTIBULE	CPT-1	RB-1	GYP. BD. / PNT-1	GYP. BD. / PNT-1	GYP. BD. / PNT-1	GYP. BD. / PNT-1	LACP-1	8' - 0"	-
113	LOCKER AREA	S.CONC.	RB-1	CMU / PNT-1	CMU / PNT-1	CMU / PNT-1	CMU / PNT-1	EXPOSED / HOLLOWCORE / PNT-6	10' - 0"	-
114	LAUNDRY ROOM	S.CONC.	RB-1	CMU / PNT-1	CMU / PNT-1	CMU / PNT-1	CMU / PNT-1	EXPOSED / HOLLOWCORE / PNT-6	10' - 0"	-
115	TOOL ROOM	S.CONC.	RB-1	CMU / PNT-1	SIMPLE SAVER SYSTEM / METAL LINER PANEL (24GA UP TO 7'-6" A.F.F.)	CMU / PNT-1	CMU / PNT-1	EXPOSED / HOLLOWCORE / PNT-6	10' - 0"	-
116	GARAGE	S.CONC.	-	-	SIMPLE SAVER SYSTEM / METAL LINER PANEL (24GA UP TO 7'-6" A.F.F.)	SIMPLE SAVER SYSTEM / METAL LINER PANEL (24GA UP TO 7'-6" A.F.F.)	SIMPLE SAVER SYSTEM / METAL LINER PANEL (24GA UP TO 7'-6" A.F.F.)	EXPOSED / SIMPLE SAVER SYSTEM	-	-
117	HERBICIDE	S.CONC.	RB-1	CMU / PNT-1	CMU / PNT-1	CMU / PNT-1	CMU / PNT-1	EXPOSED / HOLLOWCORE / PNT-6	10' - 0"	-
201	MEZZANINE	S.CONC.	-	EXPOSED / SIMPLE SAVER SYSTEM	EXPOSED / SIMPLE SAVER SYSTEM	-	EXPOSED / SIMPLE SAVER SYSTEM	EXPOSED / SIMPLE SAVER SYSTEM	-	-

ROOM FINISH LEGEND (FINAL APPROVAL OF ALL COLOR AND MATERIAL SELECTIONS BY ARCHITECT)

TAG	DESCRIPTION	MANUFACTURER	PRODUCT	COLOR / FINISH	REMARKS
CPT-1	CARPET TILE FLOORING 1 (WALK-OFF)	BENTLEY	ROUGH IDEA SHEAR 8RN24, "OUTLINE" #800115, ASHLAR INSTALL	OUTLINE #800115 / ASHLAR INSTALL	
LVT-1	LUXURY VINYL TILE/PLANK 1	BENTLEY	MOOD, 9" x 48", RANDOM ASHLAR INSTALL	INTEGRATED #801994 / ASHLAR INSTALL (FINAL SELECTION T.B.D.)	
PRT-1	PORCELAIN TILE 1	FLORIDATILE	AVENTIS HDP COLOR BODY PORCELAIN FLOOR & WALL TILE	"VELVET", 12"x24" WALL TILE (HORIZONTAL INSTALL ON WALLS) & 2"x2" MOSAIC FLOOR TILE	
S. CONC.	SEALED CONCRETE FLOOR FINISH	BASF	LAPIDOLITH	-	
-	-	-	-	-	
RB-1	RUBBER BASE (4" HIGH)	ROPPE	TP 76193 - 1/8" TPR RUBBER - COVE	BLACK-BROWN #P193	
RB-2	RUBBER BASE (6" HIGH)	ROPPE	TP 76193 - 1/8" TPR RUBBER - COVE	BLACK-BROWN #P193	
-	-	-	-	-	
PNT-1	PAINT 1	SHERWIN WILLIAMS	MAIN WALL PAINT 1 / EGGSHELL FOR GYP.BD., SEMI-GLOSS FOR CMU	(1) PRIME COAT / (2) FINISH COATS - "COLOR T.B.D."	
PNT-2	PAINT 2	SHERWIN WILLIAMS	MAIN WALL PAINT 2 / EGGSHELL FOR GYP.BD., SEMI-GLOSS FOR CMU	(1) PRIME COAT / (2) FINISH COATS - "COLOR T.B.D."	
PNT-3	PAINT 3	SHERWIN WILLIAMS	ACCENT WALL PAINT / EGGSHELL FOR GYP.BD., SEMI-GLOSS FOR CMU	(1) PRIME COAT / (2) FINISH COATS - "COLOR T.B.D."	
PNT-4	PAINT 4	SHERWIN WILLIAMS	WALL PAINT / EPOXY (IN ALL RESTROOMS & JANITORIAL)	(1) PRIME COAT TUFF HIDE / (2) FINISH COATS - "COLOR T.B.D."	
PNT-5	PAINT 5	SHERWIN WILLIAMS	HOLLOW METAL DOORS & FRAMES PAINT / SEMI-GLOSS	(1) PRIME COAT / (2) FINISH COATS - "COLOR T.B.D."	
PNT-6	PAINT 6	SHERWIN WILLIAMS	DRYWALL CEILING, SOFFITS PAINT / FLAT IN NON-WET ROOMS, EPOXY IN RESTROOMS / SEMI-GLOSS IN EXPOSED CONCRETE & HOLLOWCORE	(1) PRIME COAT / (2) FINISH COATS - "COLOR T.B.D."	
-	-	-	-	-	
LACP-1	LAY-IN ACOUSTICAL PANEL CEILING 1	CERTAINTEED	CASHMERE HIGH NRC (CM-454NRCP) 24"x24"x3/4" (W/ 15/16" REVEAL BEVELED GRID)	WHITE TILE / WHITE GRID	
LACP-2	LAY-IN ACOUSTICAL PANEL CEILING 2	CERTAINTEED	SYMPHONY m 70 Rx (1222-RXS-1) 24"x24"x3/4" (W/ 15/16" CLASSIC GRID)	WHITE TILE / WHITE GRID	
-	-	-	-	-	
-	-	-	-	-	
-	-	-	-	-	
CMU	CONCRETE MASONRY UNIT	-	-	-	
-	-	-	-	-	
T-1	FLOOR TRANSITION 1	SCHLUTER	RENO-U: TRANSITION BETWEEN FLOORING LVT-1 & PRT-1	-	
T-2	FLOOR TRANSITION 2	SCHLUTER	SHOWERPROFILE-WSK: FLOOR SPLASHGUARD AT SHOWER(S)	-	
T-3	FLOOR TRANSITION 3	-	FLOOR RUBBER TRANSITION	BLACK	
-	-	-	-	-	



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oject No.

Scale

Sheet Title

ROOM SCHEDULES

Ref. North

Sheet No.

2025-09

A105

	DOOR SCHEDULE							HARDWARE SCHEDULE																					
															│	3 PAIR 1	SET AGE SET		WALL STOP FLOOR STOP	H BOLT-TOP H BOLT-BOT	CLOSER CLOSER W/STOP WEATHERSTRIP	SWEEPS	LATE		RIC STRIKE READER B.O.	SEX SIGN CH GUARD CONTROL DEVICE DOOR HARDWARE	DOOR COORDINATOR ASTRAGAL PANIC BAR 1	CAT	SET W/ OCCU. INDICATOR E SEALS
DOOR#	SG/PR/OH	HEIGHT	WIDTH	THICKNESS	DOOR MATERIAL	DOOR TYPE	FRAME MATERIAL	FRAME TYPE	DOOR GLAZING	ZING FRAME GLAZING	FIRE RATING	LF	CARD READER	NOTES	PIVOT	HINGE	LOCKSET	PUSH	WALL S'	FLUSH BOL	CLOSER CLOSER CLOSER WEATHEI	DOOR SWE	KICKPLATI	DRIP CAP	ELECTRIC CARD REA	UNISEX LATCH EXIT CC O.H. DC	ASTRA PANIC	REMOVAL ROLLER C	LOCKSE' SMOKE S
100	SG	7' - 10"	3' - 0"	1 3/4"	AL.	D4	AL.	F4	1" INSUL.	1" INSUL.	-	-	CR	NOTE: #3	Δ	Δ		ΔΔ			ΔΔ				ΔΔ		Δ		
100A	SG	7' - 10"	3' - 0"	1 3/4"	AL.	D4	AL.	F5	1/4" TEMP.	1/4" TEMP.	-	-	-	NOTE: #4	Δ			$\Delta \Delta$			Δ						Δ		
103	SG	7' - 0"	3' - 0"	1 3/4"	НМ	D3	НМ	F1	1/4" TEMP.	-	-	-	-	-	0		0		0		0			0	,				
105	SG	7' - 0"	3' - 0"	1 3/4"	НМ	D3	НМ	F1	1/4" TEMP.	-	-	0	-	-	0		0		0					0					
106	SG	7' - 0"	3' - 0"	1 3/4"	HM	D3	НМ	F1	1/4" TEMP.	-	-	0	-	-	0		0		0					0	,				
107	SG	7' - 0"	3' - 0"	1 3/4"	HM	D3	HM	F1	1/4" TEMP.	-	-	0	-	-	0		0		0					0	•				
108	SG	7' - 0"	3' - 0"	1 3/4"	HM	D1	HM	F1	-	-	-	S	-	-	0		0		0		0			0	١				
108A	SG	7' - 0"	3' - 0"	1 3/4"	HM	D1	HM	F1	-	-	-	S	-	-			0		0		00	00)	00	,				
109	SG	7' - 0"	3' - 0"	1 3/4"	HM	D2	HM	F1	1/4" TEMP.	-	-	0	-	-	0		0		0		0								0
110	SG	7' - 0"	3' - 0"	1 3/4"	HM	D1	HM	F1	-	-	-	PR	-	NOTE: #1	0				0					0	•	0			0
111	SG	7' - 0"	3' - 0"	1 3/4"	HM	D1	HM	F1	-	-	-	PR	-	NOTE: #1	0				0					0	,	0			0
112	SG	7' - 0"	3' - 0"	1 3/4"	HM	D2	HM	F1	1/4" TEMP.	-	-	-	-	-	0		0		0		0								0
113	SG	7' - 0"	3' - 0"	1 3/4"	HM	D2	HM	F2	1/4" TEMP.	-	120 MIN	-	-	NOTE #0	0		0		0		0								0
114	SG	7' - 0"	3' - 0"	1 3/4"	HM	D1	HM	F2	- 1" INICI II	-	-	-	- CP	NOTE: #2	0		0		0		0			0					0
116	SG	7' - 0"	3' - 0"	1 3/4" 1 3/4"	HM	D2	HM	F1	1" INSUL.	-	-	-	CR	-	0		0				00	00			00	 	0		
116A 117	SG PR	7' - 0" 7' - 0"	3' - 0" 5' - 0"	1 3/4"	HM HM	D1 D5	HM HM	F1 F3	-	-	-	-	-	-	0		0		0	00	00	00	7	0		0	0		0
117A	SG	7 - 0"	4' - 0"	1 3/4"	HM	D5	HM	F1	-	-	-	-	-	-	0	0	0				0 0	0 0	<u> </u>	0		0	0	+-	
OH01	OH	15' - 0"	14' - 0"	2"	STL.	D1	STL.	-	-	-	-	-	-	-									'			0	+		
OH02	ОН	15' - 0"	14' - 0"	2"	STL.	D6	STL.	-	-	_	_	_	_	-												0		+-	
OH03	ОН	15' - 0"	14' - 0"	2"	STL.	D6	STL.	-	_	-	_	_	-	-												0			

SMOKE SEALS PREMIKO S88D SILICONE DOOR SILENCERS IVES (3 PER DOOR) NO. 02 WHITE/GREY THRESHOLD REESE S245A MILL AL. DRIP CAP HAGER 810S MILL AL. LATCH GUARD HAGER 332D - WEATHER-STRIPPING/SWEEP - ANY - PANIC BAR VON DUPRIN 98/99L RIM EXIT DEVICE W/ LEVER (KEY LOCK) US26D SATIN CHROMIUM EXIT CONTROL DEVICE DETEX V40 x 38 x CD x EBXW W/ MORTISE CYLINDER - 30-001x118 (PUSH TO OPEN - ALARM WILL SOUND AT EXTERIOR DOORS) WEATHER STOREROOM* C = CLASSROOM O = OFFICE PR = PRIVACY P = PASSAGE D = DUMMY E = ENTRY BED = BEDROOM ALUMINUM STOREFRONT HARDWARE: PIVOT HINGES MFR STANDARD TO P& BOT. OFFSET PIVOTS MILL AL.	ARDWARE	MANUFA	CTURE	RS		
SPRING HINGES	PRODUCT NAME	MANUFACTURER	MC	DDEL/PART NUMBER		FINISH
PRINC HINGES IVES 3SPI US32D SATIN STAINLESS SELECTRIC HINGES MES 589HW 4.5%4.5 (8 WIRE) US32D SATIN STAINLESS COCKSET WOCCU INDICATOR SCHLAGE D-SERIESRHODES LEVER US32D SATIN STAINLESS COCKSET WOCCU INDICATOR SCHLAGE D-SERIESRHODES LEVER (INDIGES AT HOS.OCC) US32D SATIN STAINLESS STOPH HOLDER GLYNN JOHNSON 90 SERIES US32D SATIN STAINLESS TOPH HOLDER GLYNN JOHNSON 90 SERIES US32D SATIN STAINLESS TOPH HOLDER MES WASGO US32D SATIN STAINLESS WALLSTOP MES AS REQUIRED MATCH US32D SATIN STAINLESS US32D SATI						
DECETRIC HINGES VES SBBIHW 4.5x4.5 (8 WIRE) US32D SATIN STAINLESS COCKSET SCHLAGE D-SERIES,RHODES LEVER (ND40S ATH OS-OCC) US32D SATIN STAINLESS CLOSER LCN 4040 XP LCN 4040 XP STOP HOLDER GLYNN, JOHNSON VES WS406 US32D SATIN STAINLESS CLOSE STOP NES WS406 US32D SATIN STAINLESS CLOSE STOP NES WS406 US32D SATIN STAINLESS CLOSE WS406 US32D SATIN STAINLESS CLOSE WS406 US32D SATIN STAINLESS CLOCK STOP VES AS REQUIRED MATCH US32D FINSH ROCKWOOD 111 x 73C/73CL US32D SATIN STAINLESS SPULL ROCKWOOD 111 x 73C/73CL US32D SATIN STAINLESS SPULL ROCKWOOD 111 x 73C/73CL US32D SATIN STAINLESS SELECTRIC STRIKE ROCKWOOD 111 x 73C/73CL US32D SATIN STAINLESS SELECTRIC STRIKE ROCKWOOD K100S 212 x 34" US32D SATIN STAINLESS LUSH BOLT-TOP 8 BOTTOM ROCKWOOD S55 US60D SATIN CHROME STAINLESS US60D SATIN CHROME STRIKE ROCKWOOD S55 US60D SATIN CHROME US60D SATIN CHROME STRIKE ROCKWOOD S55 US60D SATIN CHROME US60D SATIN CHROME US60D SATIN CHROME STRIKE ROCKWOOD S55 US60D SATIN CHROME STRIKE ROCKWOOD S55 US60D SATIN CHROME STRIKE ROCKWOOD S55 US60D SATIN CHROME STRIKE ROCKWOOD S56 US60D SATIN CHROME STRIKE ROCKWOOD S57 US60D SATIN CHROME S58D SILICONE DUS60D SATIN CHROMINI S1ICONE US60D SATIN CHROMINI S0LICONE US60D SATIN CHROMINI US60D SATIN CHROMINI S0LICONE US60D SATIN CHROMINI S0LICONE US60D SATIN CHROMINI US60D SATIN	ES	IVES	5BBIHW 4.5x4.5		US32D SATIN S	STAINLESS STEEL
D. SERIES/RHODES LEVER US32D SATIN STAINLESS	NG HINGES	IVES	3SPI		US32D SATIN S	STAINLESS STEEL
D. SERIES/REHODES LEVER (ND493 ATH OS-OCC)	TRIC HINGES	IVES	5BBIHW 4.5x4.5	(8 WIRE)	US32D SATIN S	STAINLESS STEEL
CLOSER LCN	(SET	SCHLAGE	D-SERIES/RHOD	DES LEVER	US32D SATIN S	STAINLESS STEEL
STOP HOLDER	(SET W/ OCCU. INDICATOR	SCHLAGE	D-SERIES/RHOD	DES LEVER (ND40S ATH OS-OCC)	US32D SATIN S	STAINLESS STEEL
VILL STOP VIES	SER	LCN	4040 XP			
AS REQUIRED	, HOLDER	GLYNN JOHNSON	90 SERIES		US32D SATIN S	STAINLESS STEEL
PUSH ROCKWOOD 1111 x 73C/73CL US32D SATIN STAINLESS PULL ROCKWOOD 1111 x 73C/73CL US32D SATIN STAINLESS CELECTRIC STRIKE	STOP	IVES	WS406		US32D SATIN S	STAINLESS STEEL
PULL ROCKWOOD	OR STOP	IVES	AS REQUIRED		MATCH US32D	FINISH
24VDC 6211-FS-DS-CON	1	ROCKWOOD	111 x 73C/73CL		US32D SATIN S	STAINLESS STEEL
SCICKPLATE		ROCKWOOD	111 x 73C/73CL		US32D SATIN S	STAINLESS STEEL
REMOR PLATE ROCKWOOD K1050 34" x 34" US32D SATIN STAINLESS FEUSH BOLT-TOP & BOTTOM ROCKWOOD 555 US26D SATIN CHROME DUST PROOF STRIKE ROCKWOOD 570 US26D SATIN CHROME ASTRAGAL BY DOOR MANUF. Z TYPE	TRIC STRIKE		24VDC 6211-FS-	DS-CON	US32D SATIN S	STAINLESS STEEL
SECOND S	PLATE	ROCKWOOD	K1062 12" x 34"		US32D SATIN S	STAINLESS STEEL
DUST PROOF STRIKE	OR PLATE	ROCKWOOD	K1050 34" x 34"		US32D SATIN S	STAINLESS STEEL
ASTRAGAL BY DOOR MANUF. Z TYPE	H BOLT-TOP & BOTTOM	ROCKWOOD	555		US26D SATIN	CHROME
MAG LOCK SECURITRON MM15 SERIES BLACK DOOR SWEEP HAGER 750SS STAINLESS STEEL W/ SIL SMOKE SEALS PREMKO S88D SILICONE DOOR SILENCERS PEESE NES (3 PER DOOR) NO. 02 WHITE/GREY THRESHOLD REESE S245A MILL AL. DORIP CAP HAGER 810S MILL AL. ATCH GUARD HAGER 332D PANIC BAR VON DUPRIN 98/99L RIM EXIT DEVICE W/ LEVER (KEY LOCK) US26D SATIN CHROMIUM EXIT CONTROL DEVICE DETEX V40 x 36 x CD x EBXW W/ MORTISE CYLINDER- 30-001x118 (PUSH TO OPEN- ALARM WILL SOUND AT EXTERIOR DOORS) TO SUND AT EXTERIOR DOORS LOCKSET FUNCTION KEY (LF): (* LEVER TO RECEIVE TACTILE GRIP - ADA) S = STOREROOM* P = PASSAGE D = DUMMY E = ENTRY BED = BEDROOM ALUMINUM STOREFRONT HARDWARE: PIVOT HINGES MILL AL. DOAL MITTER STAINDARD MILL AL. DOCKSET FUNCTION MILL AL. DOAL MILL	PROOF STRIKE	ROCKWOOD	570		US26D SATIN	CHROME
DOOR SWEEP HAGER 750SS STAINLESS STEEL W/ SIL BMOKE SEALS PREMKO S88D SILICONE DOOR SILENCERS IVES (3 PER DOOR) NO. 02 WHITE/GREY THRESHOLD REESE S245A MILL AL. DRIP CAP HAGER 810S MILL AL. ATCH GUARD HAGER 332D PANIC BAR VON DUPRIN 98/99L RIM EXIT DEVICE W/ LEVER (KEY LOCK) US26D SATIN CHROMIUM EXIT CONTROL DEVICE DETEX V40 x 36 x CD x ERXW W/ MORTISE CYLINDER- 30-001x118 (PUSH TO OPEN - ALARM WILL SOUND AT EXTERIOR DOORS) S = STOREROOM* C = CLASSROOM O = OFFICE PR = PRIVACY P = PASSAGE D = DUMMY E = ENTRY BED = BEDROOM ALUMINUM STOREFRONT HARDWARE: PMOT HINGES MER STANDARD TO P & BOT. OFFSET PIVOTS MILL AL.	KAGAL	BY DOOR MANUF.	Z TYPE		-	
SMOKE SEALS PREMIKO S88D SILICONE DOOR SILENCERS IVES (3 PER DOOR) NO. 02 WHITE/GREY THRESHOLD REESE S245A MILL AL. DRIP CAP HAGER 810S MILL AL. ATCH GUARD HAGER 332D - PANIC BAR VON DUPRIN DETEX VA0 x 36 x CD x EBXW W/ MORTISE CYLINDER- 30-001x118 (PUSH TO OPEN - ALARM WILL) SOUND AT EXTERIOR DOORS) WEATHER STRIPPING/SWEEP HARDWARE NOTES: LOCKSET FUNCTION KEY (LF): (" LEVER TO RECEIVE TACTILE GRIP - ADA) S = STOREROOM* C = CLASSROOM O = OFFICE P = PRIVACY P = PASSAGE D = DUMMY E = ENTRY BED = BEDROOM MILL AL. MILL AL. MILL AL. WHITE/GREY WHITE/GREY WHITE/GREY WHITE/GREY WHITE/GREY WHILL AL. US26D SATIN CHROMIUM US26D SATIN CHROMIUM SOUND AT EXTERIOR DOORS) US26D SATIN CHROMIUM SOUND AT EXTERIOR DOORS) C = CLASSROOM O = OFFICE PR = PRIVACY P = PASSAGE D = DUMMY E = ENTRY BED = BEDROOM ALUMINUM STOREFRONT HARDWARE: POOT HINGES MER STANDARD TOP & BOT. OFFSET PIVOTS MILL AL.	LOCK	SECURITRON	MM15 SERIES		BLACK	
IVES (3 PER DOOR) NO. 02 WHITE/GREY THRESHOLD REESE S245A MILL AL. DRIP CAP HAGER B10S MILL AL. ATCH GUARD HAGER 332D - WEATHER-STRIPPING/SWEEP -ANY- PANIC BAR VON DUPRIN WEXIT CONTROL DEVICE DETEX VON DUPRIN WOOD AT EXTERIOR DOORS) WHATE/GREY US26D SATIN CHROMIUM SOUND AT EXTERIOR DOORS) LOCKSET FUNCTION KEY (LF): (*LEVER TO RECEIVE TACTILE GRIP - ADA) S = STOREROOM* C = CLASSROOM O = OFFICE PR = PRIVACY P = PASSAGE D = DUMMY E = ENTRY BED = BEDROOM MILL AL. WHITE/GREY WHITE/GREY WHITE/GREY MILL AL. MILL AL. WHITE/GREY WHITE/GREY WHITE/GREY MILL AL. MILL AL. WHITE/GREY WHITE/GREY WHILL AL. MILL AL. WHITE/GREY WHILL AL. MILL AL. WHITE/GREY MILL AL. MILL AL. MILL AL. WHITE/GREY MILL AL. MILL AL. MILL AL. WHITE/GREY MILL AL. MILL A	R SWEEP	HAGER	750SS		STAINLESS STEEL W/ SILICONE	
THRESHOLD REESE S245A MILL AL. DRIP CAP HAGER B10S MILL AL. ATCH GUARD HAGER 332D - NEATHER-STRIPPING/SWEEP - ANY - PANIC BAR VON DUPRIN 98/99L RIM EXIT DEVICE W/ LEVER (KEY LOCK) US26D SATIN CHROMIUM EXIT CONTROL DEVICE DETEX V40 x 36 x CD x EBXW W/ MORTISE CYLINDER- 30-001x118 (PUSH TO OPEN - ALARM WILL) SOUND AT EXTERIOR DOORS) COLLER CATCH - ANY HARDWARE NOTES: LOCKSET FUNCTION KEY (LF): (* LEVER TO RECEIVE TACTILE GRIP - ADA) S = STOREROOM* C = CLASSROOM O = OFFICE PR = PRIVACY P = PASSAGE D = DUMMY E = ENTRY BED = BEDROOM ALUMINUM STOREFRONT HARDWARE: PHOT HINGES MFR STANDARD TOP & BOT. OFFSET PIVOTS MILL AL.	KE SEALS	PREMKO	S88D		SILICONE	
DRIP CAP HAGER 810S MILL AL. LATCH GUARD HAGER 332D - WEATHER-STRIPPING/SWEEP - ANY - PANIC BAR VON DUPRIN 98/99L RIM EXIT DEVICE W/ LEVER (KEY LOCK) US26D SATIN CHROMIUM EXIT CONTROL DEVICE DETEX V40 x 36 x CD x EBXW W/ MORTISE CYLINDER - 30-001x118 (PUSH TO OPEN - ALARM WILL SOUND AT EXTERIOR DOORS) ROLLER CATCH - ANY HARDWARE NOTES: - LOCKSET FUNCTION KEY (LF): (* LEVER TO RECEIVE TACTILE GRIP - ADA) S = STOREROOM* C = CLASSROOM O = OFFICE PR = PRIVACY P = PASSAGE D = DUMMY E = ENTRY BED = BEDROOM ALUMINUM STOREFRONT HARDWARE: PVOT HINGES MFR STANDARD TOP & BOT. OFFSET PIVOTS MILL AL.	R SILENCERS	IVES (3 PER DOOR)	NO. O2	NO. O2		
ATCH GUARD HAGER 332D - WEATHER-STRIPPING/SWEEP - ANY - PANIC BAR VON DUPRIN 98/99L RIM EXIT DEVICE W/ LEVER (KEY LOCK) US26D SATIN CHROMIUM STOREFRONT HARDWARE: POULER CATCH C = CLASSROOM O = OFFICE PR = PRIVACY De DUMMY E = ENTRY BED = BEDROOM ALUMINUM STOREFRONT HARDWARE: PROSED SATIN CHROMIUM OF SATIN CHROMIUM STOREFRONT HARDWARE: POULER CATCH - ANY	SHOLD	REESE	S245A	S245A		
WEATHER-STRIPPING/SWEEP - ANY	CAP	HAGER	810S		MILL AL.	
PANIC BAR VON DUPRIN 98/99L RIM EXIT DEVICE W/ LEVER (KEY LOCK) US26D SATIN CHROMIUM VAO X 36 × CD × EBXW W/ MORTISE CYLINDER - 30-001x118 (PUSH TO OPEN - ALARM WILL SOUND AT EXTERIOR DOORS) ROLLER CATCH -ANY - -AN	H GUARD	HAGER	332D		-	
EXIT CONTROL DEVICE DETEX V40 x 36 x CD x EBXW W/ MORTISE CYLINDER - 30-001x118 (PUSH TO OPEN - ALARM WILL SOUND AT EXTERIOR DOORS) ROLLER CATCH -ANY- HARDWARE NOTES: LOCKSET FUNCTION KEY (LF): (* LEVER TO RECEIVE TACTILE GRIP - ADA) S = STOREROOM* C = CLASSROOM O = OFFICE P = PRIVACY P = PASSAGE D = DUMMY E = ENTRY BED = BEDROOM ALUMINUM STOREFRONT HARDWARE: PVOT HINGES MFR STANDARD TOP & BOT. OFFSET PIVOTS MILL AL.	THER-STRIPPING/SWEEP	- ANY -	-		-	
SOUND AT EXTERIOR DOORS) ROLLER CATCH -ANY				,	US26D SATIN CHROMIUM	
HARDWARE NOTES: LOCKSET FUNCTION KEY (LF): (* LEVER TO RECEIVE TACTILE GRIP - ADA) S = STOREROOM* C = CLASSROOM O = OFFICE PR = PRIVACY P = PASSAGE D = DUMMY E = ENTRY BED = BEDROOM ALUMINUM STOREFRONT HARDWARE: POYOT HINGES MFR STANDARD TOP & BOT. OFFSET PIVOTS MILL AL.	CONTROL DEVICE	DETEX	30-001x118 (PUS	SH TO OPEN - ALARM WILL	US26D SATIN CHROMIUM	
LOCKSET FUNCTION KEY (LF): (* LEVER TO RECEIVE TACTILE GRIP - ADA) S = STOREROOM* C = CLASSROOM O = OFFICE PR = PRIVACY P = PASSAGE D = DUMMY E = ENTRY BED = BEDROOM ALUMINUM STOREFRONT HARDWARE: PIVOT HINGES MFR STANDARD TOP & BOT. OFFSET PIVOTS MILL AL.	ER CATCH	- ANY -	-		-	
S = STOREROOM* C = CLASSROOM O = OFFICE PR = PRIVACY BED = BEDROOM ALUMINUM STOREFRONT HARDWARE: PIVOT HINGES MFR STANDARD TOP & BOT. OFFSET PIVOTS MILL AL.	ARDWARE	NOTES:				
PIVOT HINGES MFR STANDARD TOP & BOT. OFFSET PIVOTS MILL AL.	STOREROOM* C	= CLASSROOM	O = OFFICE	PR = PRIVACY	ILE GRIP - ADA)	
	UMINUM S	TOREFRO	AH TNC	RDWARE:		
FUDEOULOU D. DEFOR						
		REESE		S245A	N	MILL AL.
WEATHER-STRIPPING/SWEEP MFR STANDARD STANDARD TYPE -					-	
CLOSER LCN (OR EQUAL) 2034 BLACK		,				
		`	· · · · · · · · · · · · · · · · · · ·			BLACK ANODIZED
· · · · · · · · · · · · · · · · · · ·		`				BLACK ANODIZED

SEE SPEC. FOR TYPE

BLACK ANODIZED

PUSH

KAWNEER (OR EQUAL)

DOOR & FRAME REMARKS: (#)

- 1) PROVIDE PRIVACY LOCKSET W/ OCCUPIED/UNOCCUPIED INDICATOR
- 2) PROVIDE TORNADO RATED DOOR (ZONE 5) EQUAL TO STEELCRAFT DOOR SYSTEM (PW14 PALADIN) FEMA P-361 (2024) RATED WITH FACTORY INSTALLED LIGHT KITS. DOOR 114 ONLY.
- 3) ALUMINUM FRAME (THERMAL BREAK) W/ 1" INSULATED LOW-E GLAZING TINTED SOLAR GREY. FRAME TO BE BLACK ANODIZED FINISH
- 4) ALUMINUM FRAME W/ 1/4" CLEAR GLAZING. FRAME TO BE BLACK ANODIZED FINISH

DOOR & FRAME GENERAL NOTES:

- A. ALL HARDWARE FOR DOORS IN THE MEANS OF EGRESS SHALL CONFORM TO NFPA NO. 101 AND IBC 2021.
- B. ALL EXTERIOR DOORS TO HAVE NON RISING FIXED HINGE PINS, DRIP CAPS AND WEATHER STRIPPING, UNLESS NOTED OTHERWISE.
- C. ALL HOLLOW METAL DOORS & FRAMES TO BE PAINTED.
- D. OPENINGS WITH CLOSER AND NO WALL / FLOOR STOP TO USE STOP ARM CLOSER.
- E. ALL GLAZING SHALL BE TEMPERED WHERE REQUIRED BY CODE.
- F. ALL EXTERIOR HOLLOW METAL DOORS AND FRAMES TO BE GALVANIZED,G. VERIFY WITH MECHANICAL DRAWINGS DOORS THAT NEED TO BE UNDERCUT 1" IF ANY.
- H. MINIMUM PERFORMANCE RATING FOR NEW COMMERCIAL STOREFRONTS (FIXED): U-FACTOR 0.36, SHGC 0.38 (IN COMPLIANCE WITH SECTION C402.4 OF THE 2021 IECC).
- I. ALL EXTERIOR DOORS & WINDOWS SHALL COMPLY WITH SECTION C402 OF THE 2021 IECC.
- J. PER SECTION IAC 404.2.5, 404.2.7, 404.2.8, 404.2.9: "DOOR HARDWARE SHALL BE CAPABLE OF OPERATION WITH THE USE OF ONE (1) HAND AND SHALL NOT REQUIRE TIGHT PINCHING, TIGHT GRASPING OR TWISTING OF THE WRIST TO OPERATE. THUMBTURN DEADBOLTS/LOCKS ARE PROHIBITED; LEVER OR PADDLE DEADBOLT/LOCK RELEASES ARE ACCEPTABLE. DOOR THRESHOLD SHALL NOT EXCEED ONE-HALF INCH (1/2") IN HEIGHT, THRESHOLDS EXCEEDING ONE QUARTER INCH (1/4") IN HEIGHT SHALL. THE FORCE FOR PULLING OR PUSHING A DOOR SHALL NOT BE MORE THAN EIGHT-AND-A-HALF POUNDS (8 1/2 LBS). FOR EXTERIOR DOORS (8-1/2 LBS) AND FOR INTERIOR DOORS (5 LBS).



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New Building

for

Forest Preserves of Winnebago County

Meridian Rd., Winnebago County, Illinois

THE CONTRACTOR SHALL DETERMINE EXACT DIMENSIONS AND CONDITIONS AT THE SITE PRIOR TO SUBMITTING A BID. THE CONTRACTOR SHALL COORDINATE ALL DRAWINGS WITH ACTUAL FIELD CONDITIONS PRIOR TO PROCEEDING WITH THE WORK AND NOTIFY THE ARCHITECT OF ANY DISCREPANCIES. THIS DRAWING IS THE PROPERTY OF BLAKEMORE ARCHITECTS AND MAY NOT BE REPRODUCED WITHOUT THE PRIOR WRITTEN PERMISSION OF THE ARCHITECT.

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BA P	roject No.		2025-09

Scale


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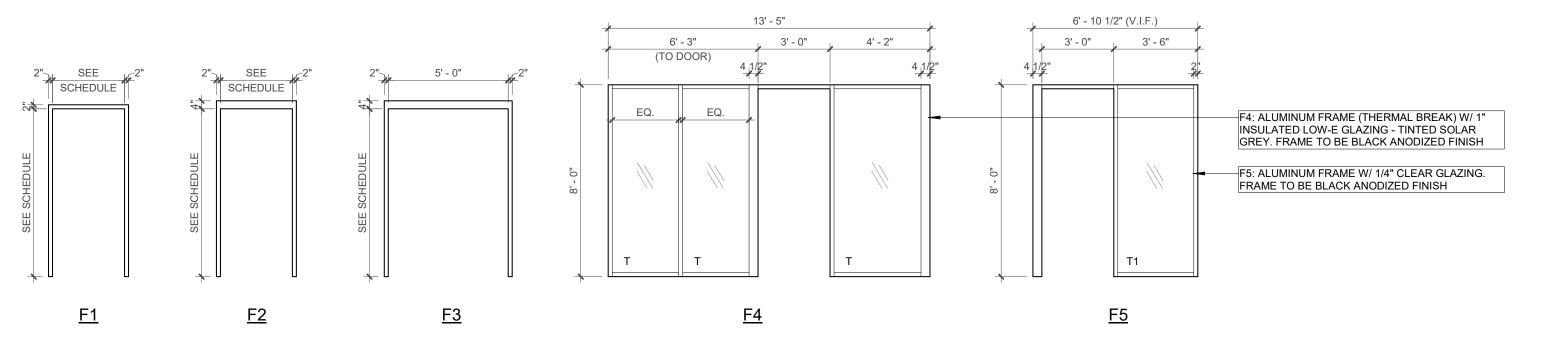
DOOR & FRAME SCHEDULES

Ref. North

106


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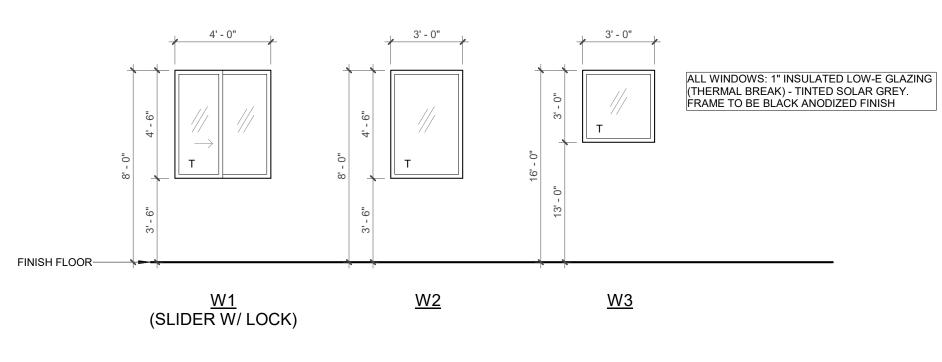
FRAME TYPES

1/4" = 1'-0"

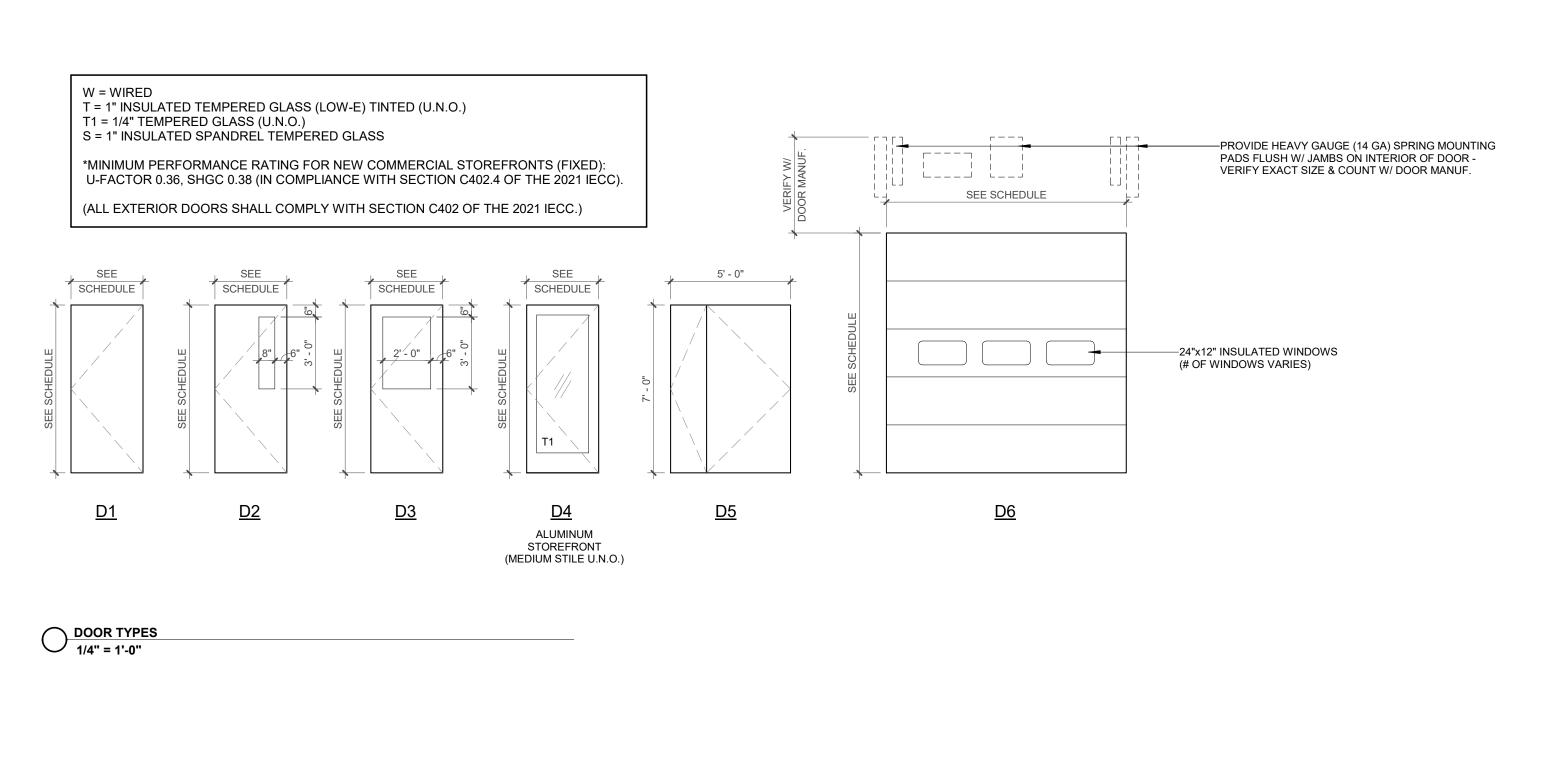

BORROWED LIGHT TYPES

1/4" = 1'-0"

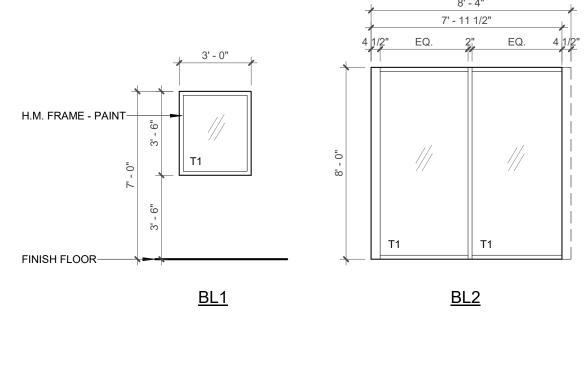

WINDOW TYPES

1/4" = 1'-0"



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BA F	Project No.	2025-09
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DOOR & FRAME TYPES


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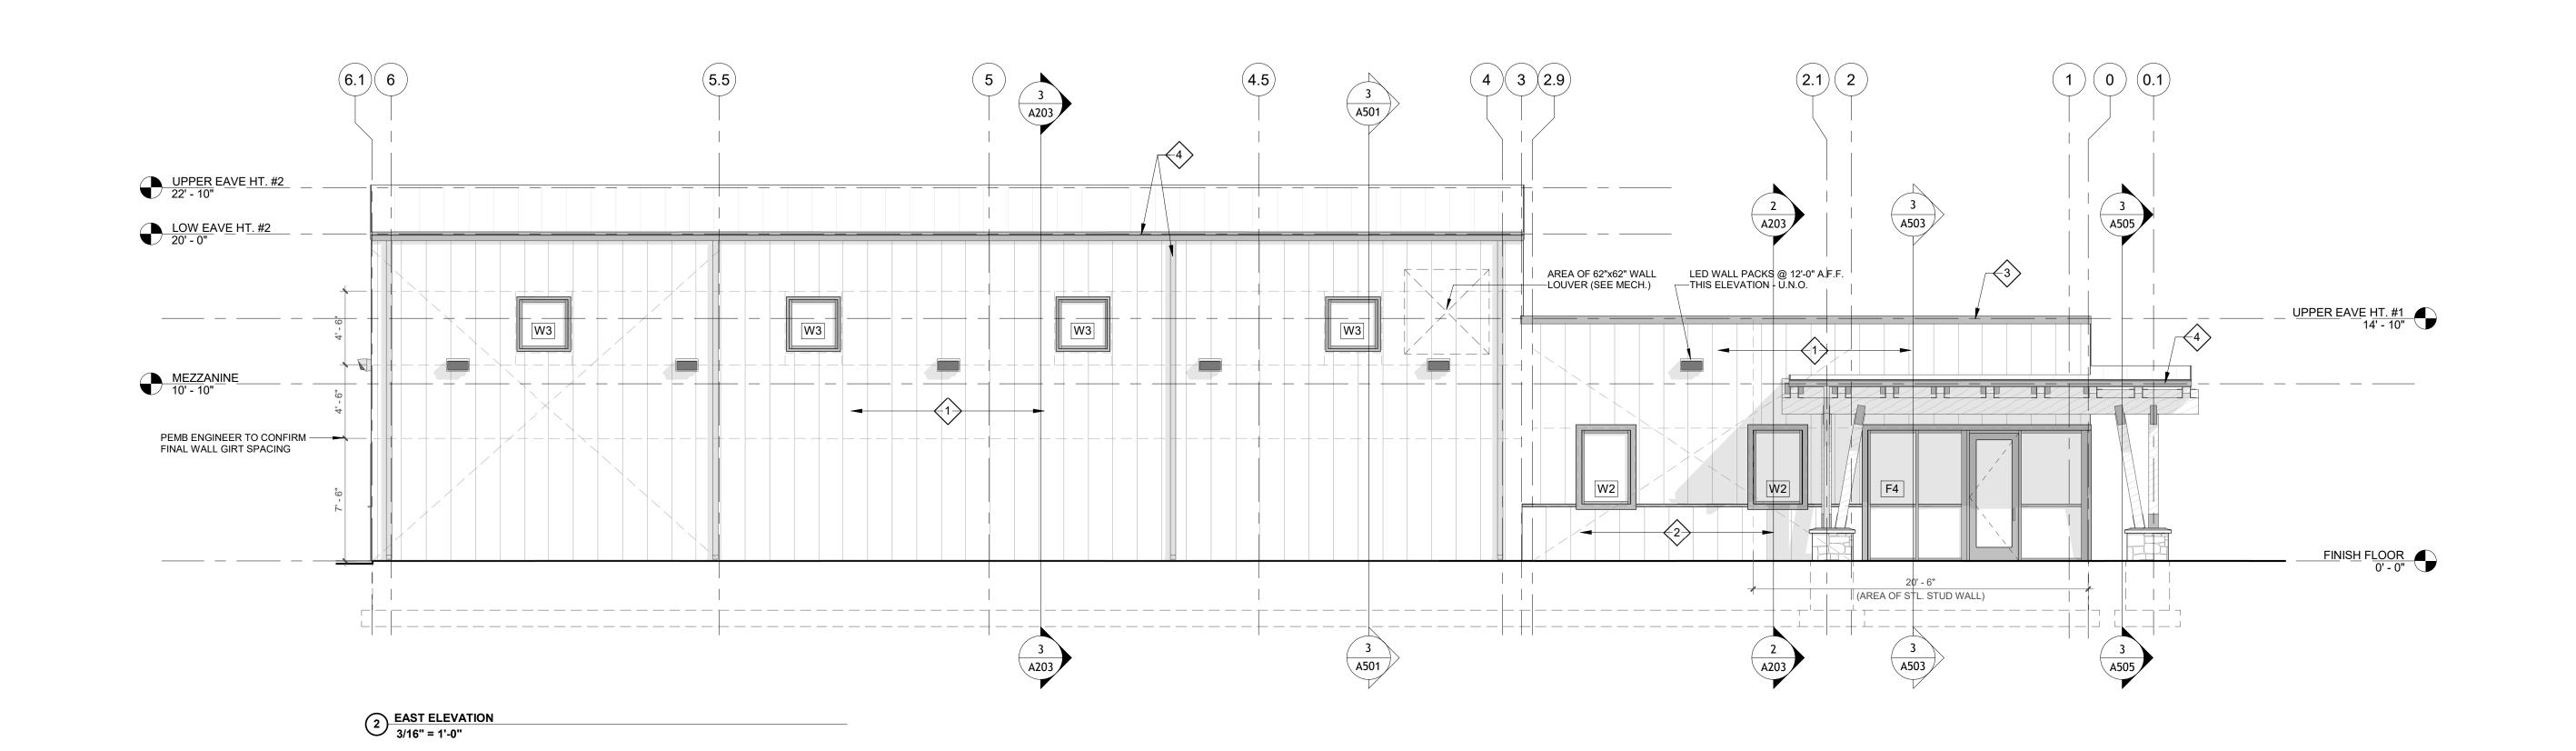
Sheet Title

Sheet No.

1/4" = 1'-0"

A107



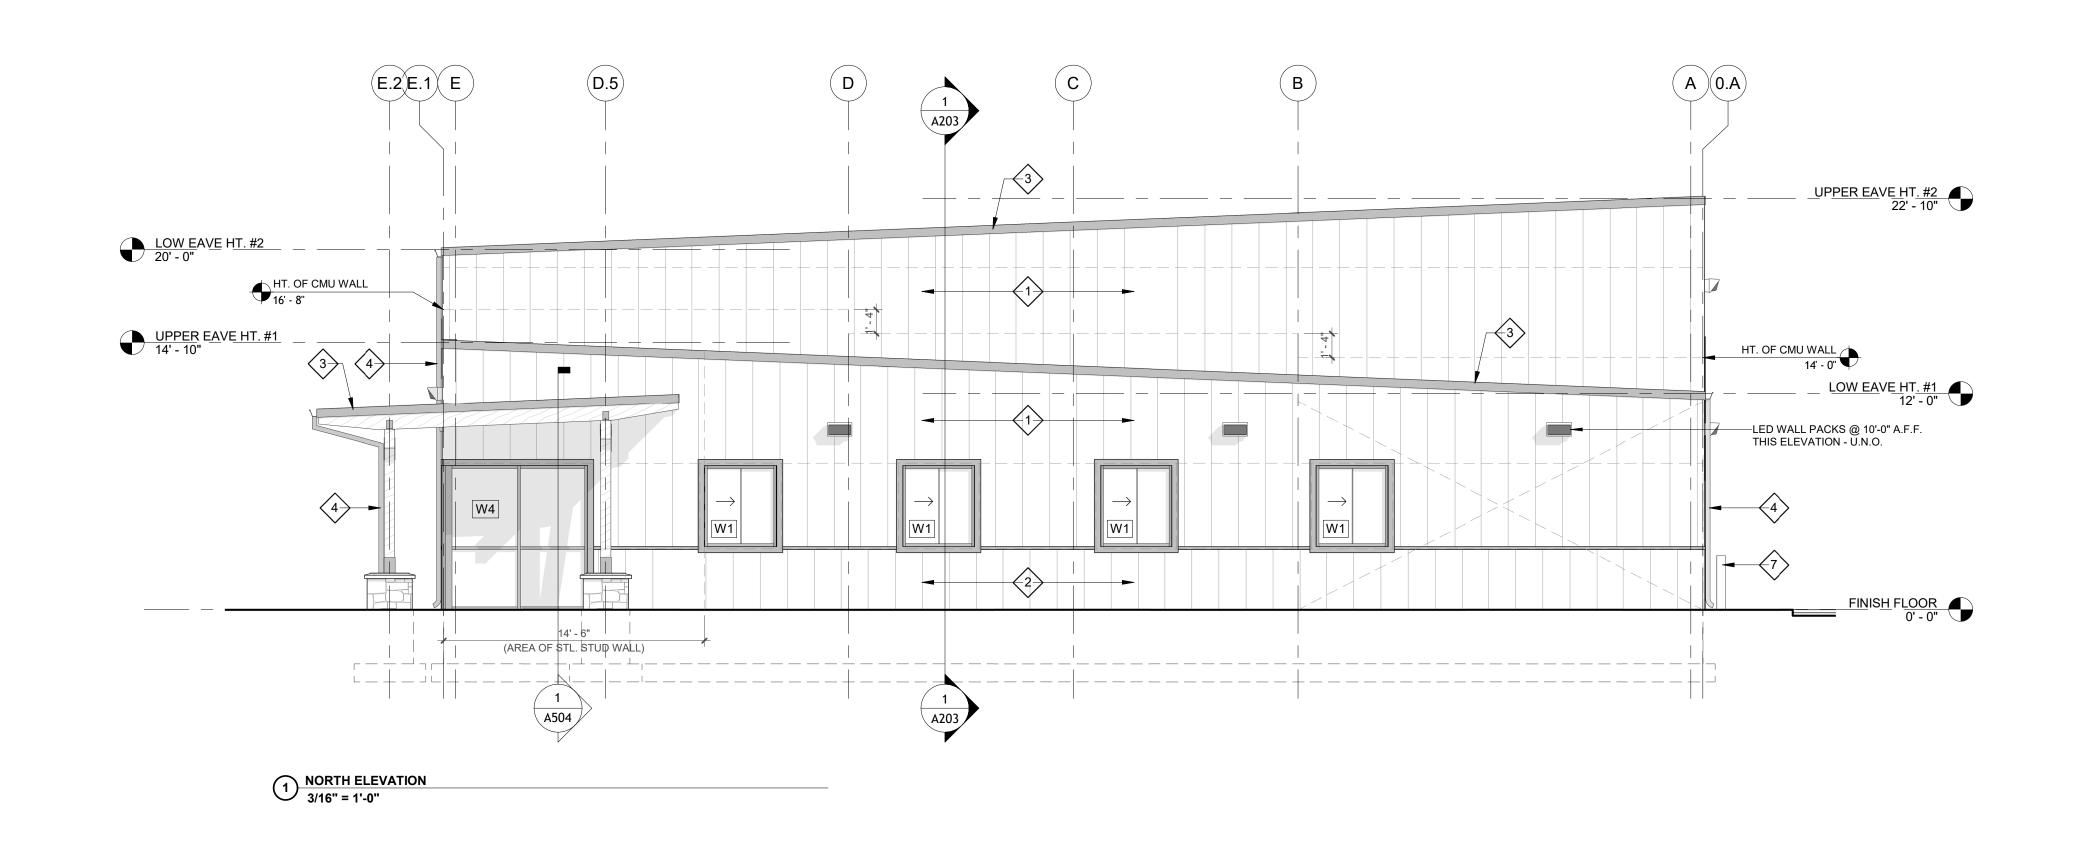

ELEVATION KEY NOTES

1) METAL WALL PANELS BY PEMB MANUF.: 24 GA "AP" SIDE WALL PANELS IN "ASH GRAY"

METAL WALL PANELS: PAC-CLAD BOARD & BATTEN WALL PANELS @ 12" O.C. IN "CHARCOAL GRAY" -OR SIMILAR-

4) GUTTER SYSTEM W/ LEAF GUARDS & DOWNSPOUTS BY PEMB MANUF. IN "BLACK"

5) EXTERIOR HOLLOW METAL DOORS: PAINT TO MATCH "T.B.D."

A) ALL METAL WALL PANELS TO COME WITH ALL FLASHING, TRIMS & END CAPS - VERIFY COLORS WITH ARCHITECT.

6) RAYNOR TM220 SECTIONAL STEEL DOORS: COLOR TO MATCH "WHITE"

GENERAL NOTES:

7) PIPE BOLLARD: COLOR "T.B.D." - SEE 3/A602 FOR PIPE BOLLARD DETAILS

PRE-FINISHED METAL COPING BY PEMB MANUF.: COLOR TO



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BA I	Project	No.	2025-09

Scale

3/16" = 1'-0"


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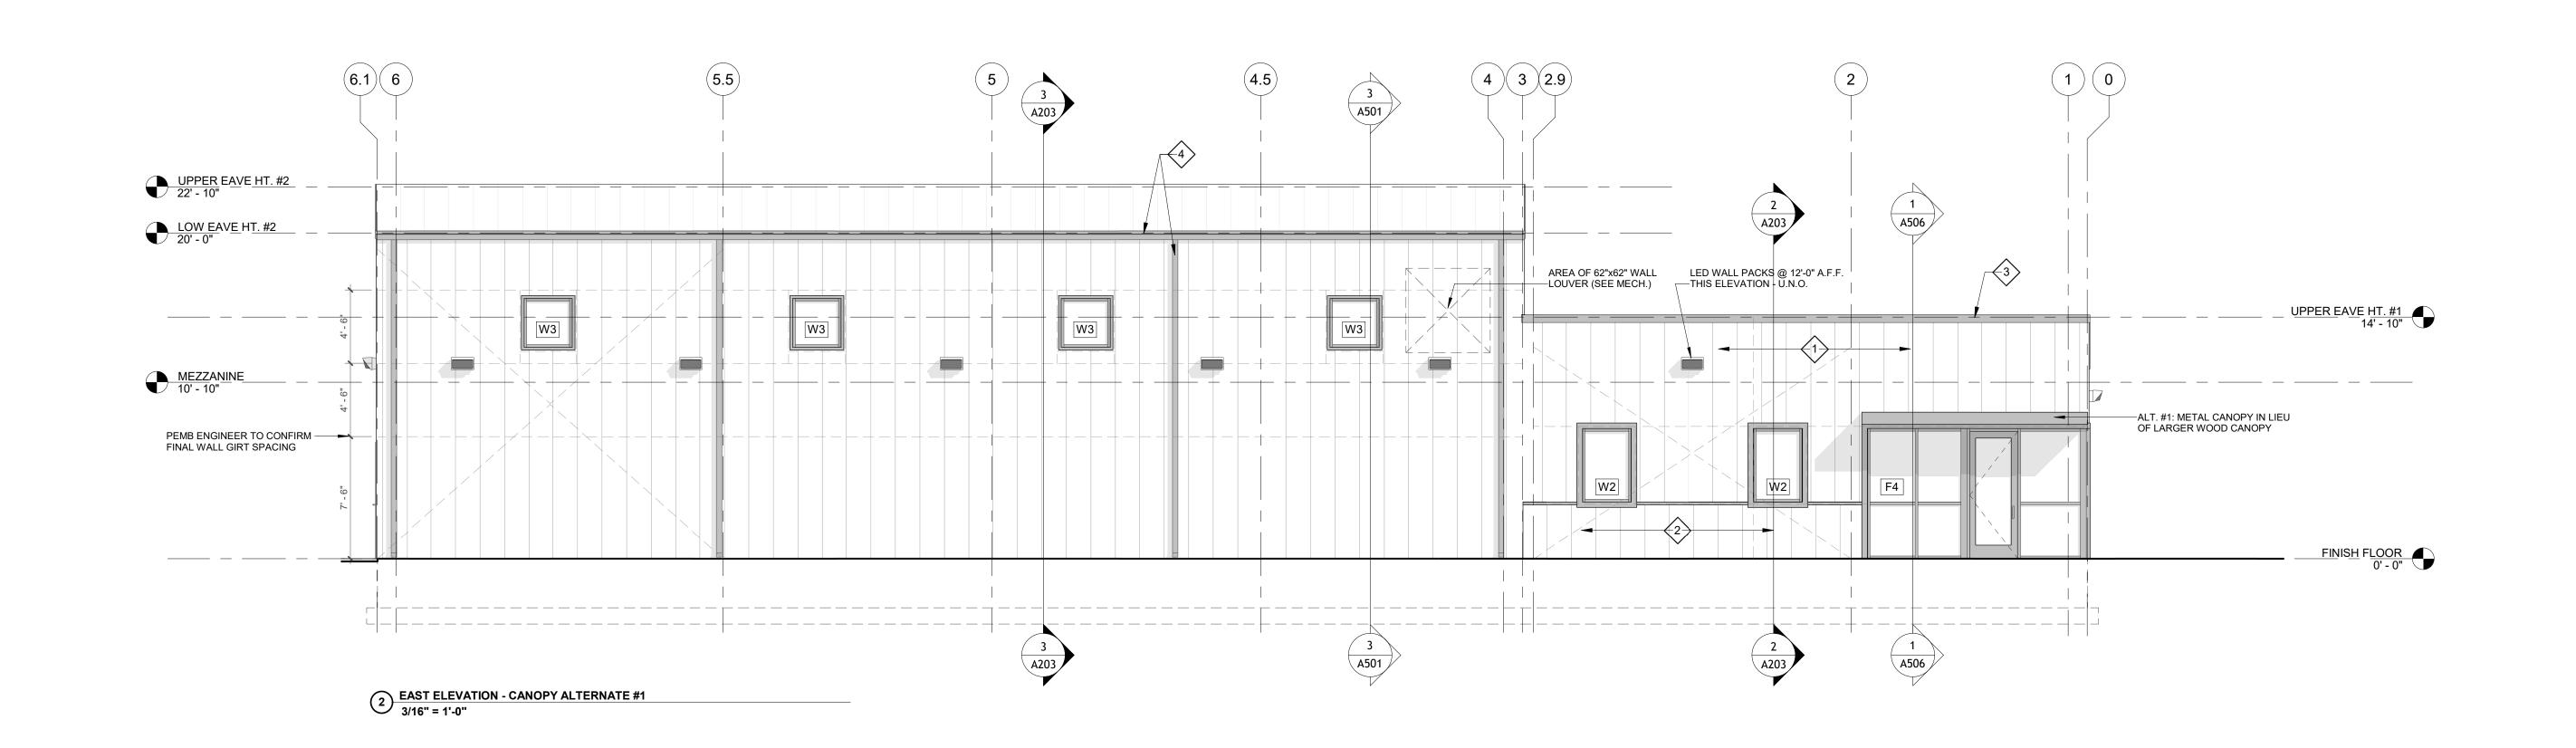
BUILDING ELEVATIONS

Ref. North

Sheet No.

A201



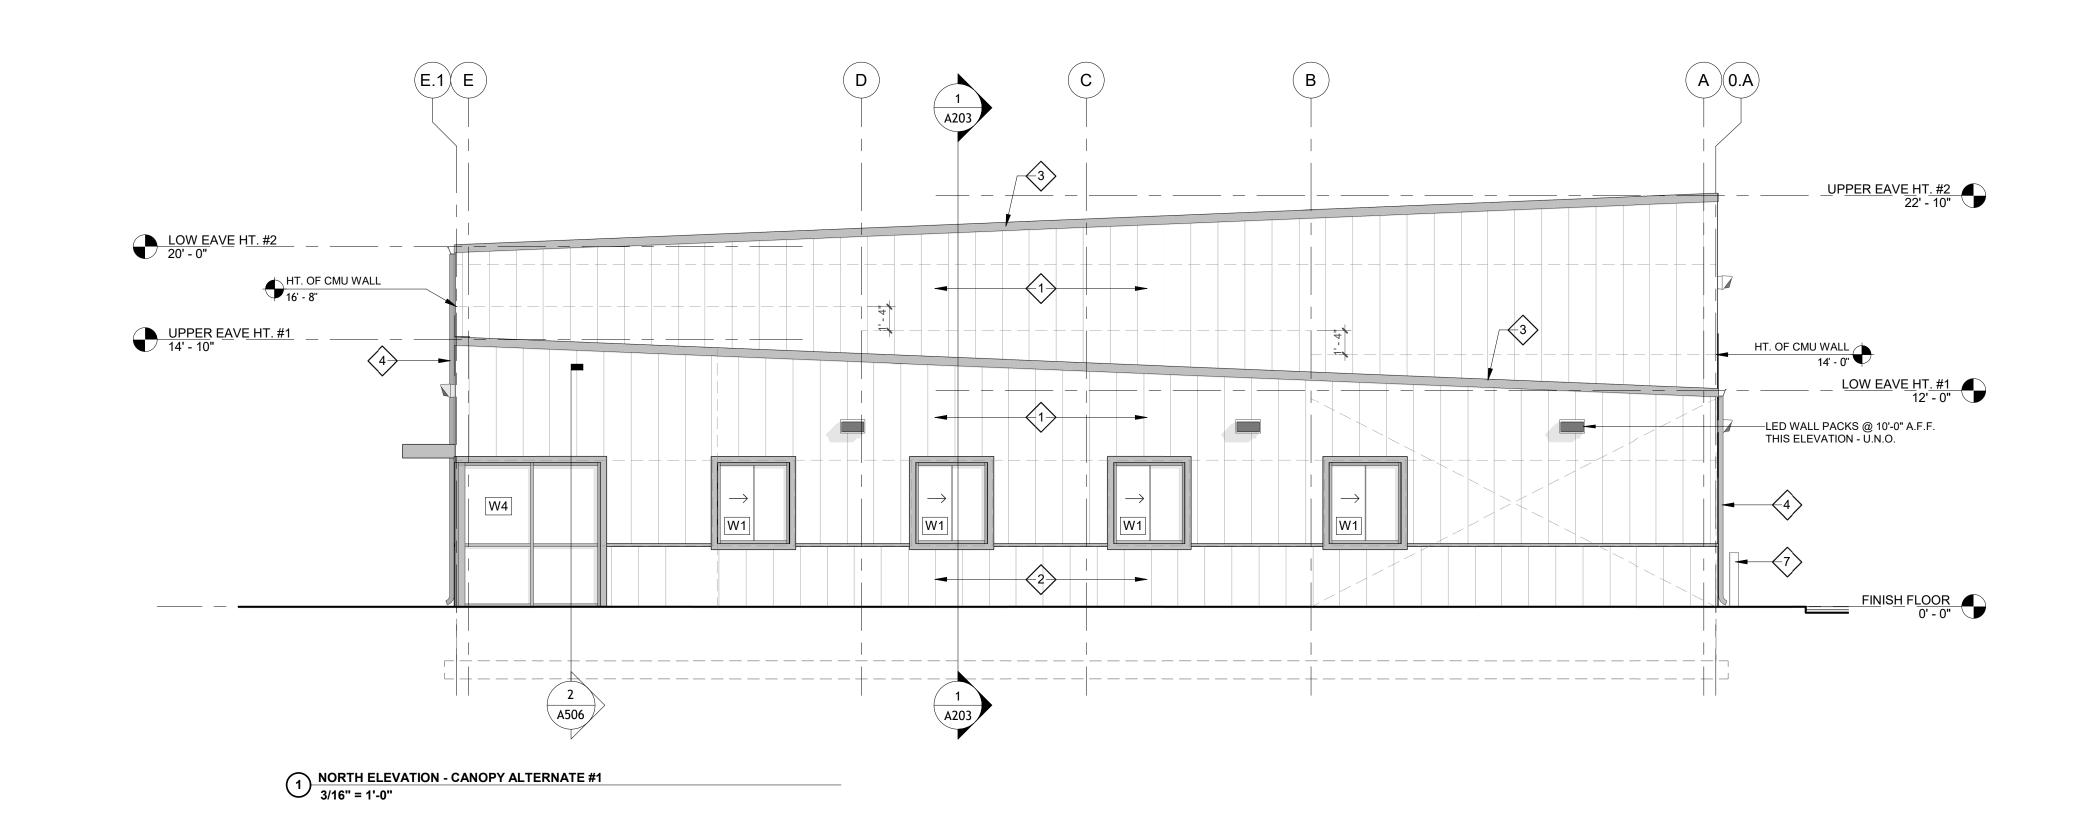

ELEVATION KEY NOTES

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GENERAL NOTES:

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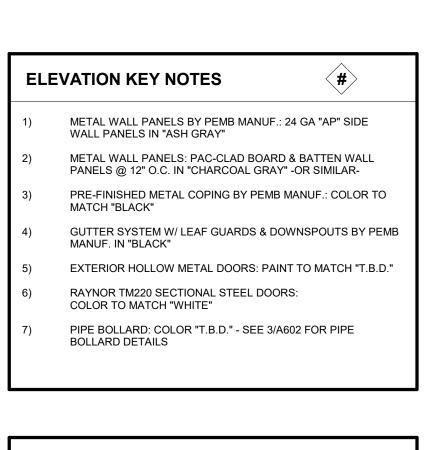
Sheet Title

BUILDING ELEVATIONS - CANOPY ALTERNATE #1

Ref. North


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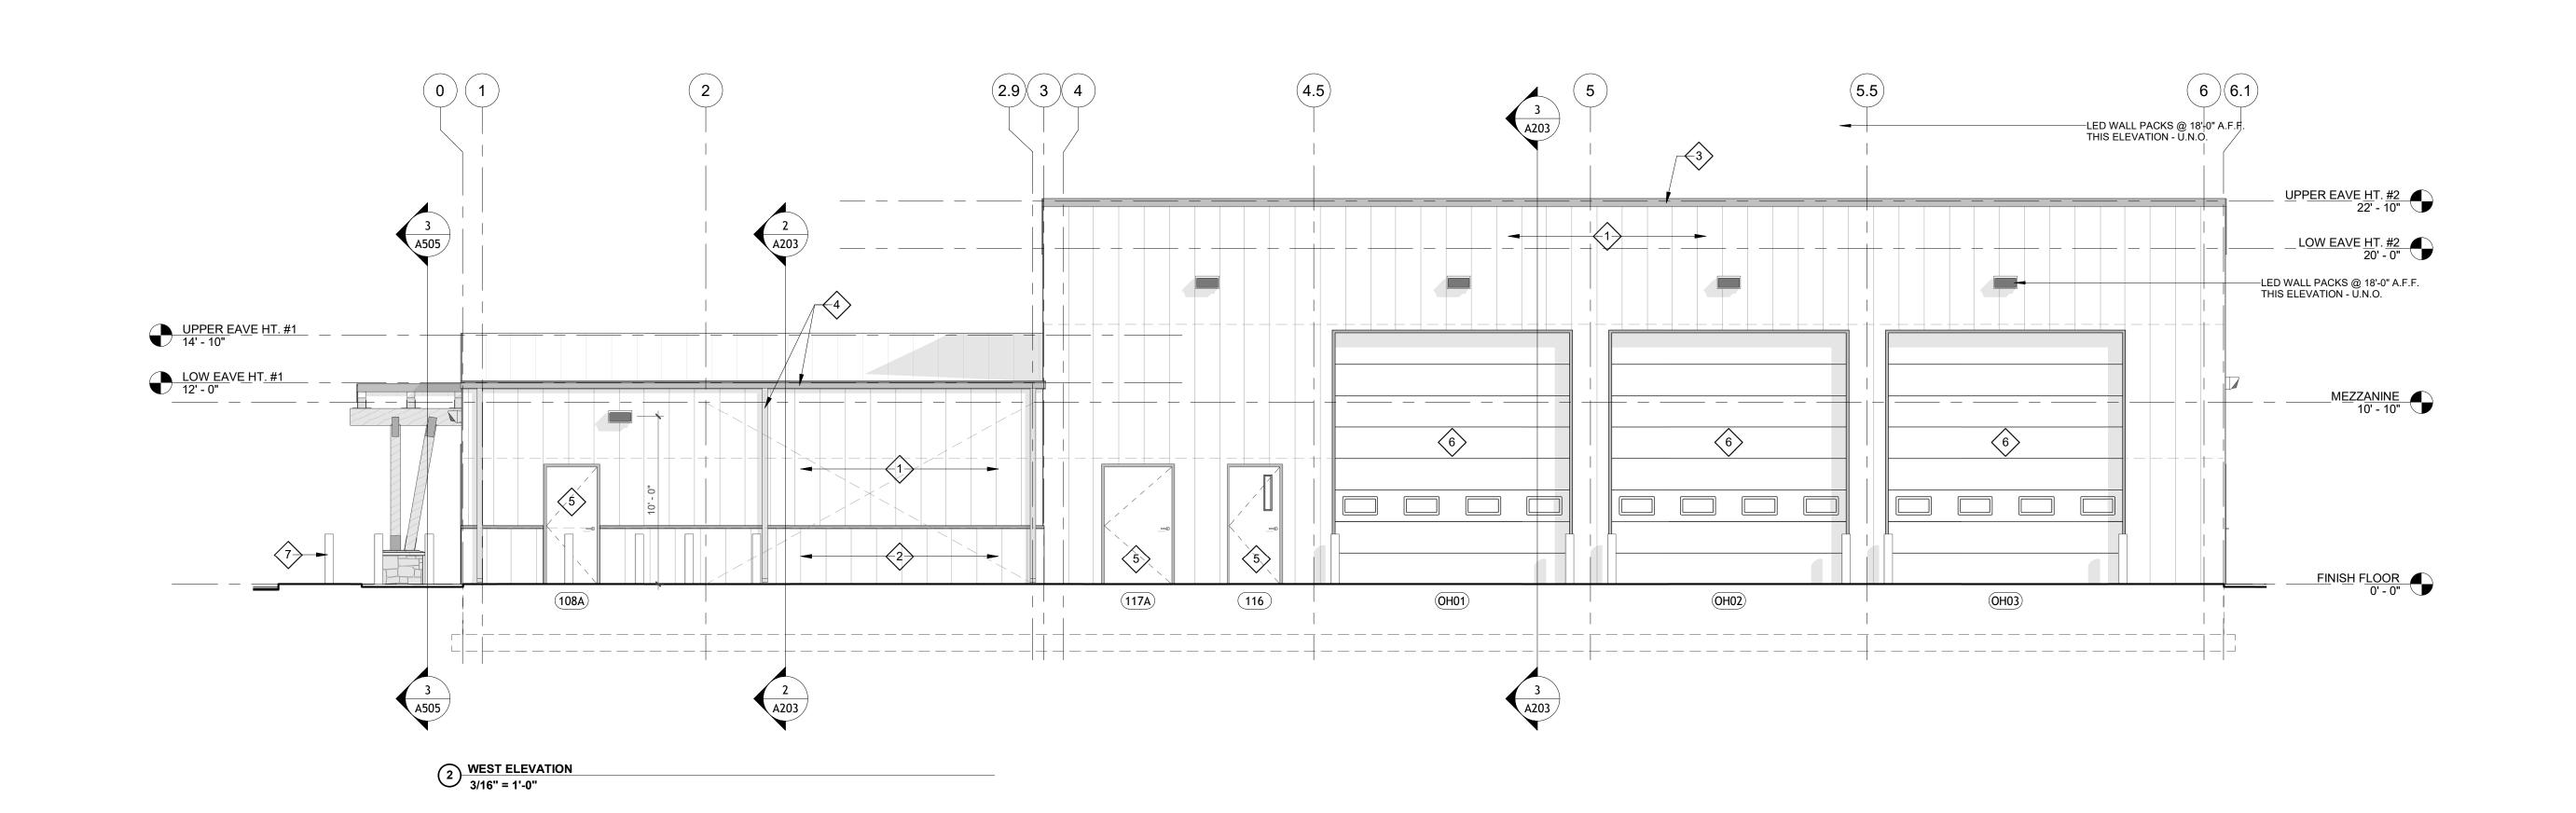
A201-A



GENERAL NOTES:

A) ALL METAL WALL PANELS TO COME WITH ALL FLASHING, TRIMS & END CAPS - VERIFY COLORS WITH ARCHITECT.



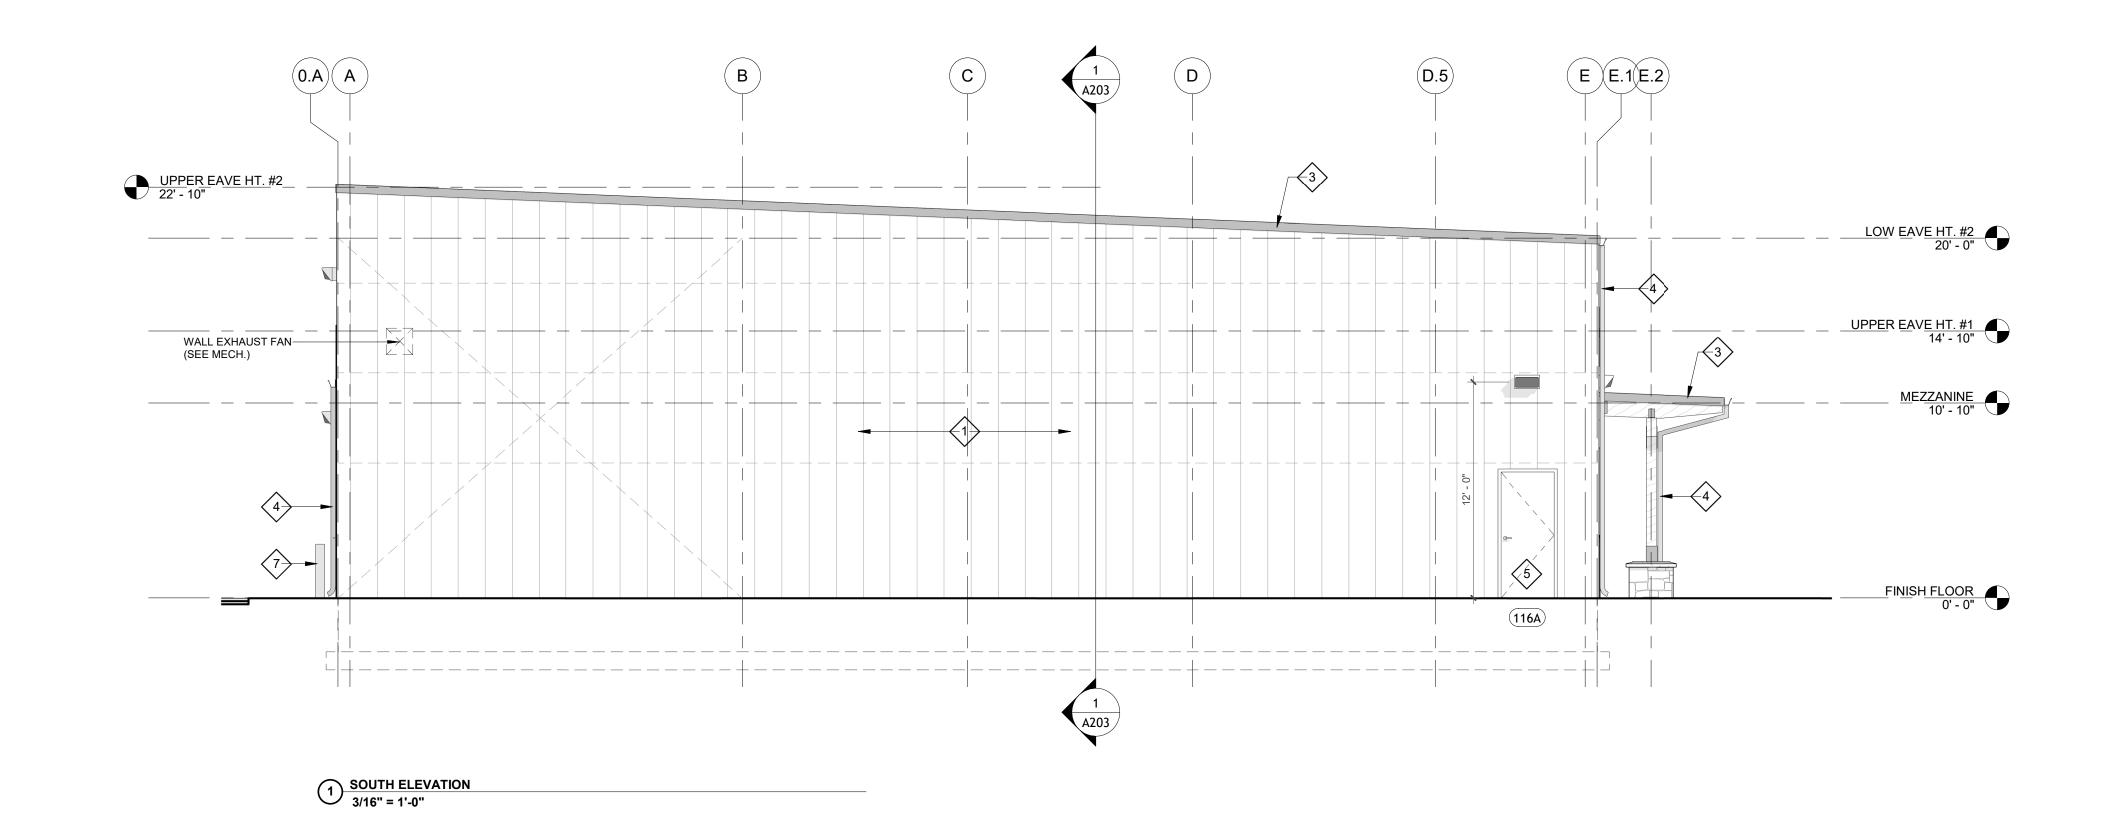



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New Building

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BUILDING ELEVATIONS

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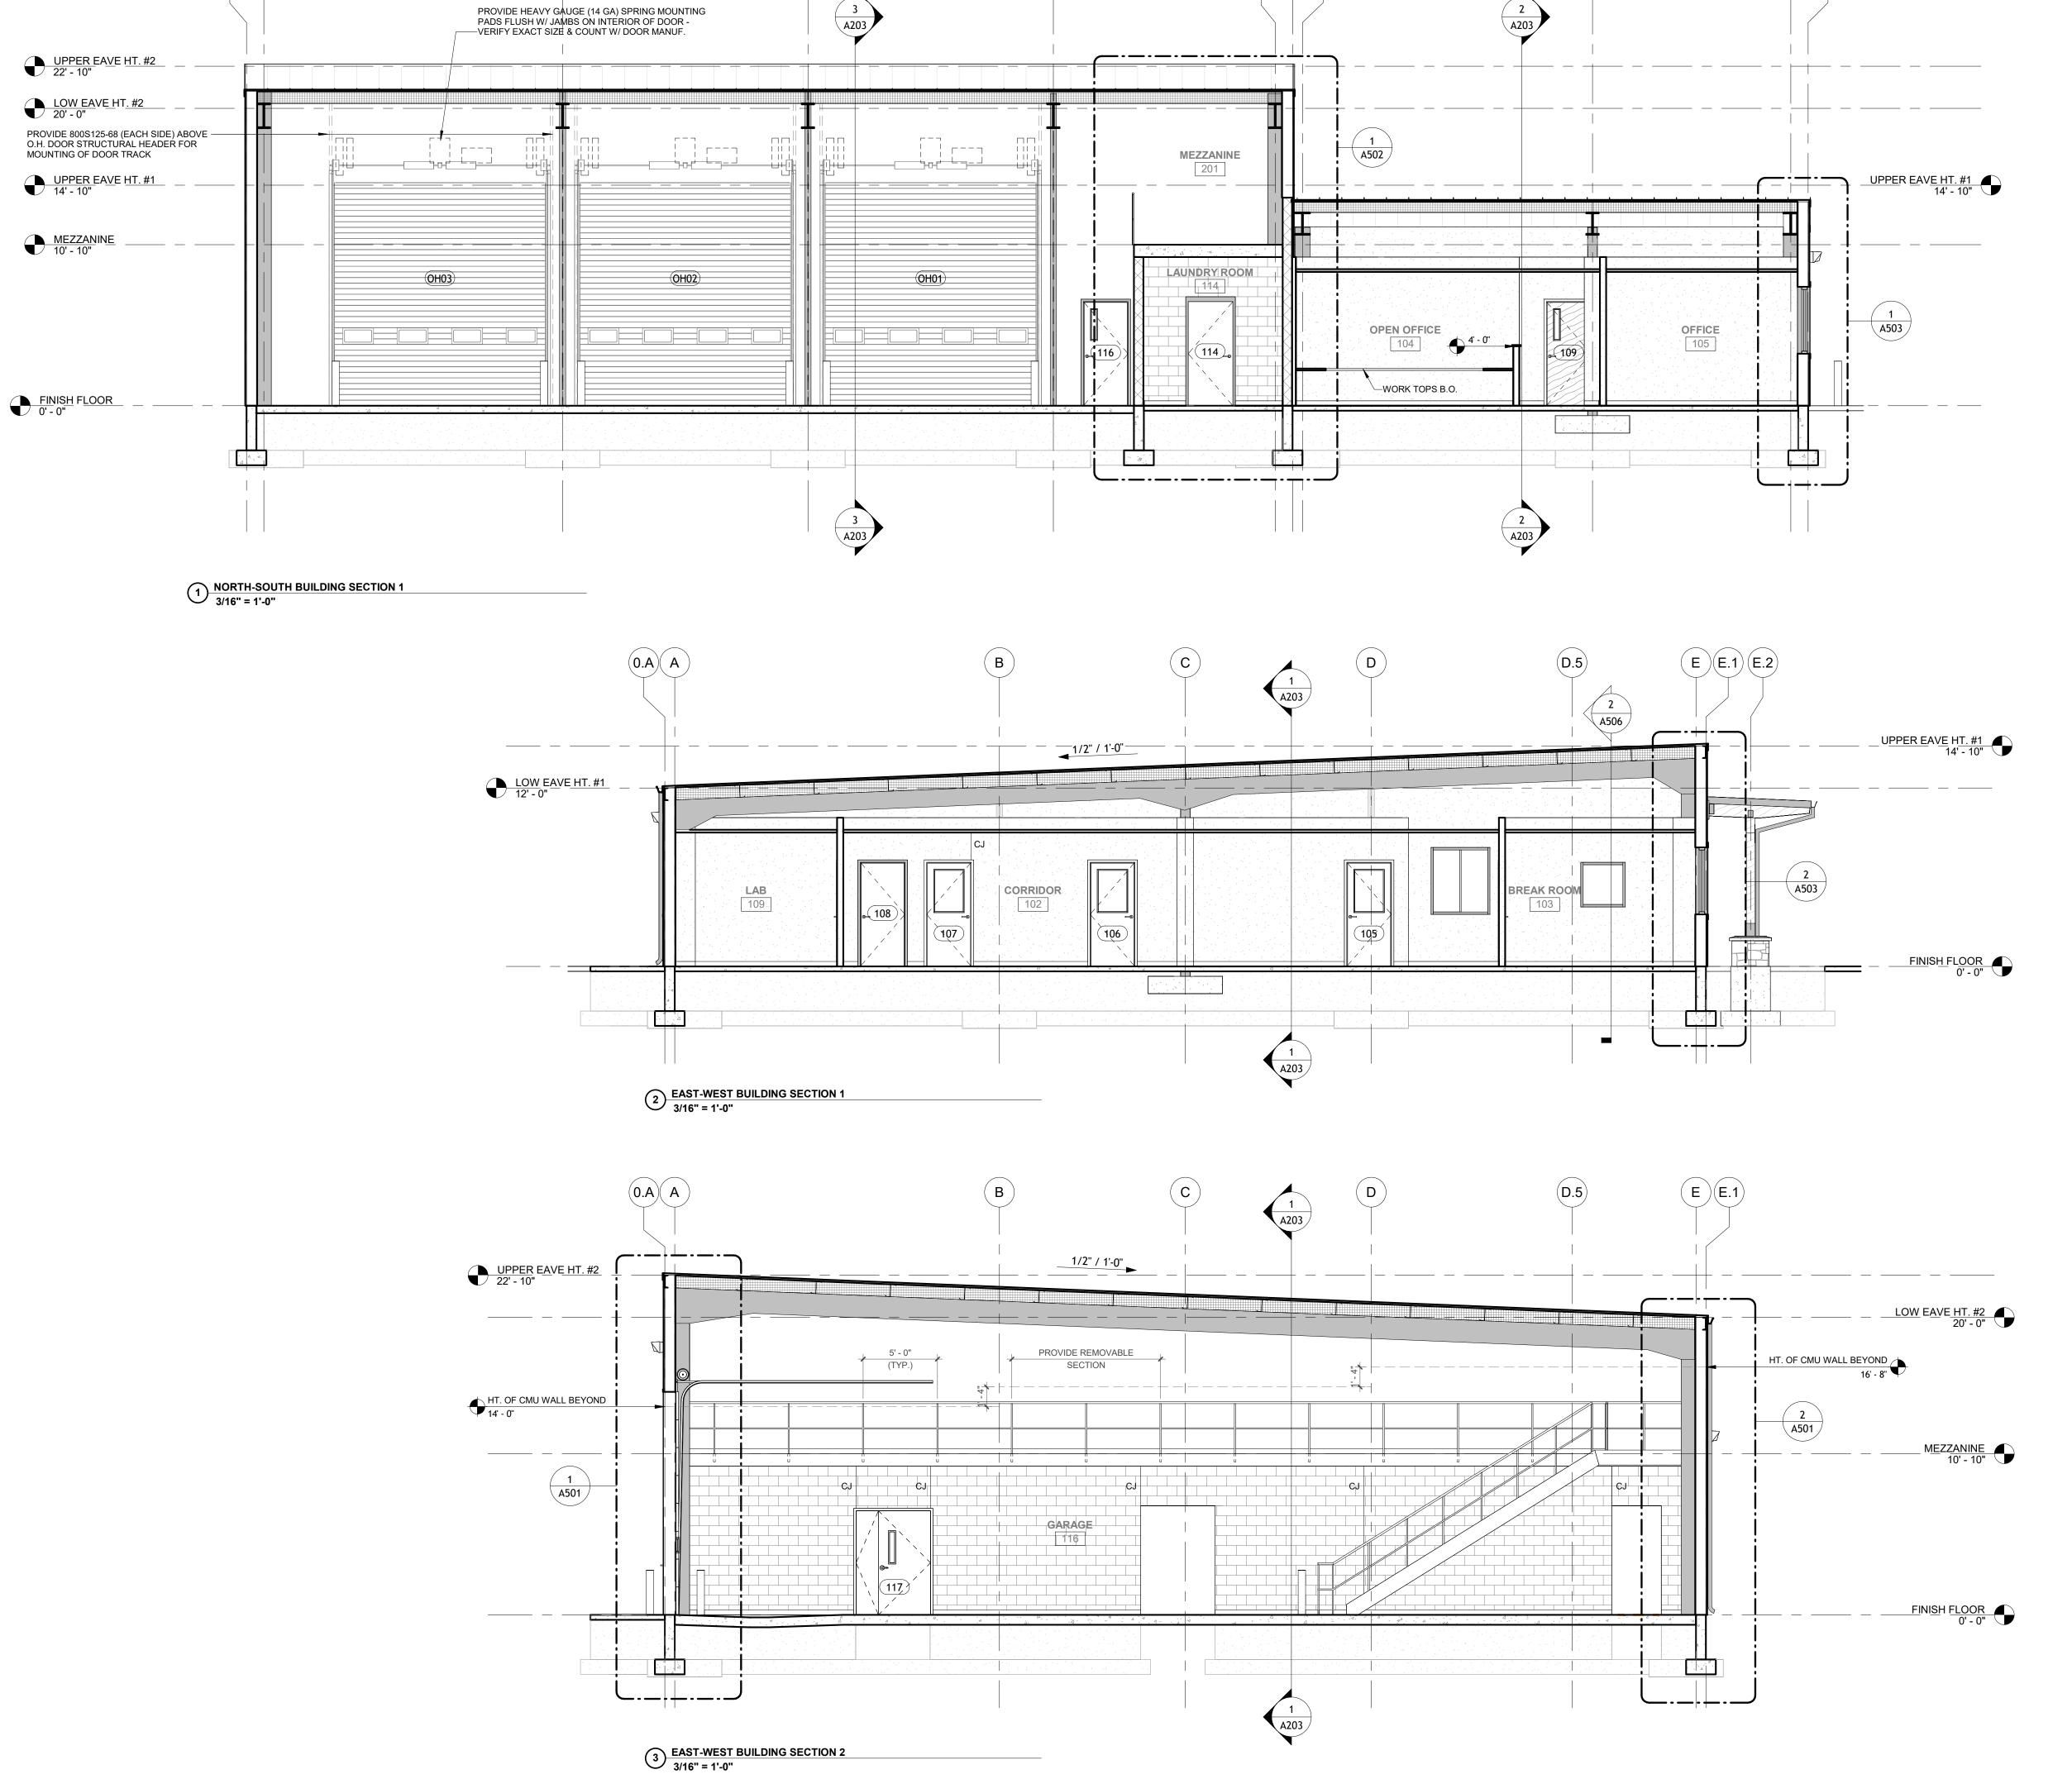
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Sheet Title

Sheet No.

3/16" = 1'-0"

A202



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(6.1)(6)

(5.5)



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BA Project No.

Scale

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Sheet Title

BUILDING SECTIONS


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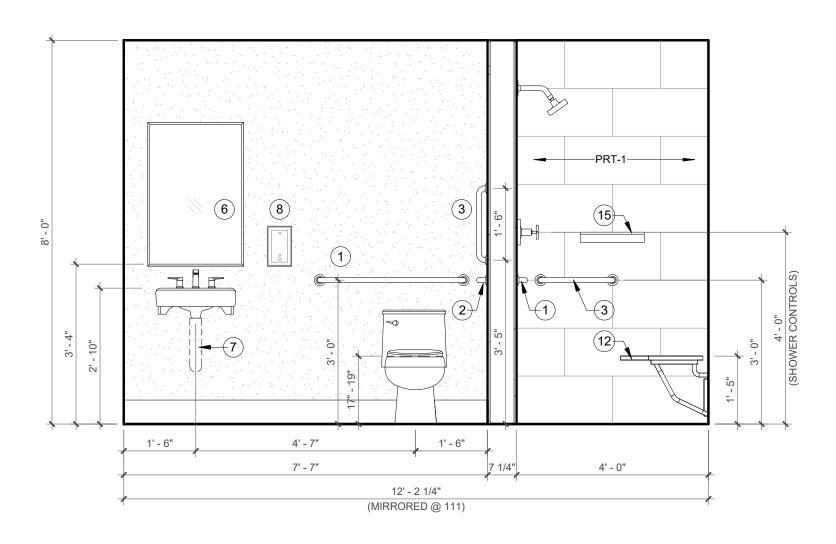
2025-09

# ACCESSORY SCHEDULE					LOCATION / QUANTITY			
				UNISEX	UNISEX	UTILITIES	-	
ГЕМ	MANUFACTURER	MODEL NUMBER	DESCRIPTION	(110)	(111)	(108)		
1	BRADLEY	812	GRAB BAR, STRAIGHT, 36" L, 1 1/2" DIA.	2	2	-	-	
2	BRADLEY	812	GRAB BAR, STRAIGHT, 42" L, 1 1/2" DIA.	1	1	-	-	
3	BRADLEY	812	GRAB BAR, INSTALL VARIES, 18" L, 1 1/2" DIA.	2	2	-	-	
4	BRADLEY	5402	SURF. MOUNTED TOILET ROLL DISPENSER	1	1	-	-	
5	BRADLEY	235-10	SEMI-RECESSED PAPER TOWEL DISPENSER & WASTE RECEPTACLE	1	1	-	-	
6	BRADLEY	780-2436	MIRROR W/ CLIP FASTENERS 24" x 36"	1	1	-	-	
7	TRUEBRO		*LAV GUARD 2 - UNDERSINK PIPING COVER	1	1	-	-	
8	BRADLEY		SURF. MOUNTED SOAP DISPENSER	1	1	-	-	
9			ADA TOILET ROOM SIGNAGE	1	1	-	-	
10			UTILITY SINK (SEE PLUMBING DRAWINGS)	-	-	1	-	
11	BOBRICK	B-239 x 34	MOP / BROOM HOLDER	-	-	1	-	
12	BRADLEY	9594	FOLDABLE REVERSIBLE SHOWER SEAT	1	1	-	-	
13	BRADLEY	9537 / 9538 / 9540	SHOWER CURTAIN / ROD / HOOKS	1/1/1	1/1/1	-	-	
14	BRADLEY	9119	**ROB HOOKS (2 PER SHOWER) W/ 1 @ ADA HT.	2	2	-	-	
15	BRADLEY	SA49	SHOWER SHELF	1	1	-	-	
-				-	-	-	-	
-				-	-	-	-	
-				-	-	-	-	
⁻ -1	-	-	FLOOR RUBBER TRANSITION	SEE FLOOR PLANS				
-2	SCHLUTER	SHOWERPROFILE-WS	TRANSITION BETWEEN FLOORING PT-1 & OTHER	SEE FLOOR PLANS				
-3	-	-	-		SEE FLOO	OR PLANS		

⁻ ALL MOUNTING HEIGHTS TO BE PER ADA - SEE CODE SHEET FOR DETAILS



1) ENLARGED FLOOR PLAN @ UNISEX 110 & 111 1/2" = 1'-0"

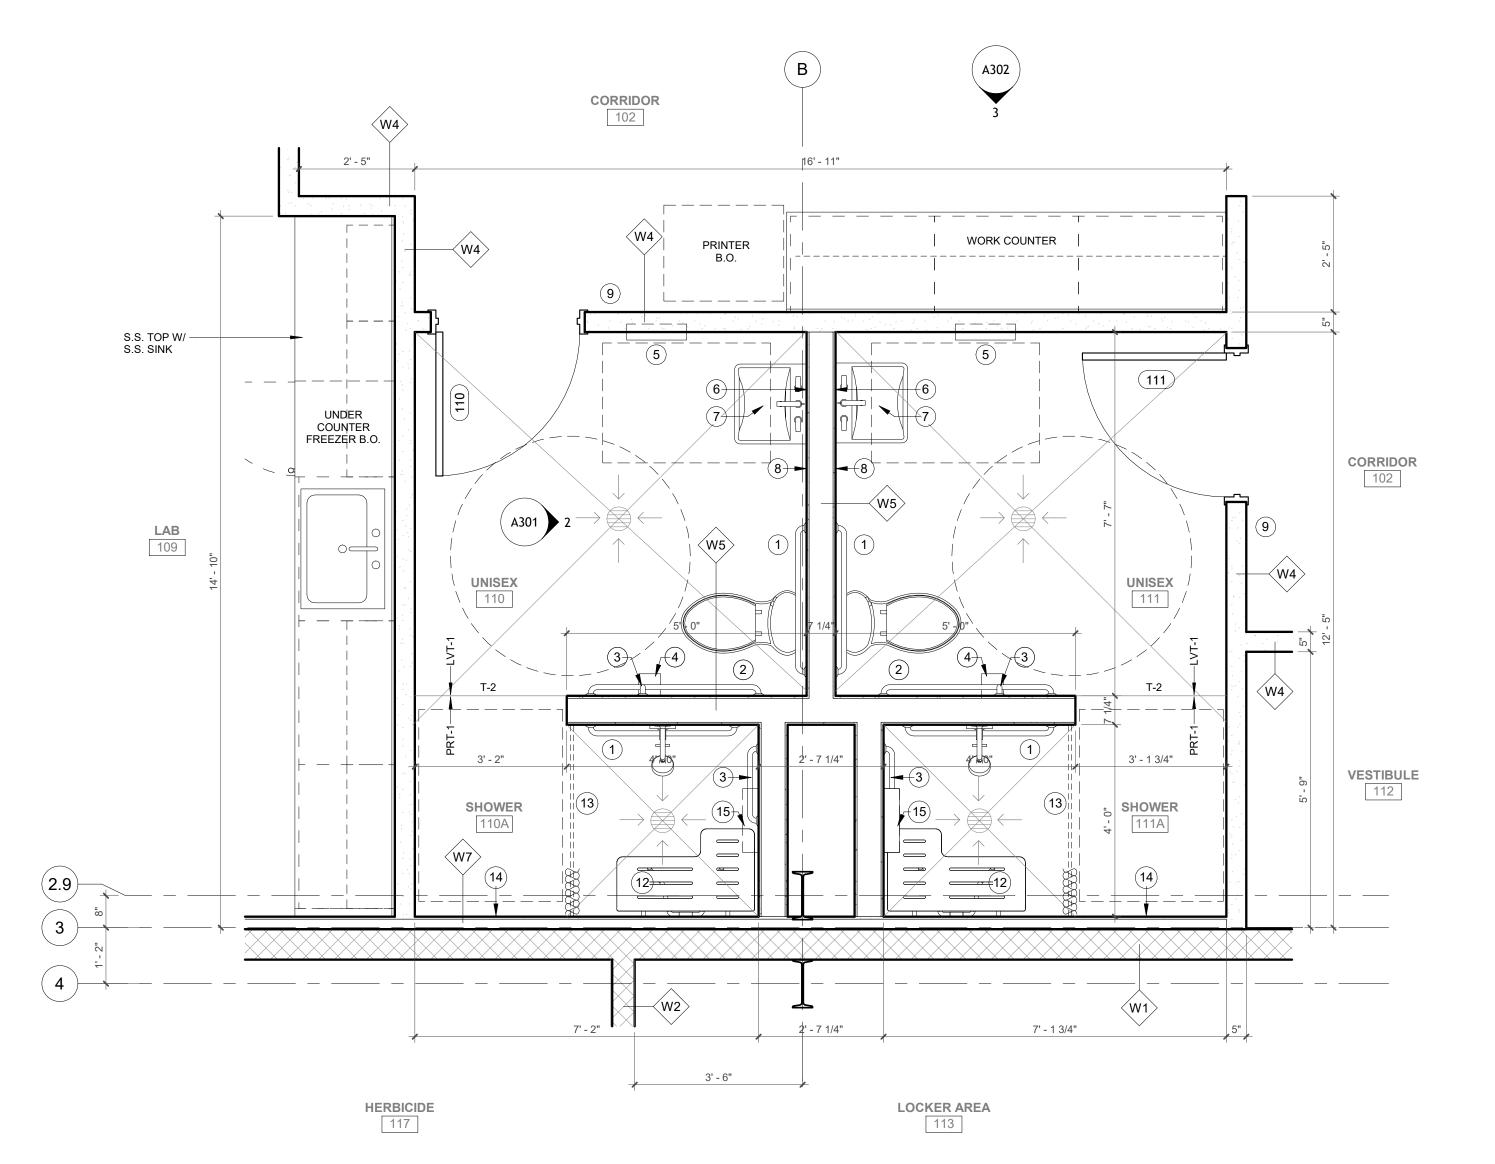

2 INTERIOR ELEVATION @ UNISEX (110) WET WALL - 111 SIM.
1/2" = 1'-0"



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New Building

for

Forest Preserves of Winnebago County

Meridian Rd., Winnebago County, Illinois

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DESCRIPTION

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Scale

NO. DATE

1) 05-08-2025

1/2" = 1'-0"

Sheet Title


ENLARGED FLOOR PLANS


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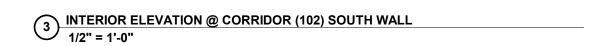
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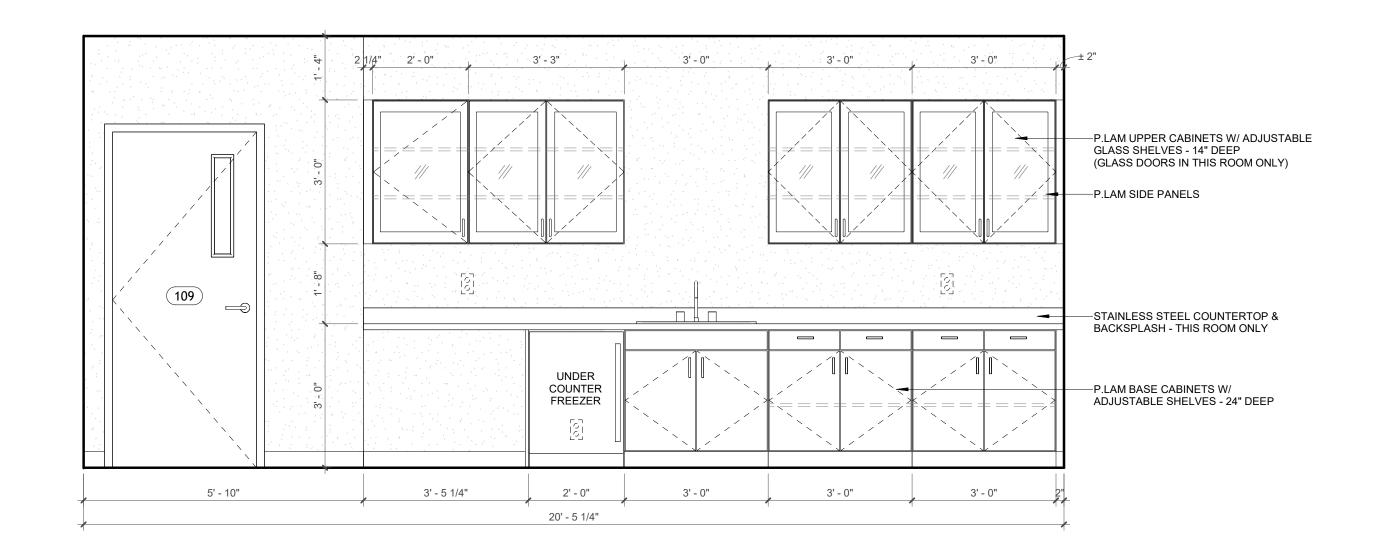
^{*} VERIFY THAT FIXTURES DO NOT ALREADY COME WITH UNDERSINK PIPING COVERS BEFORE ORDERING

^{**} PROVIDE (1) ROB HOOK AT 48" A.F.F. & (1) AT 54" A.F.F.





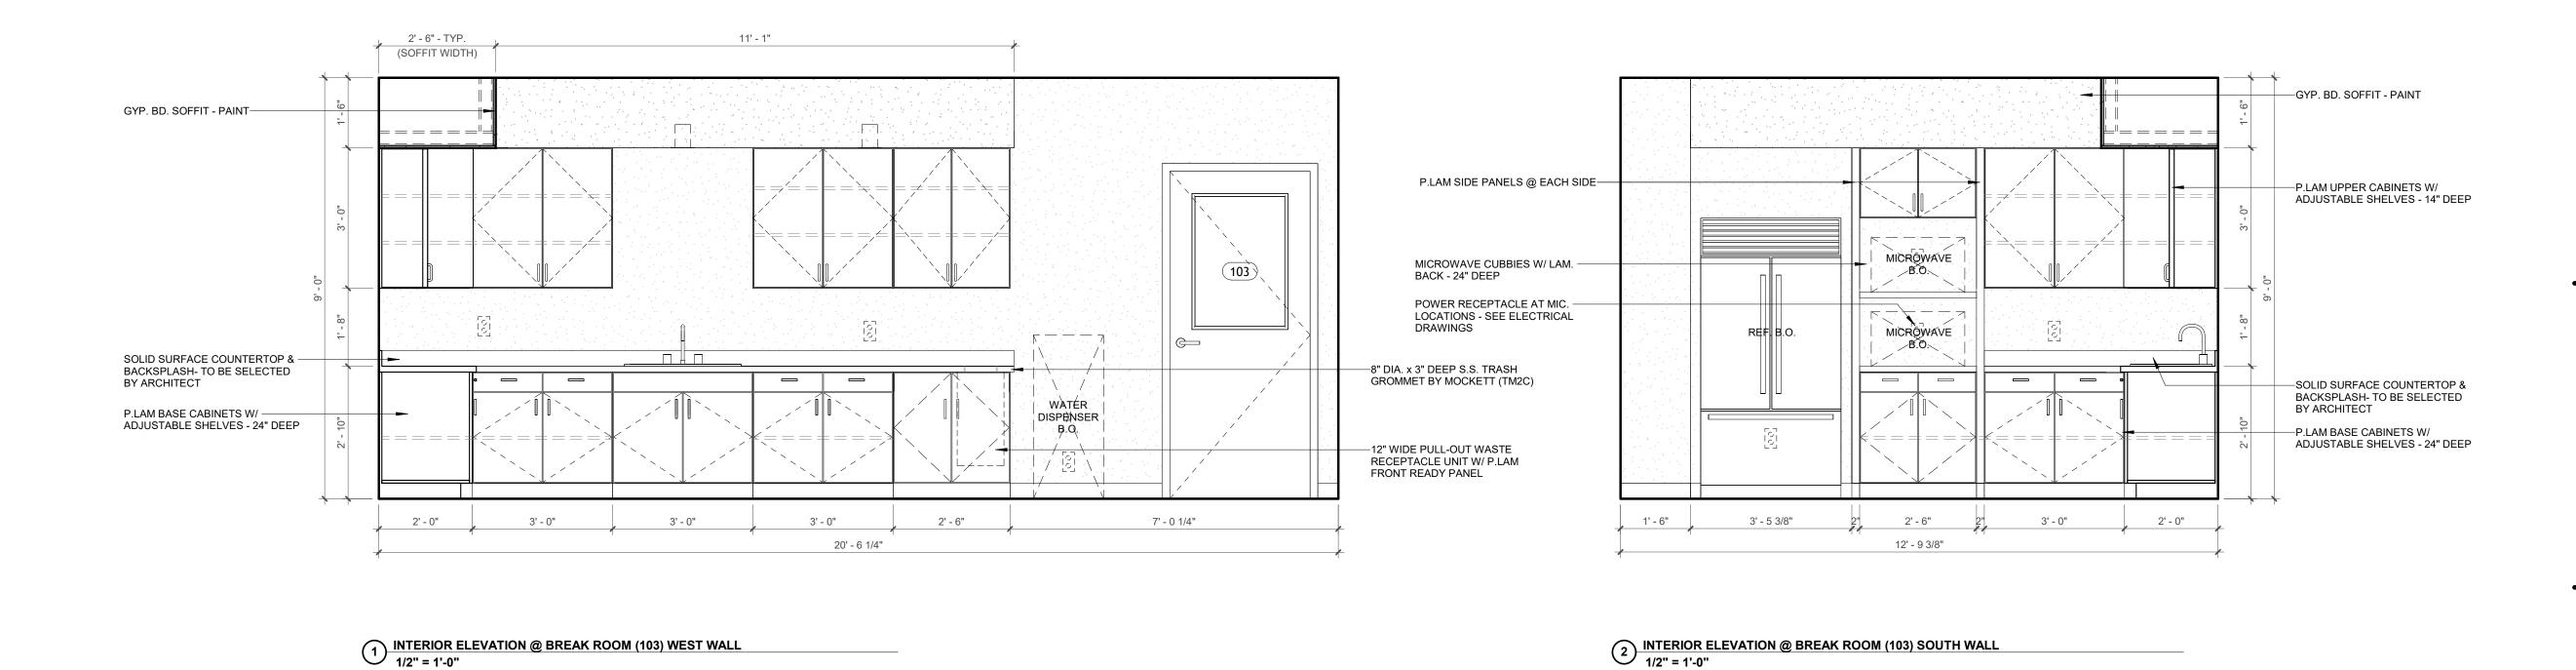

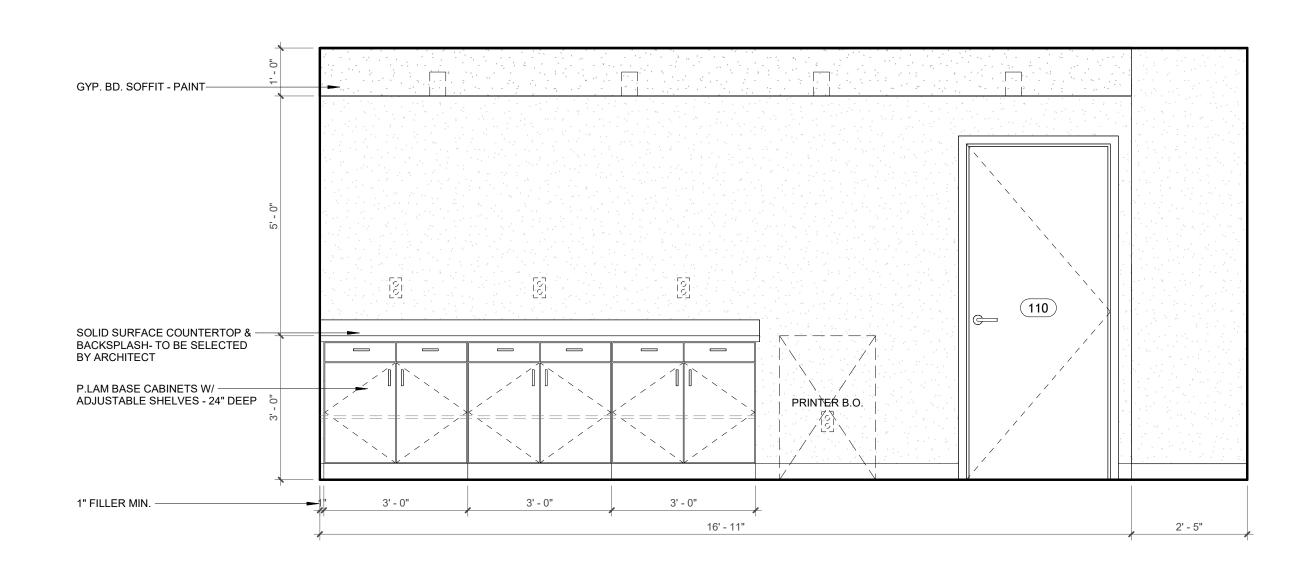

4 INTERIOR ELEVATION @ LAB ROOM (109) EAST WALL
1/2" = 1'-0"



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INTERIOR ELEVATIONS

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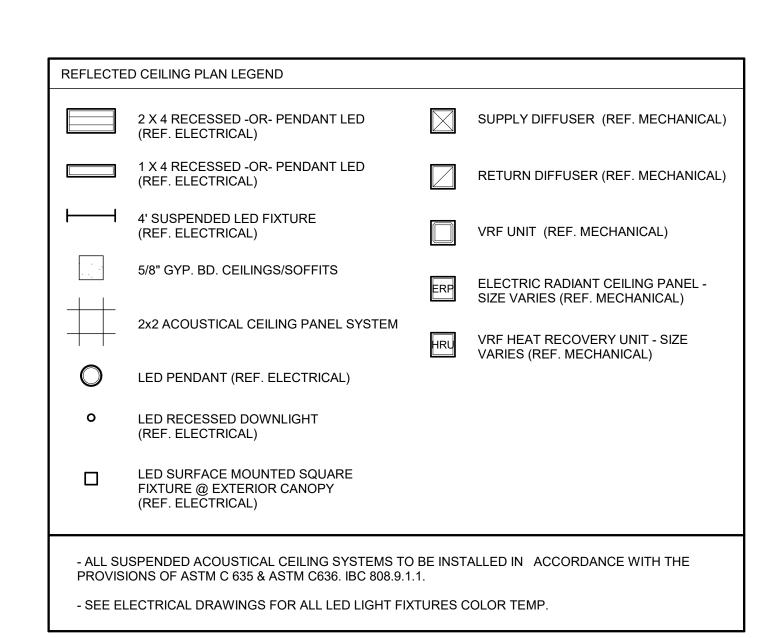
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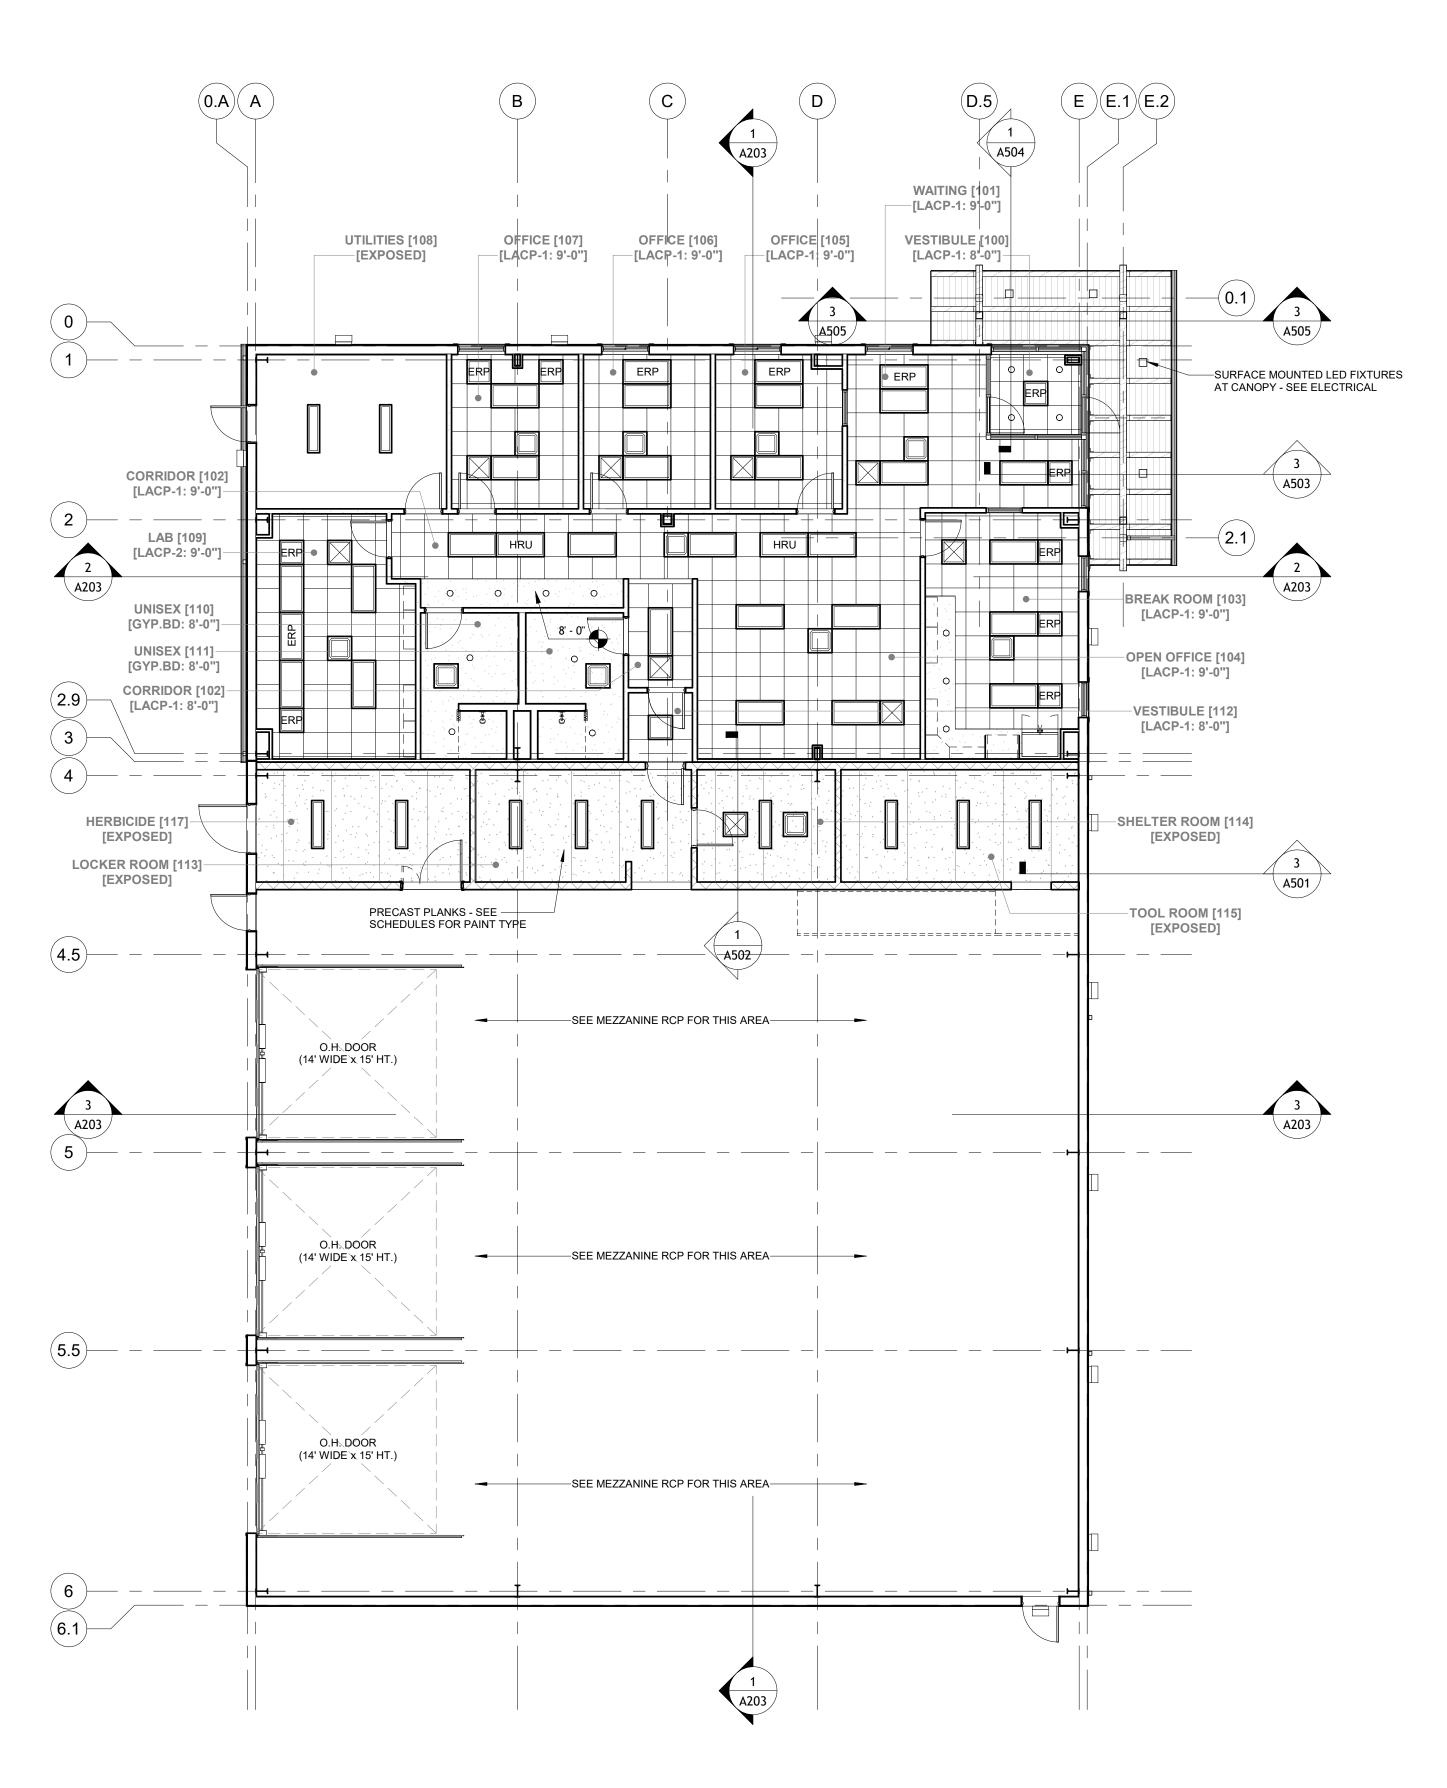
Sheet Title

Sheet No.

1/2" = 1'-0"

A302





1/8" = 1'-0"

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1/8" = 1'-0"


2025-09

Sheet Title

REFLECTED CEILING PLAN

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Sheet No.

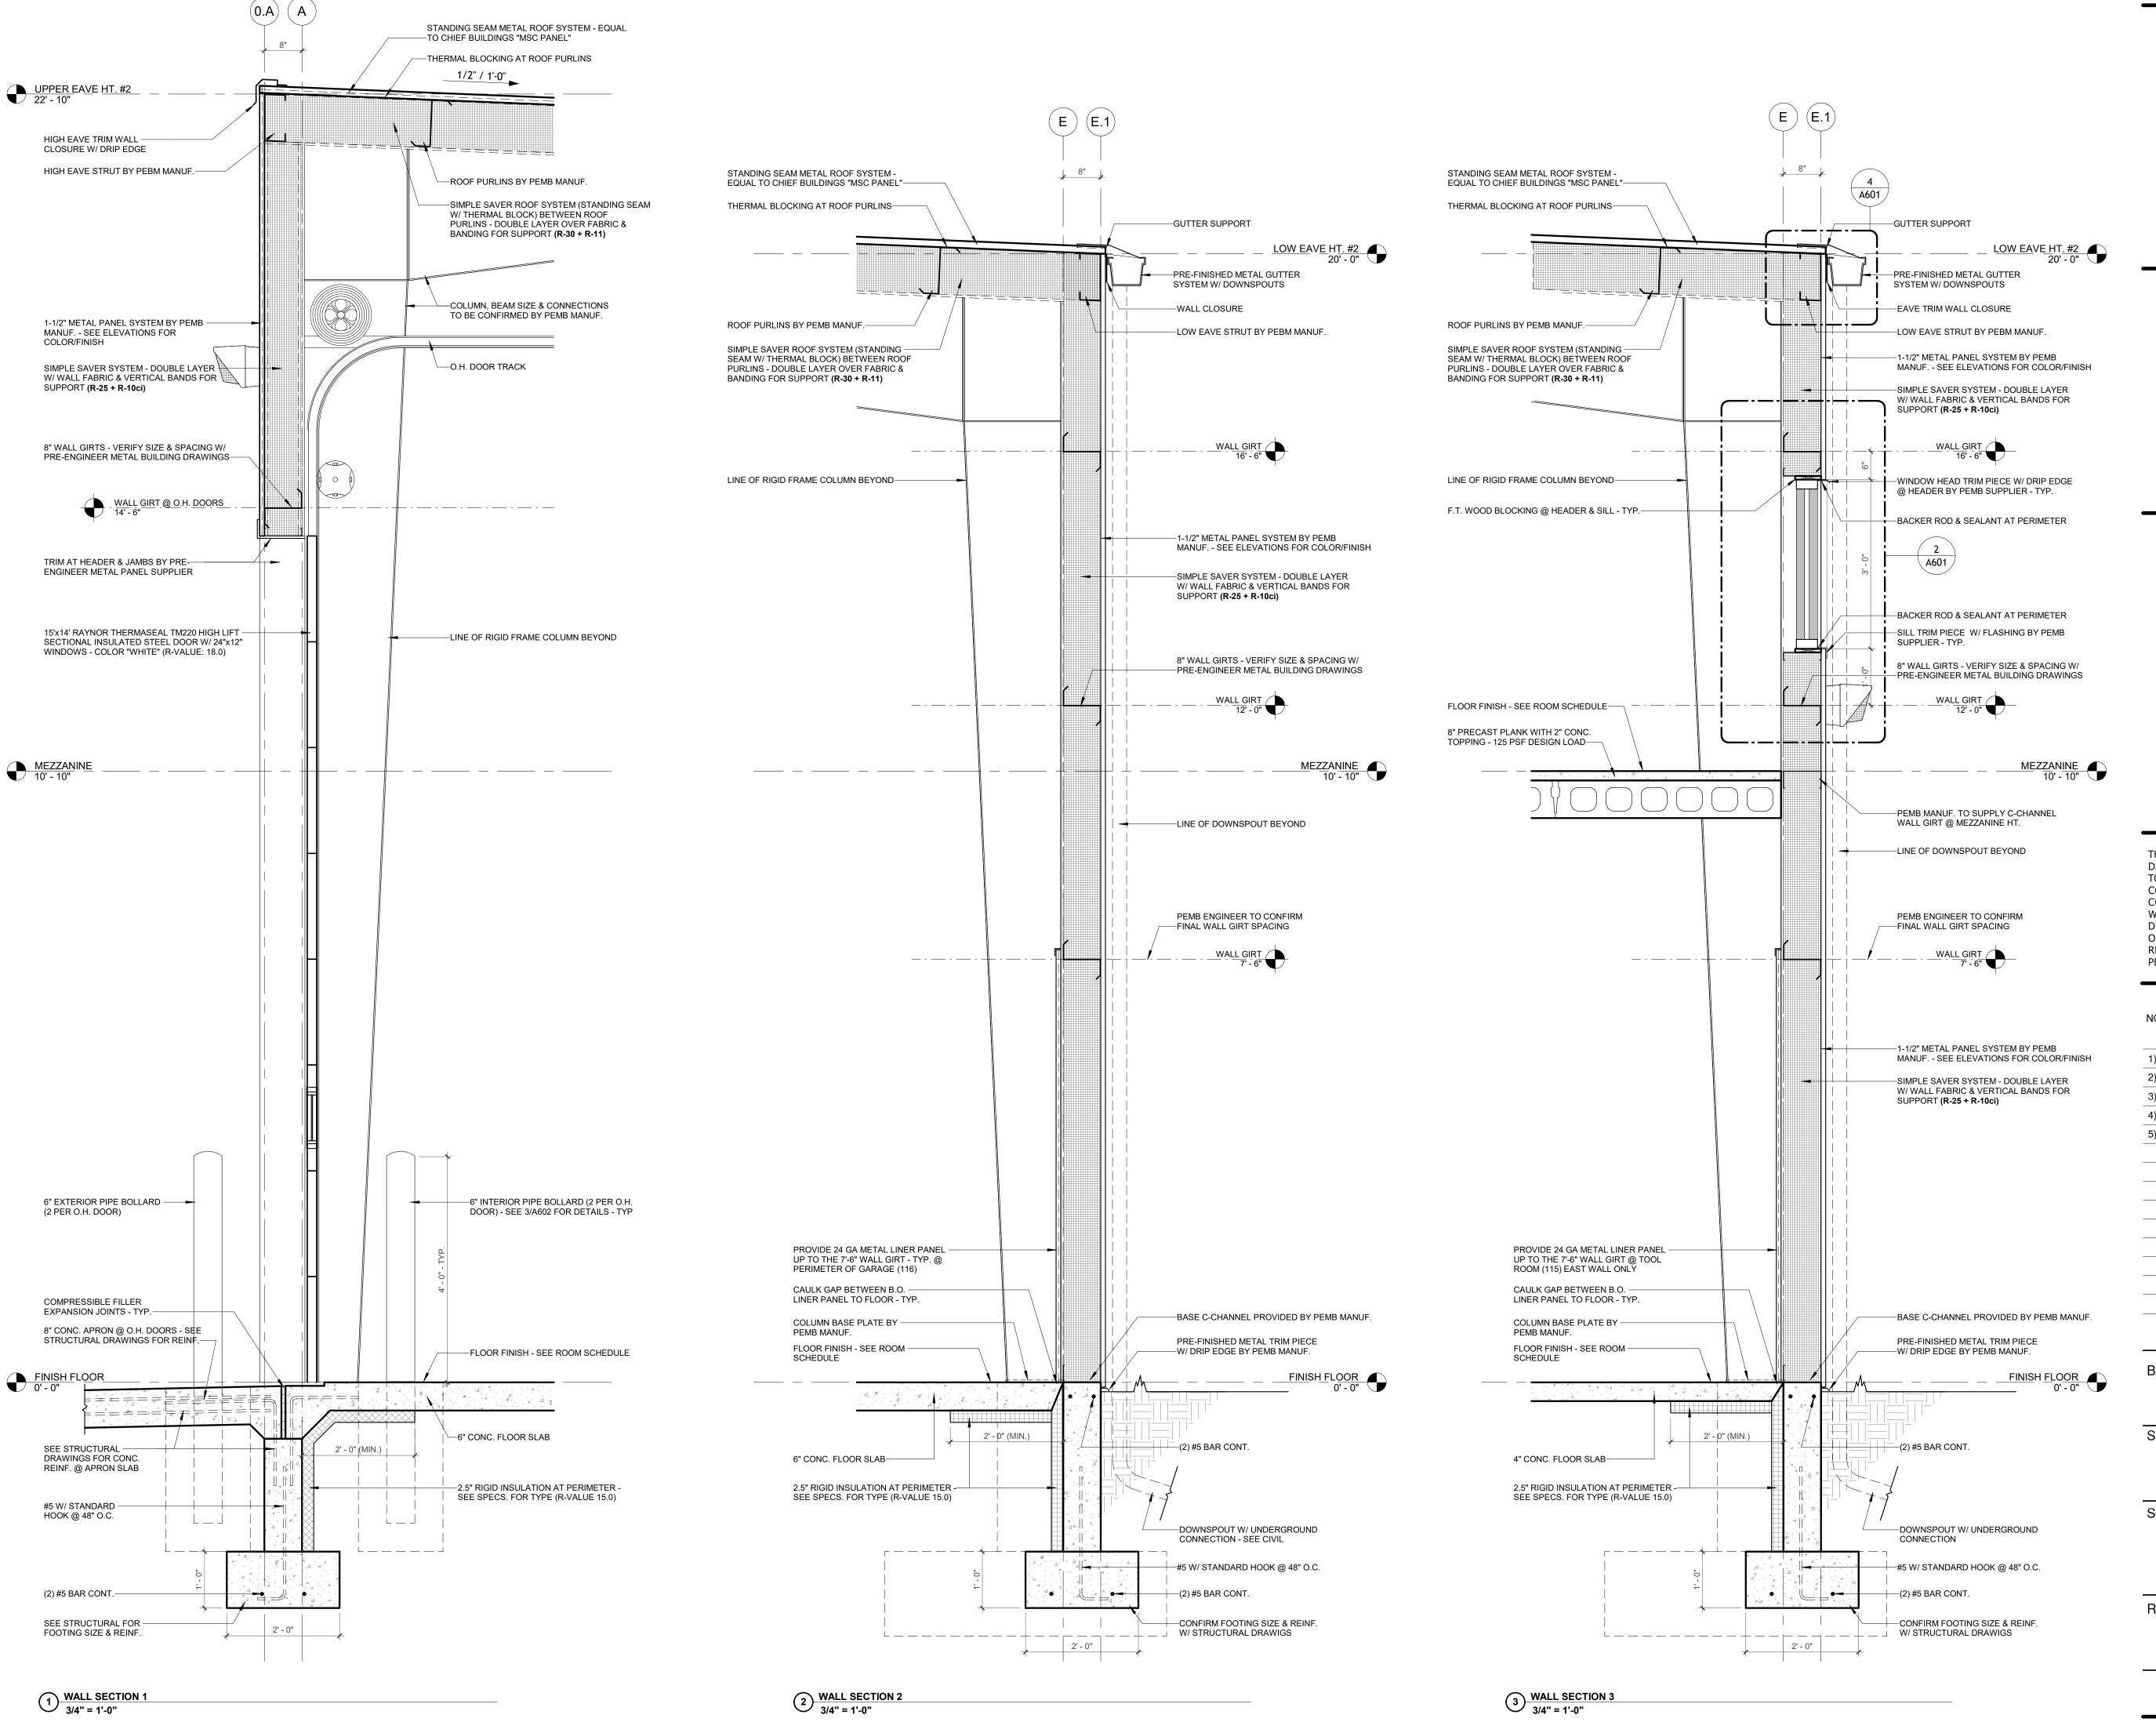

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3/4" = 1'-0"


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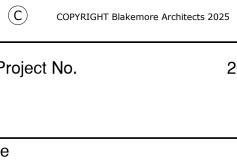
WALL SECTIONS

Ref. North

A501

Sheet No.



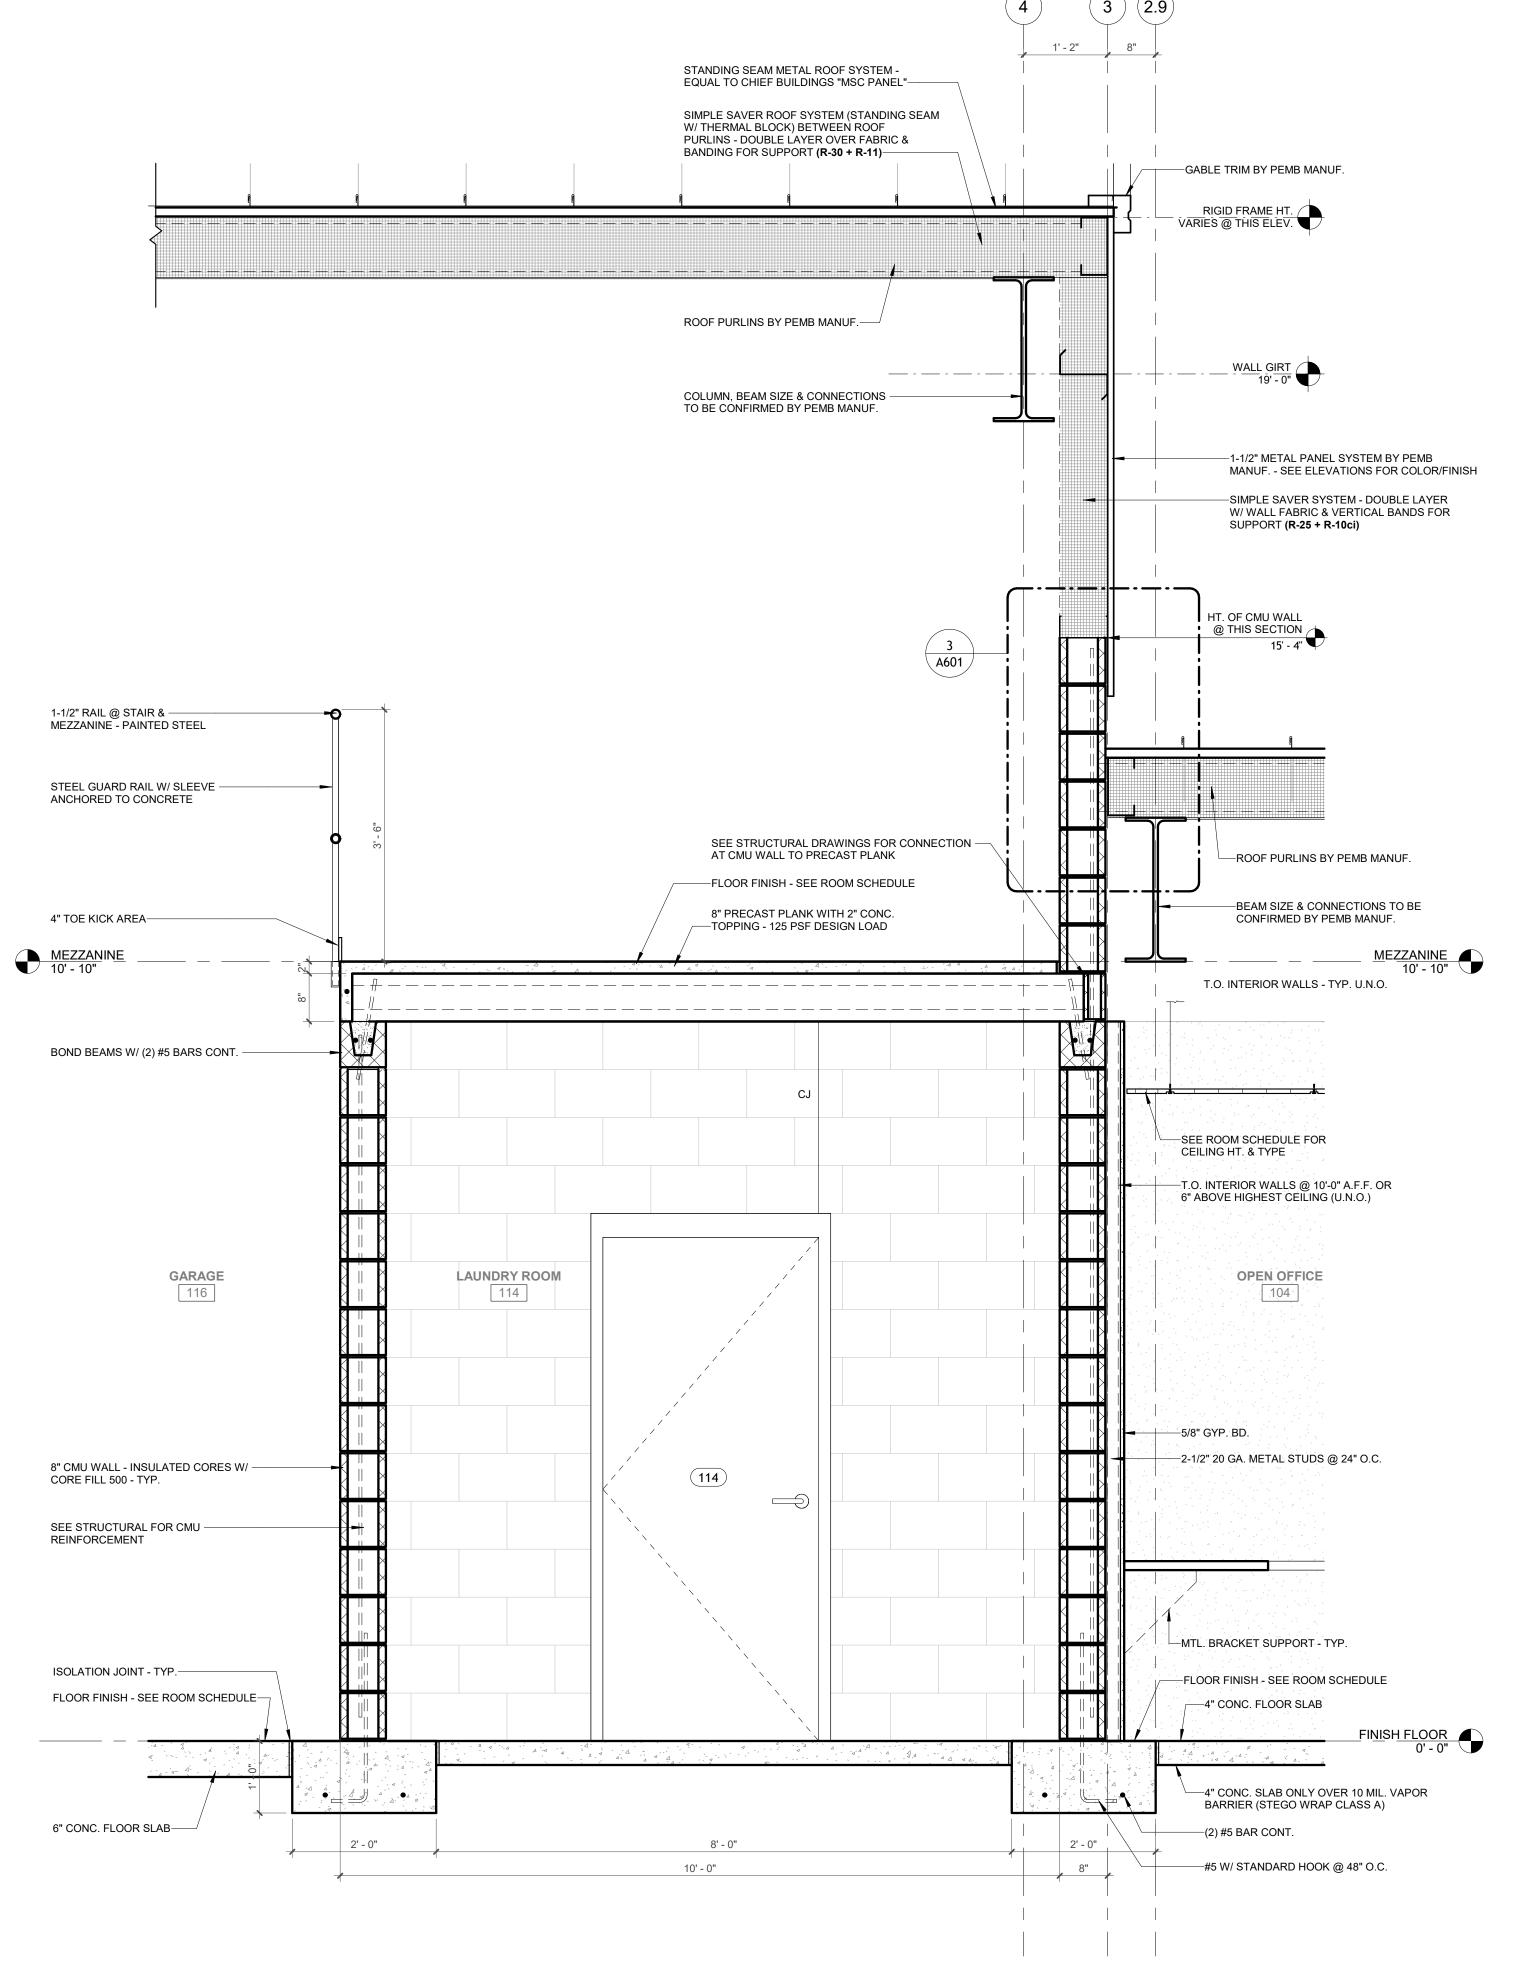

2025-09

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Final Owner Review Set

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Initial Layout

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2) 08-07-2025

3) 08-27-2025

10-17-2025

10-27-2025

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Scale

3/4" = 1'-0"

Sheet Title


WALL SECTIONS

Ref. North

Sheet No.

A502

PROFESSIONAL DESIGN FIRM REGISTRATION # 184-003342

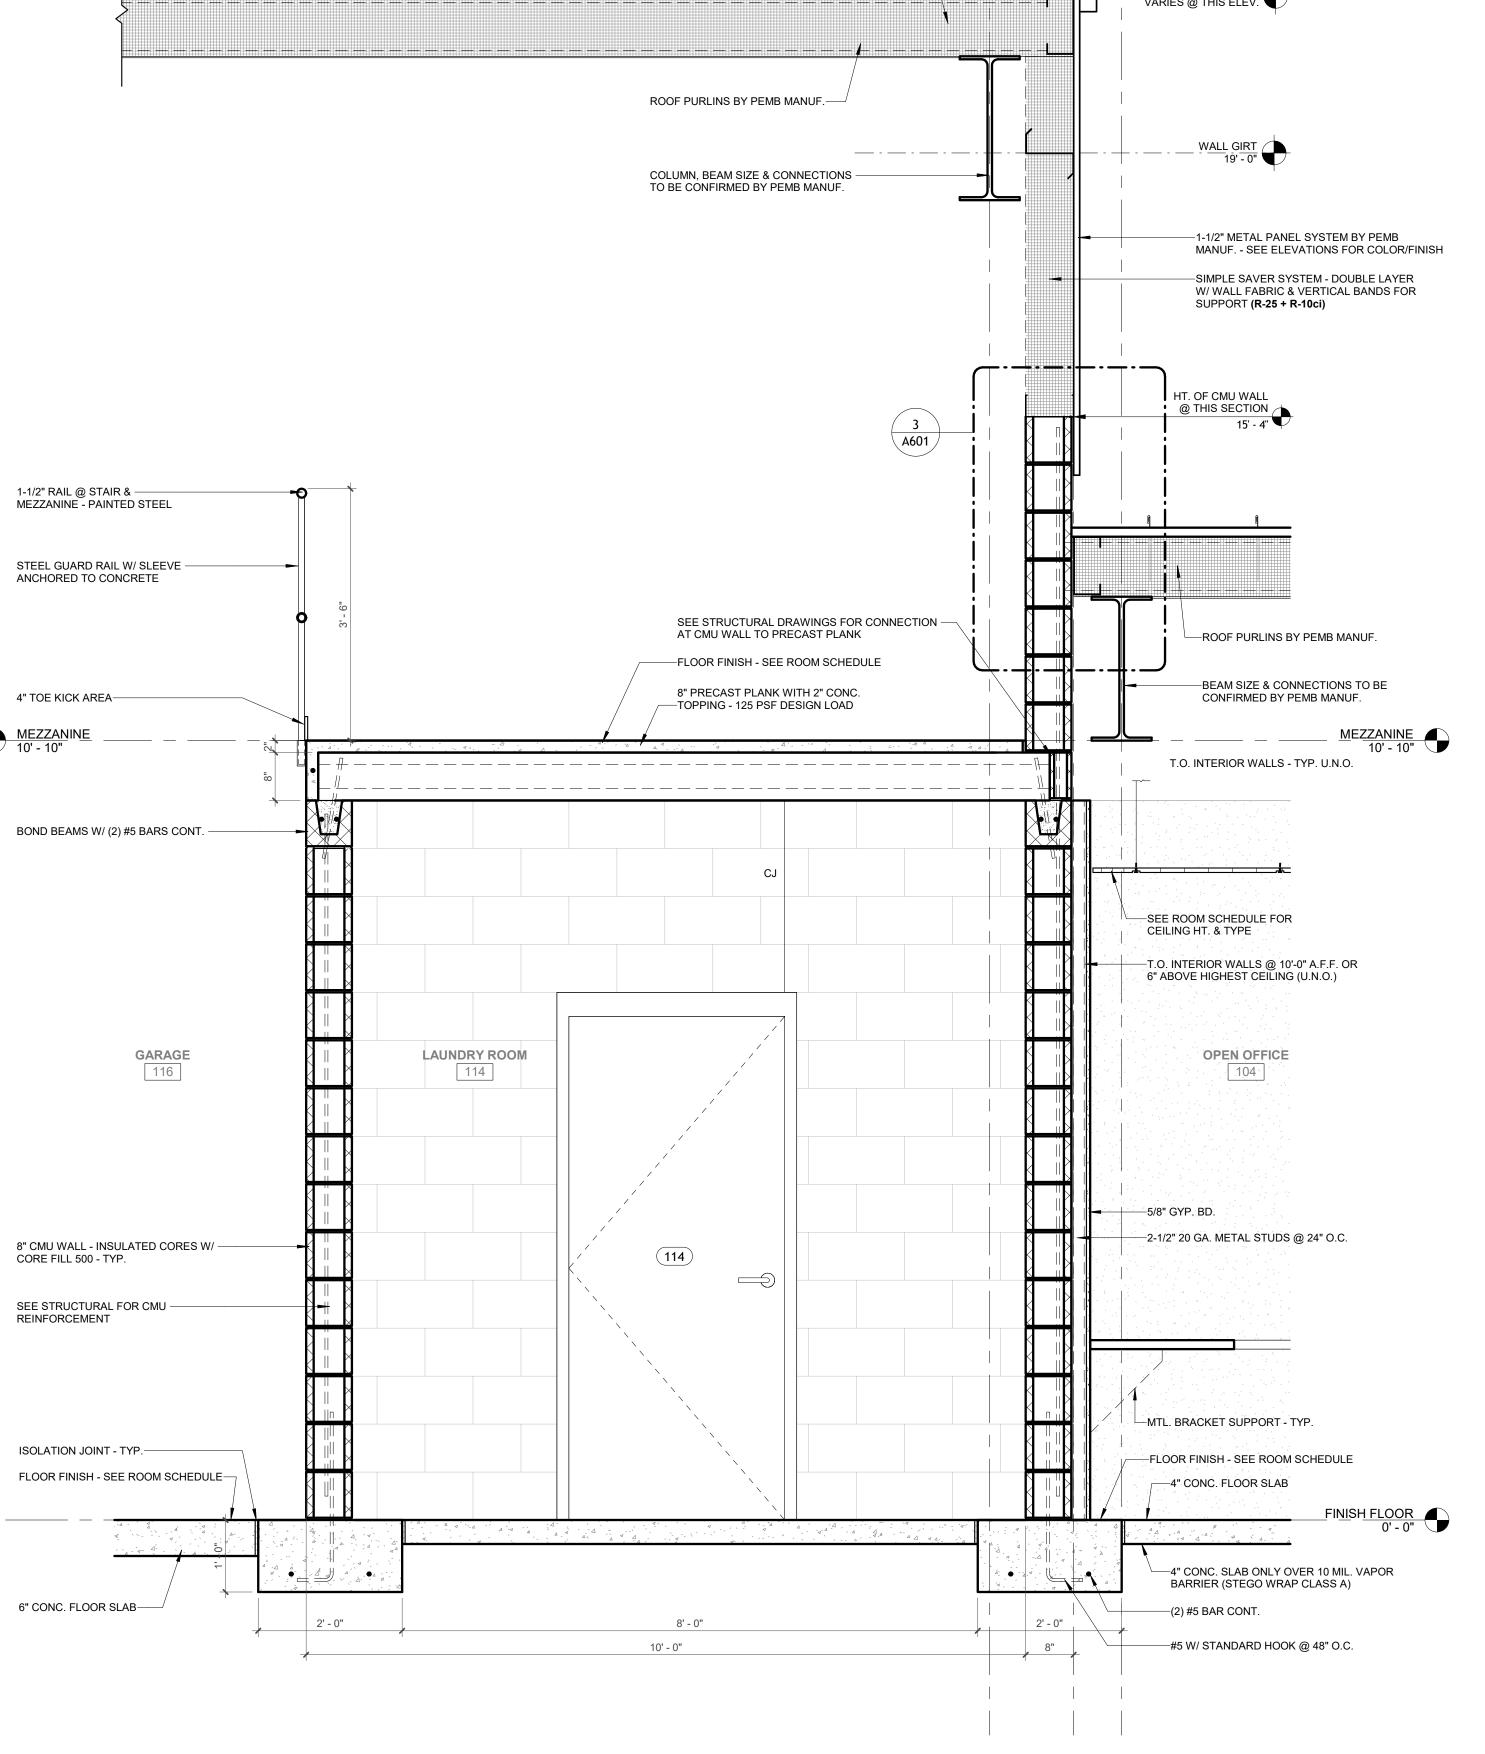

WALL SECTION 4 @ MEZZANINE
3/4" = 1'-0"



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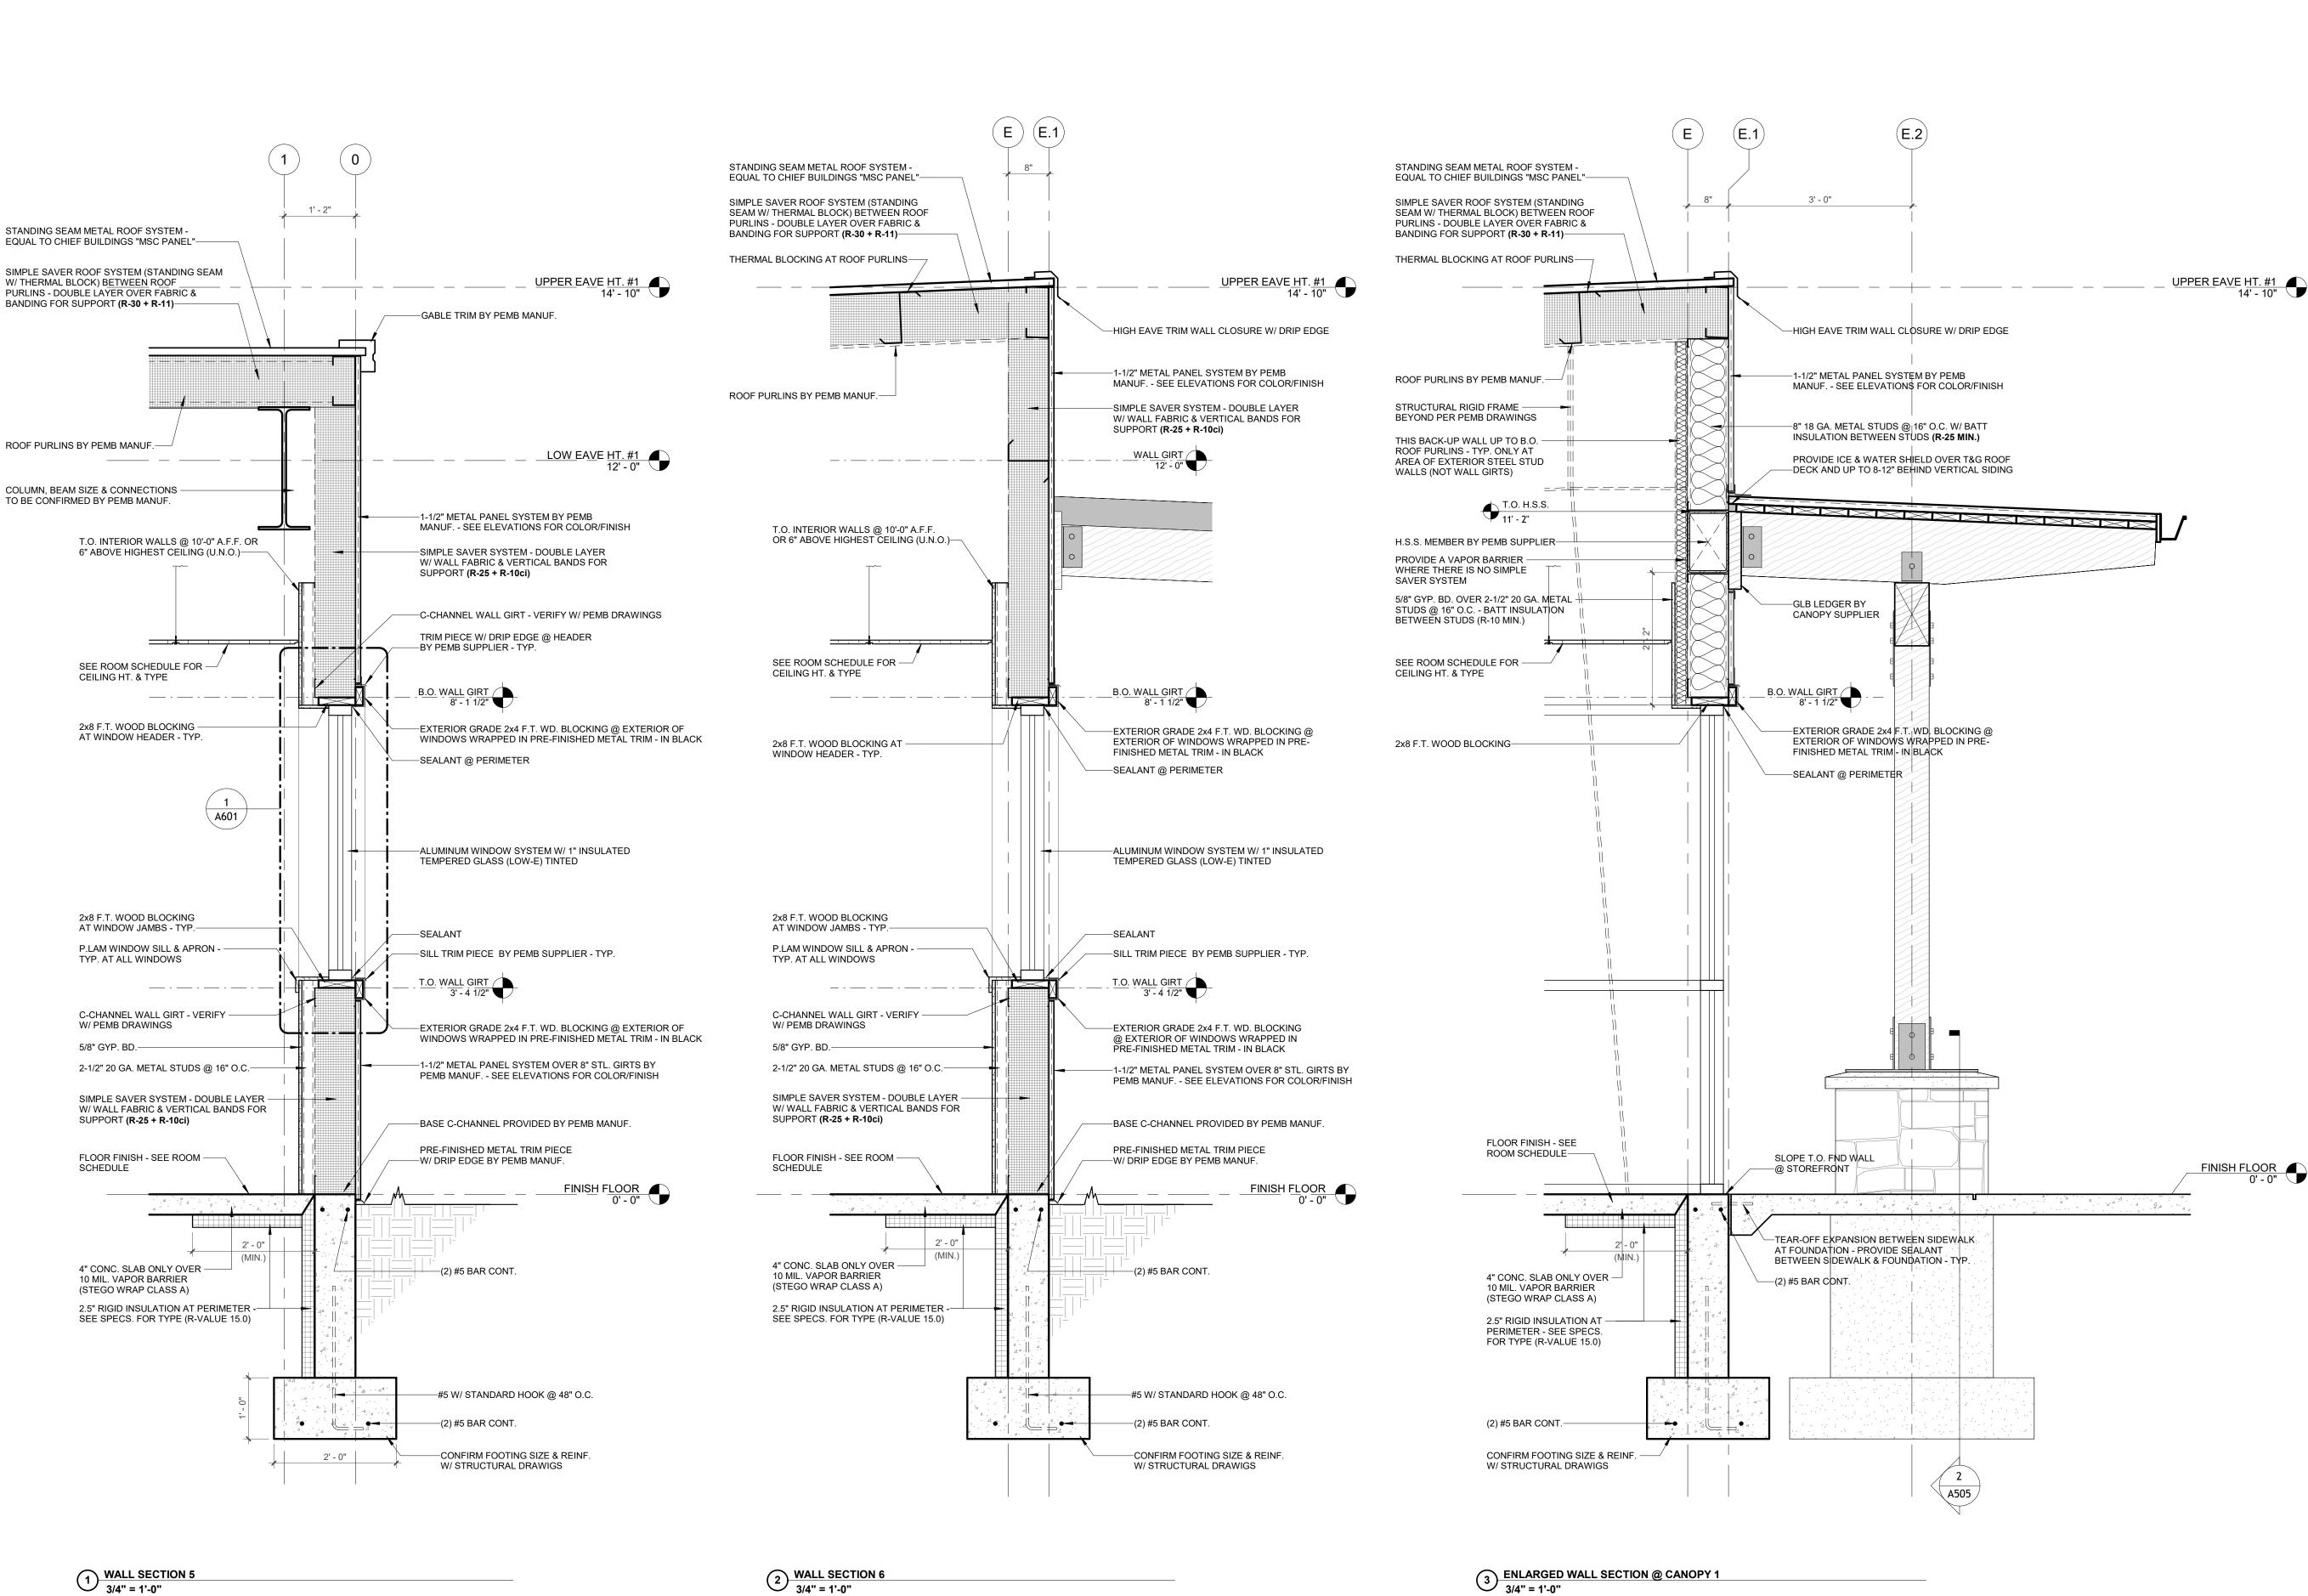
3/4" = 1'-0"


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WALL SECTIONS


Ref. North

A503



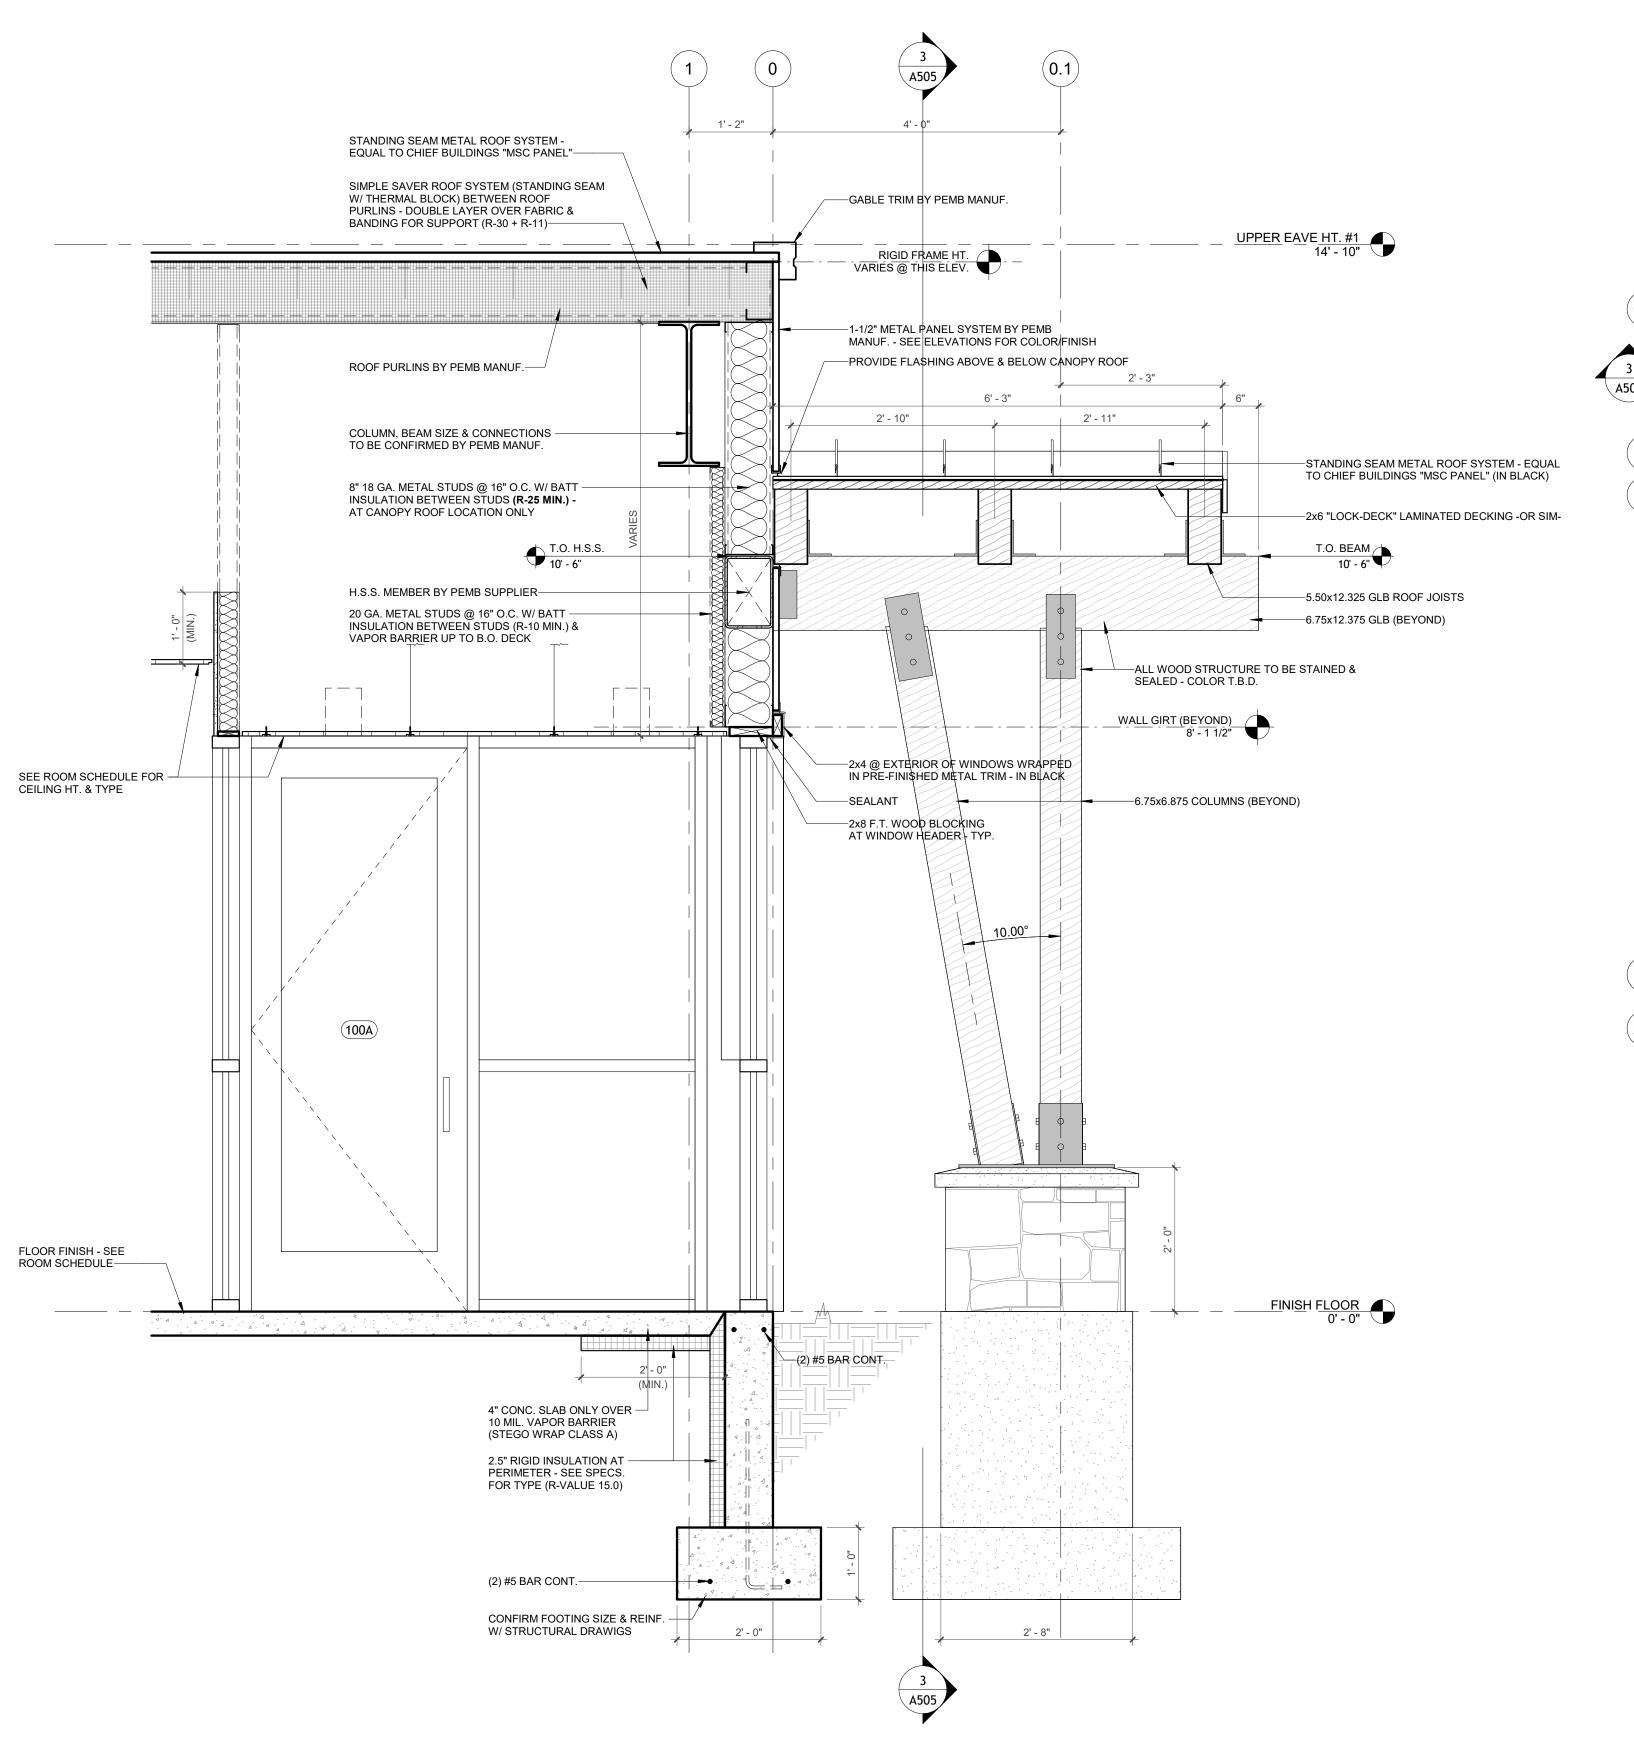

1 ENLARGED WALL SECTION @ CANOPY 2
3/4" = 1'-0"

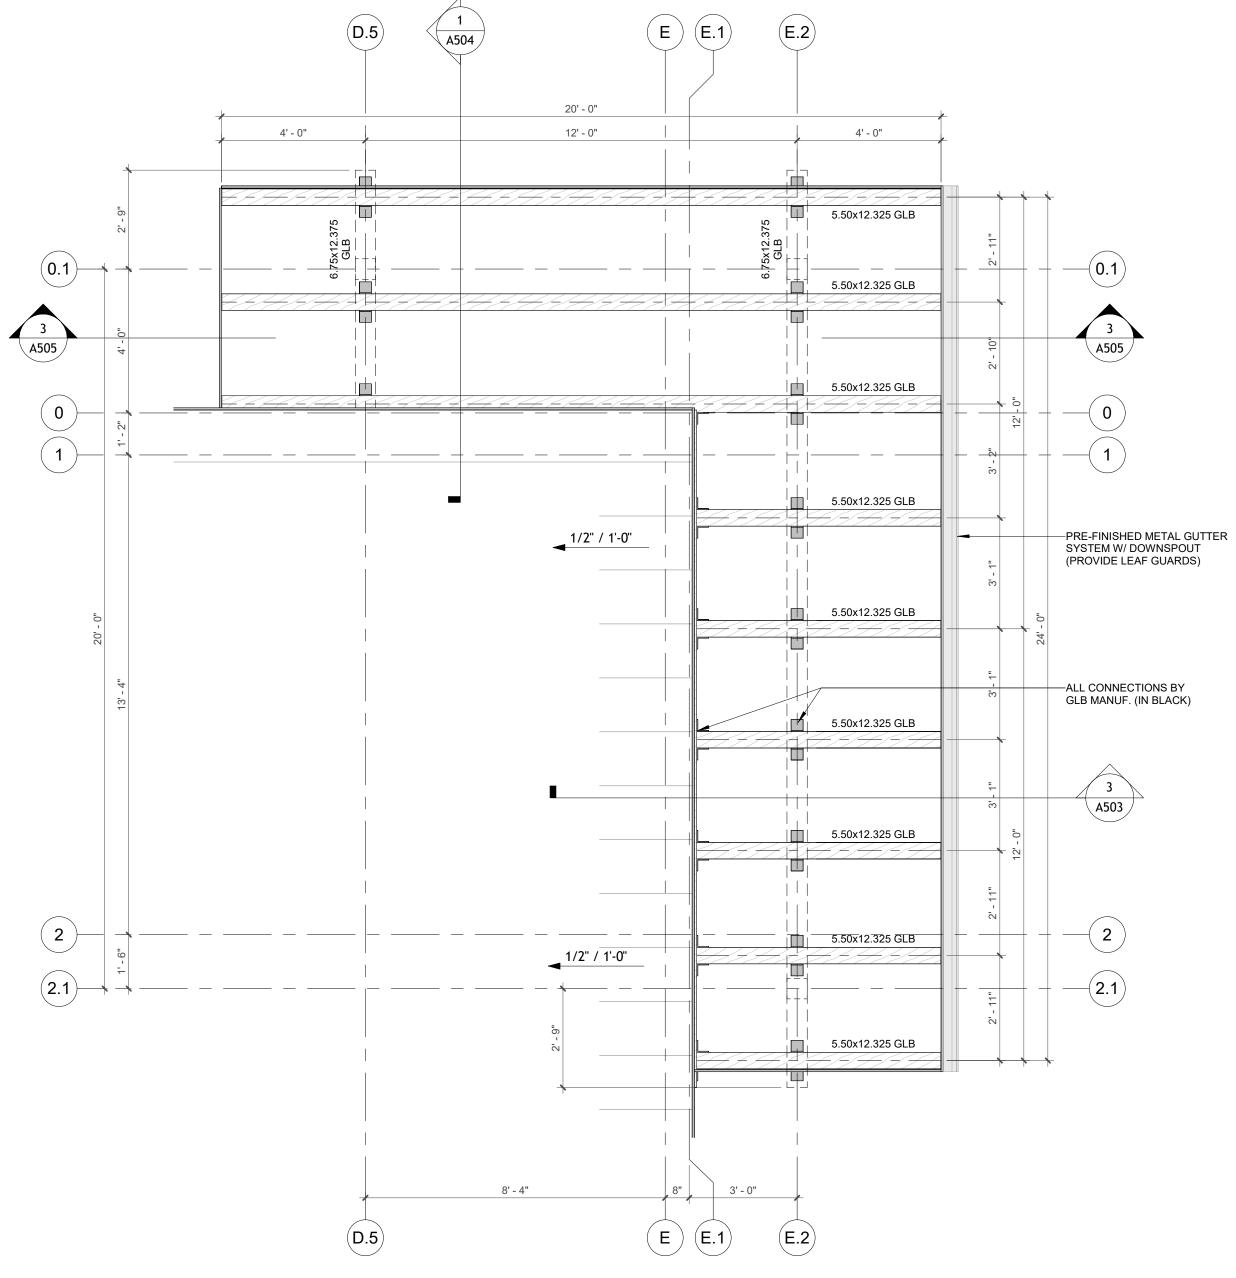

2 ENLARGED CANOPY FRAMING PLAN
3/8" = 1'-0"

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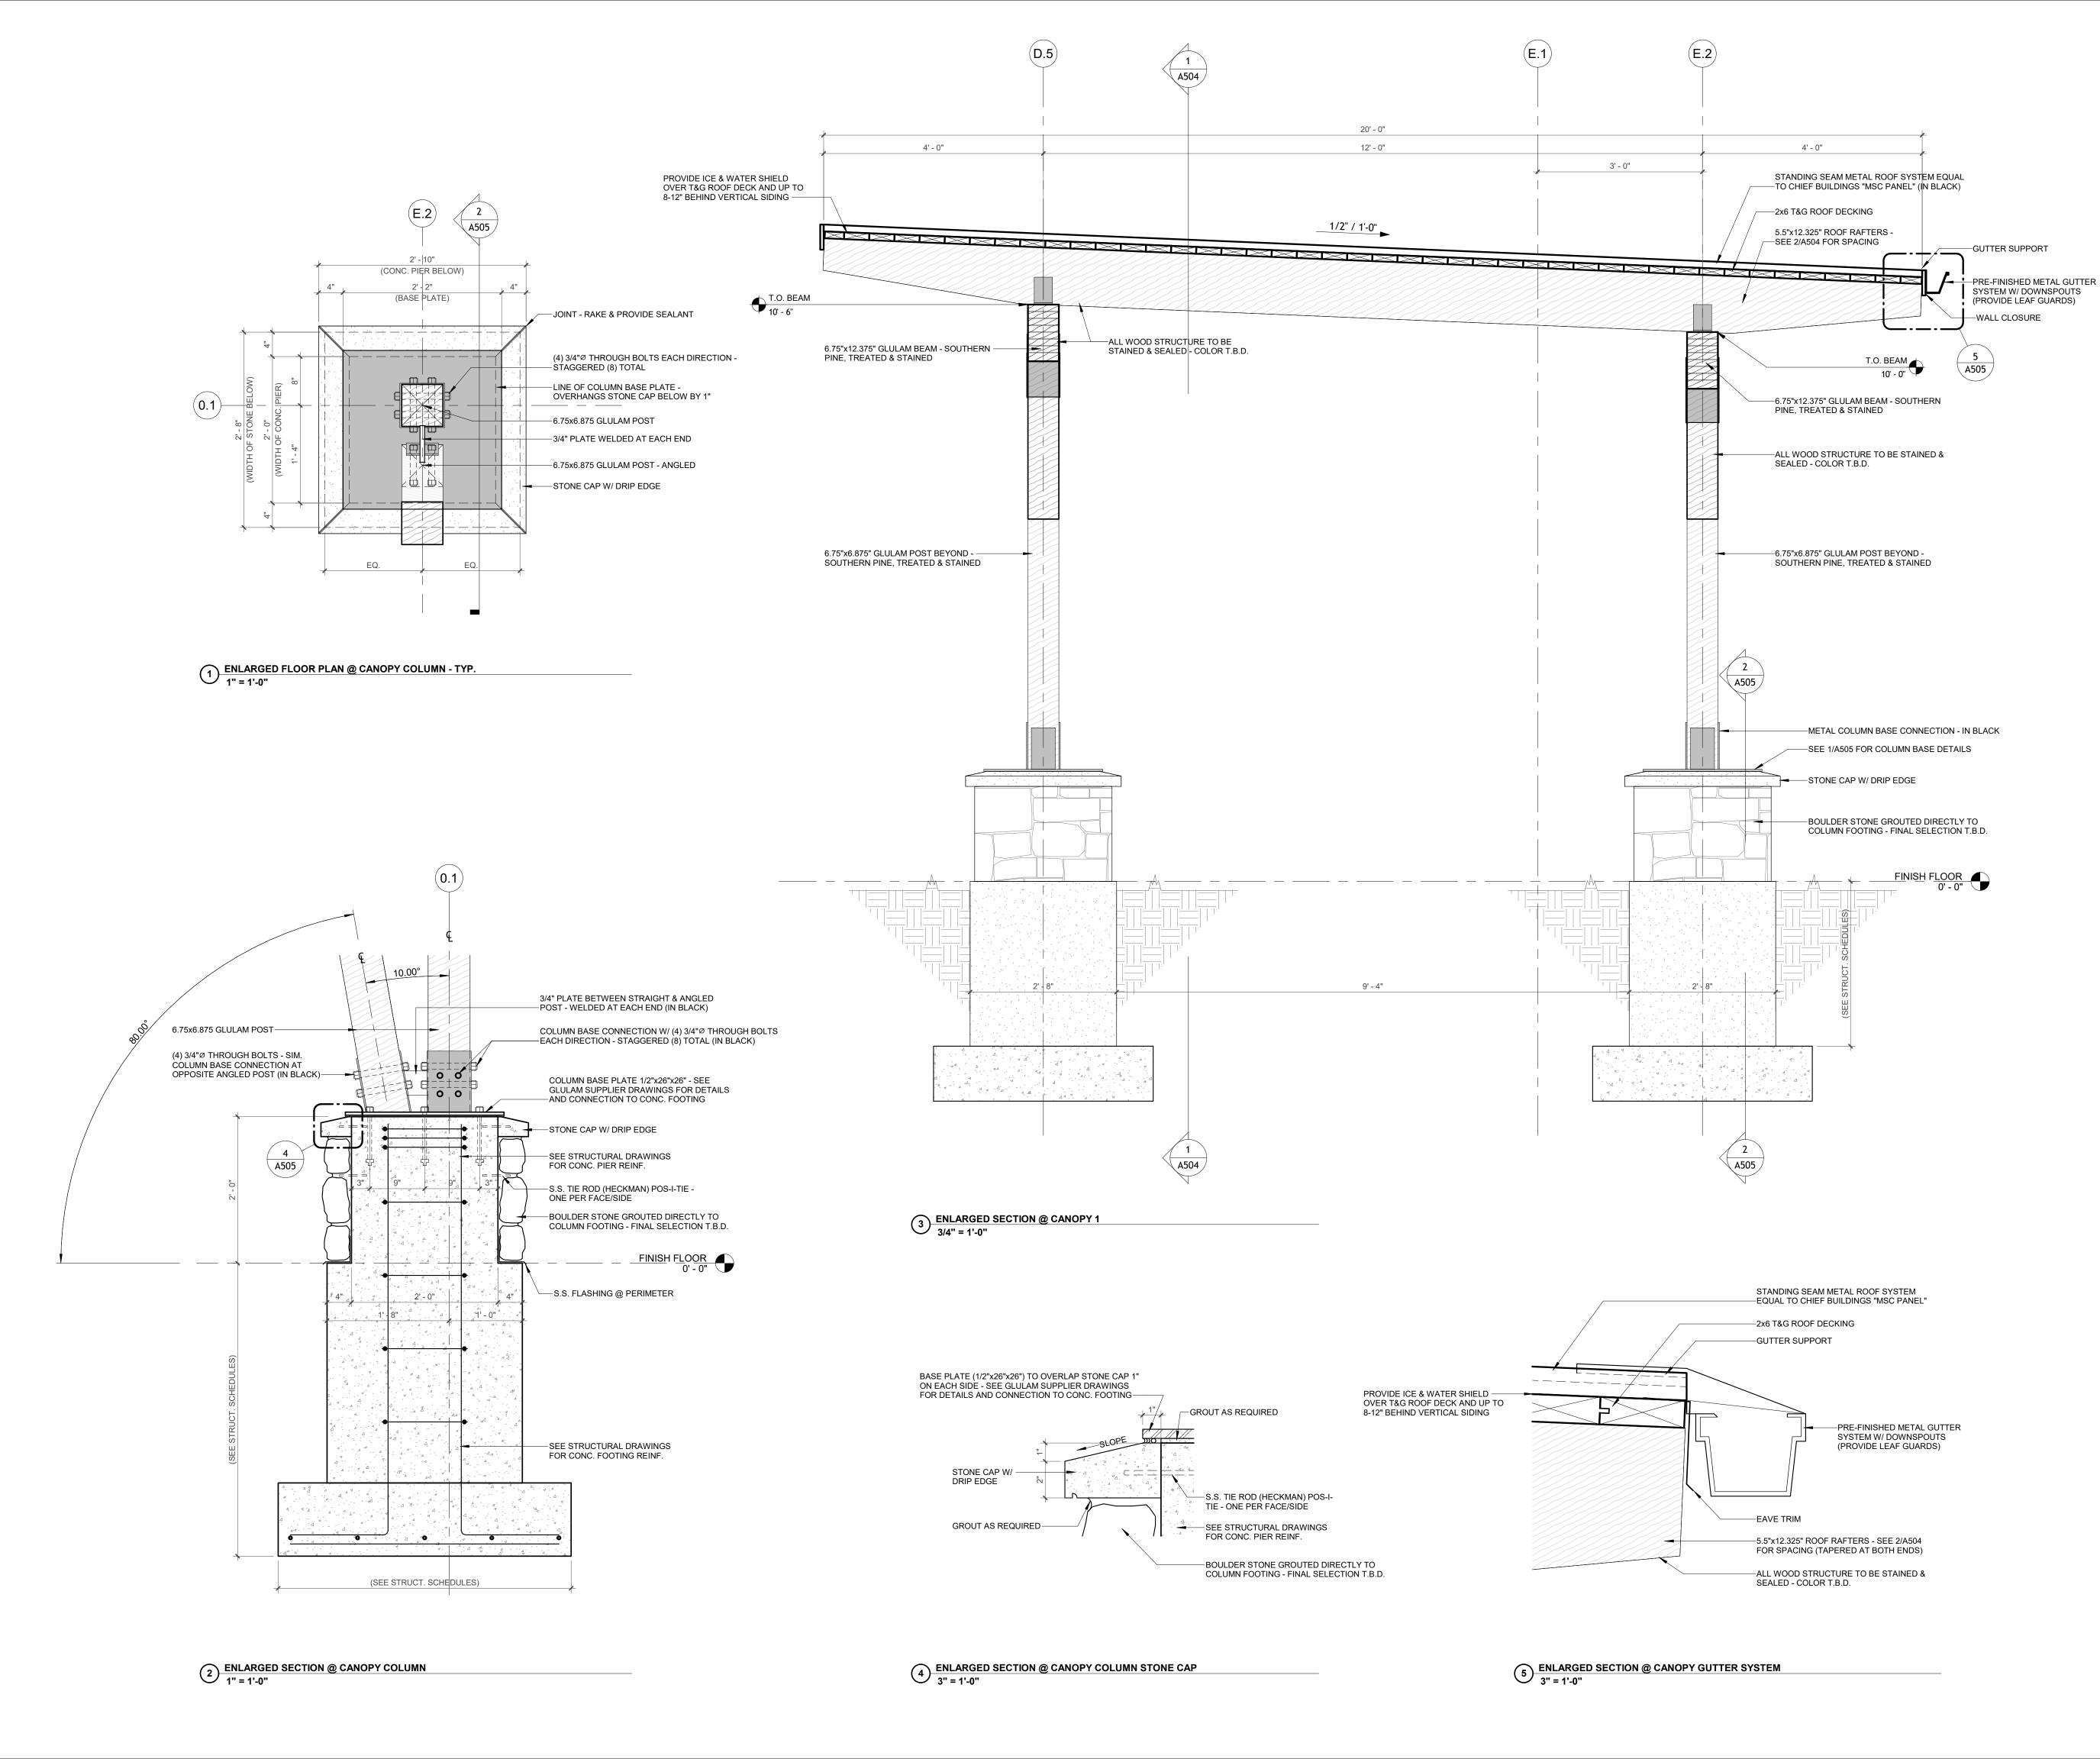
CANOPY SECTIONS

Ref. North

Sheet No.

2025-09

A504





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Final Owner Review S	10-17-2025	4)	
Issued for Bids / Perr	10-27-2025	5)	

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Sheet Title


CANOPY SECTIONS & DETAILS

Ref. North

A505

Sheet No.

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Scale

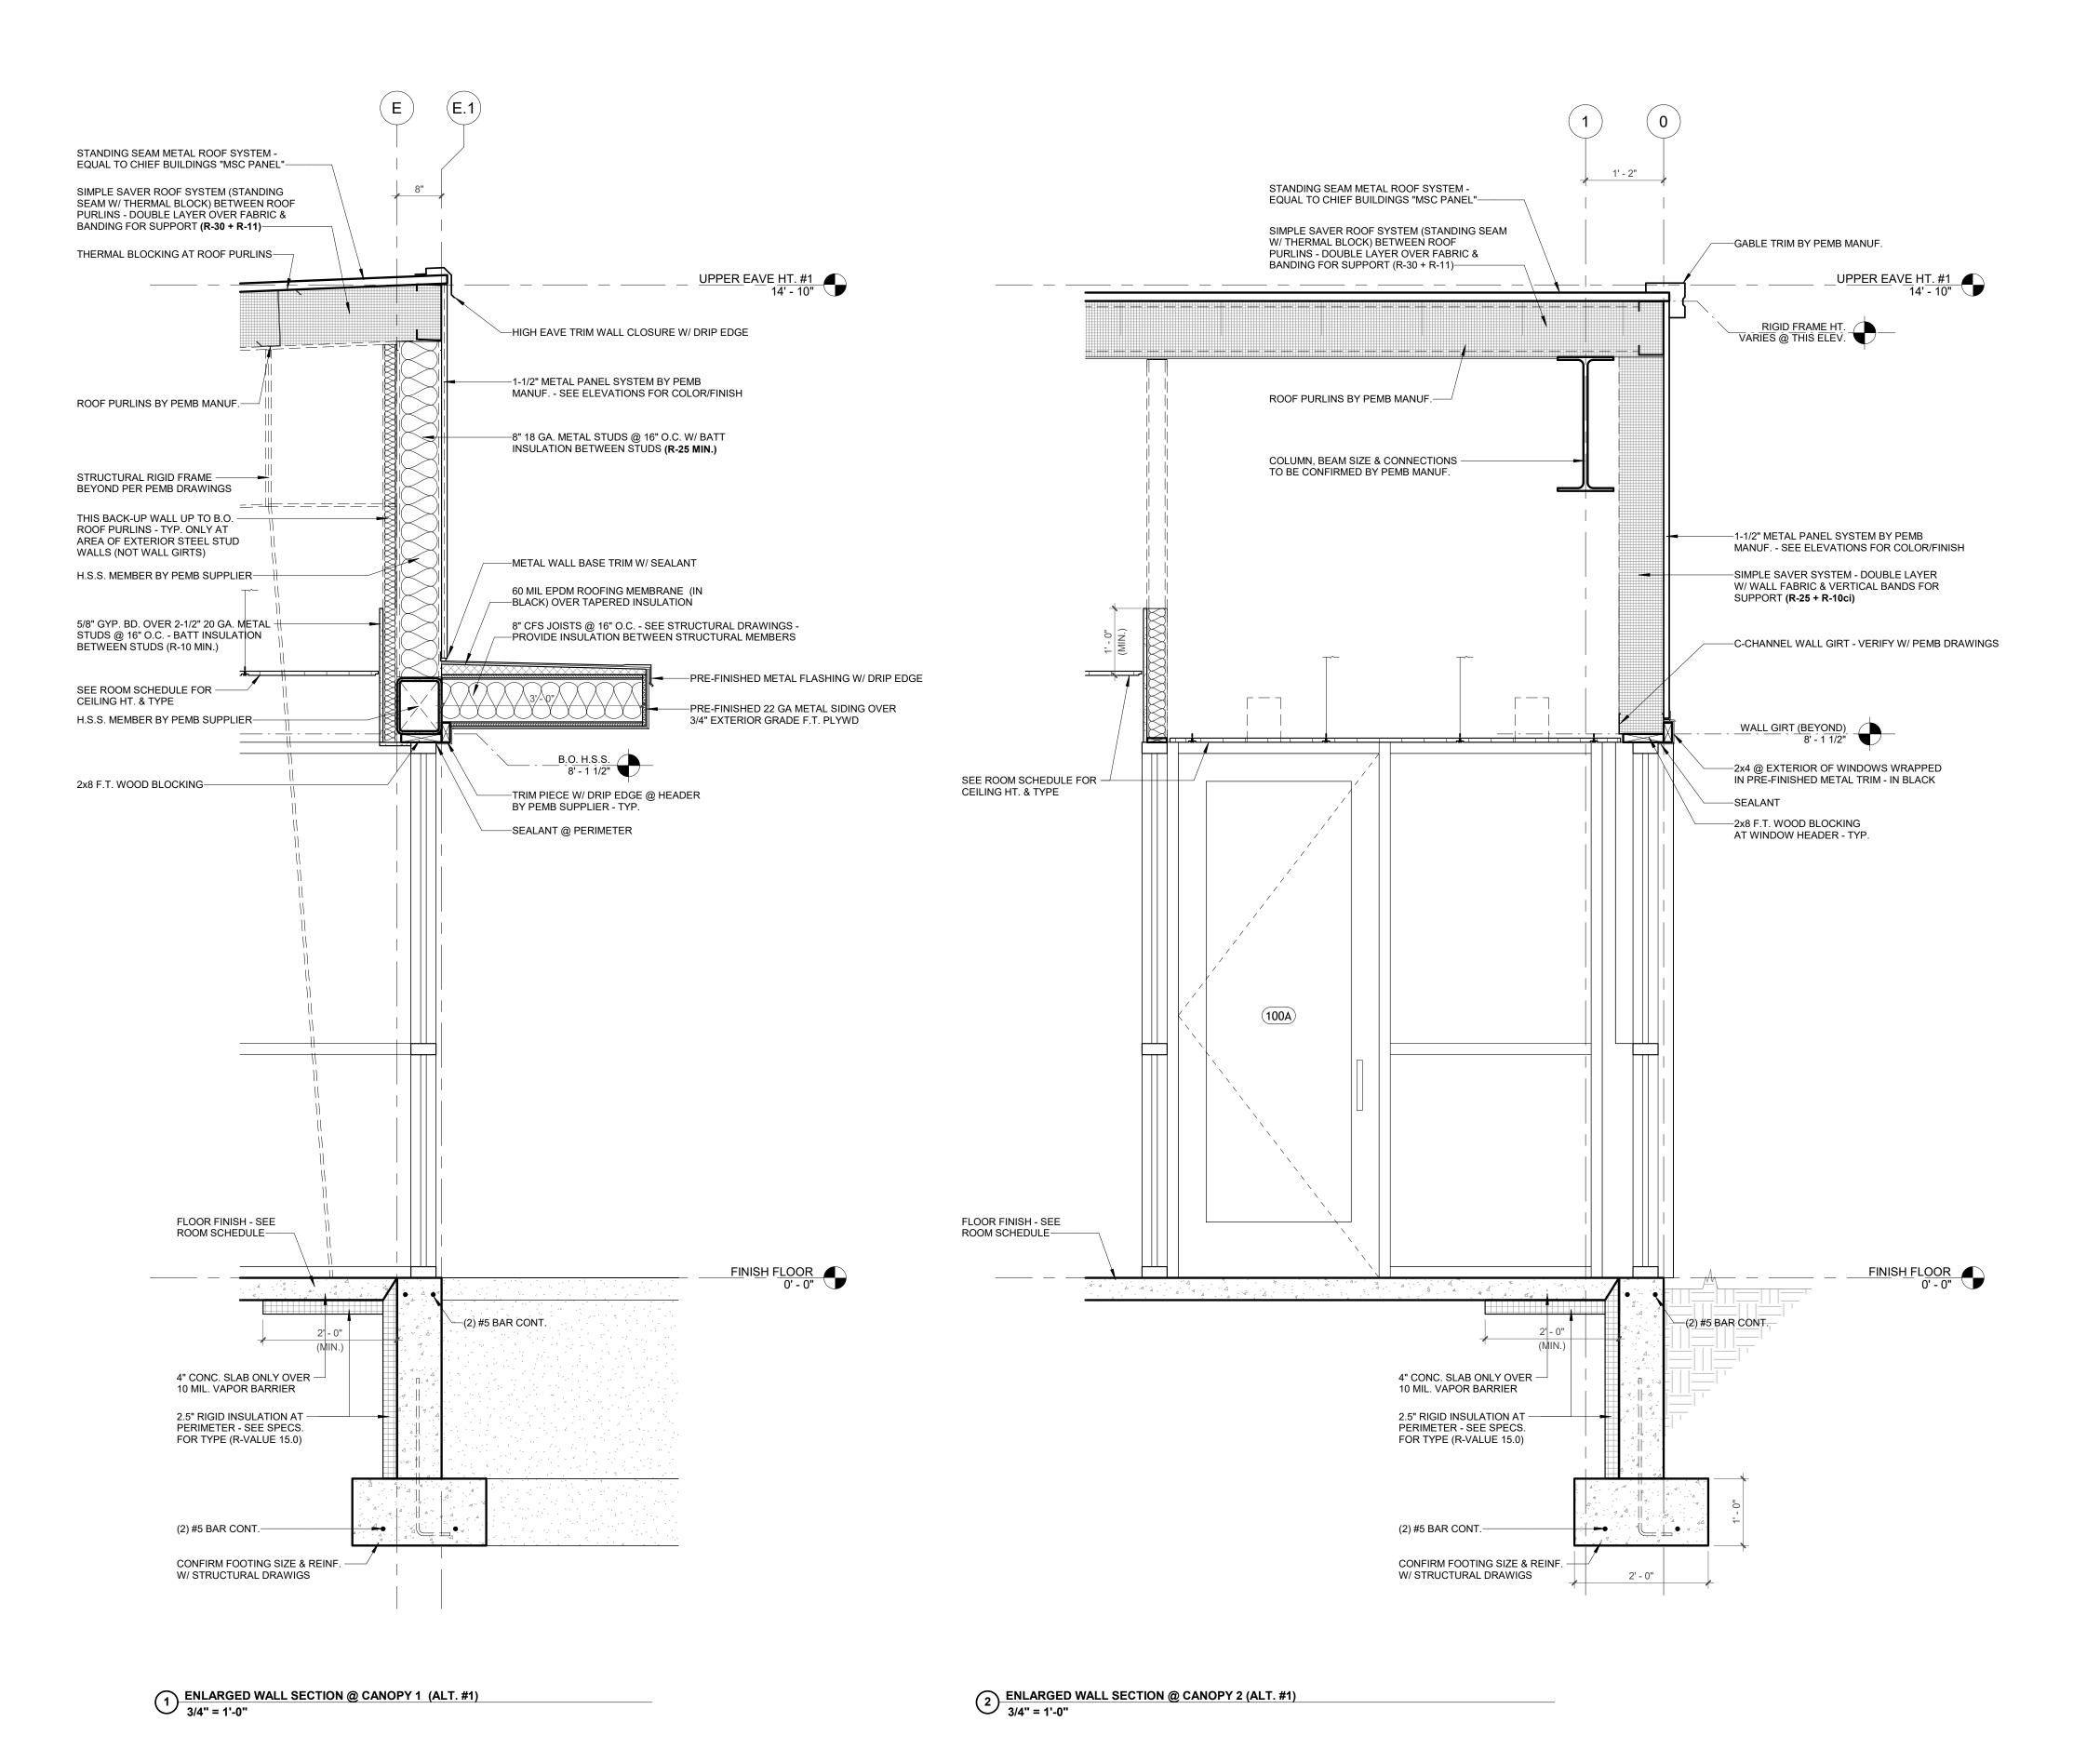3/4" = 1'-0"

Sheet Title


CANOPY SECTIONS -ALTERNATE #1


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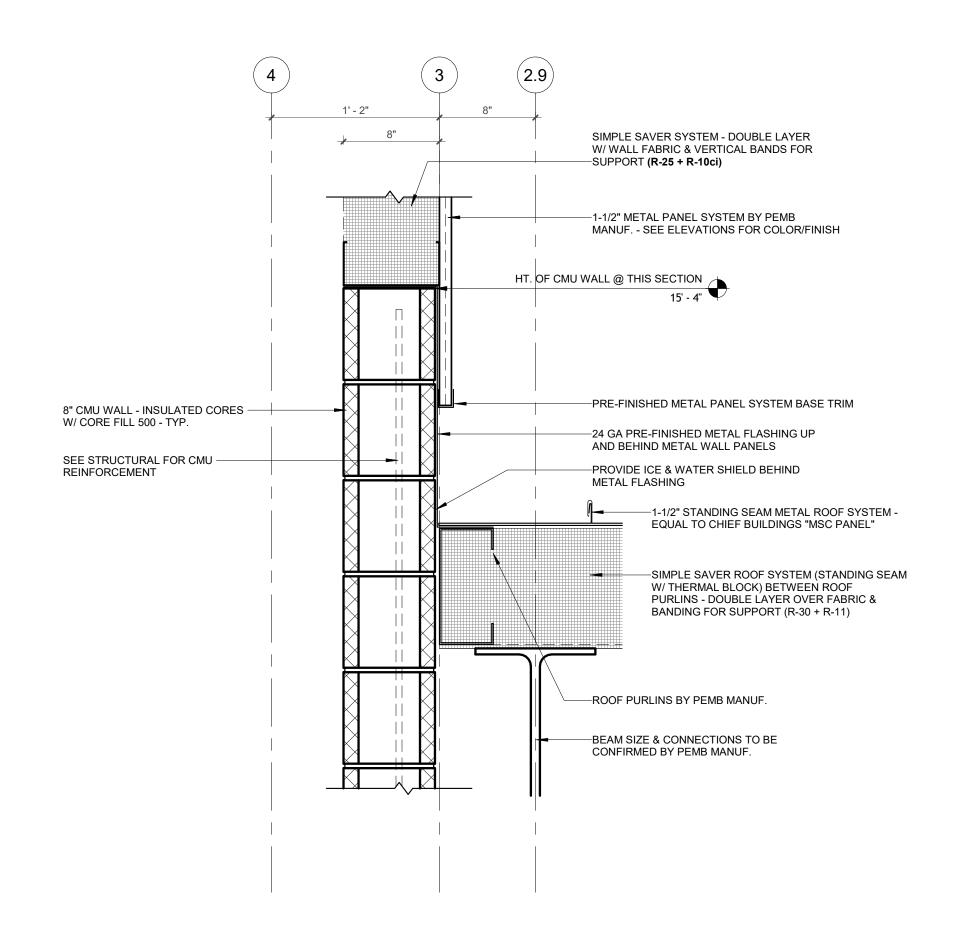
Sheet No.

2025-09

A506



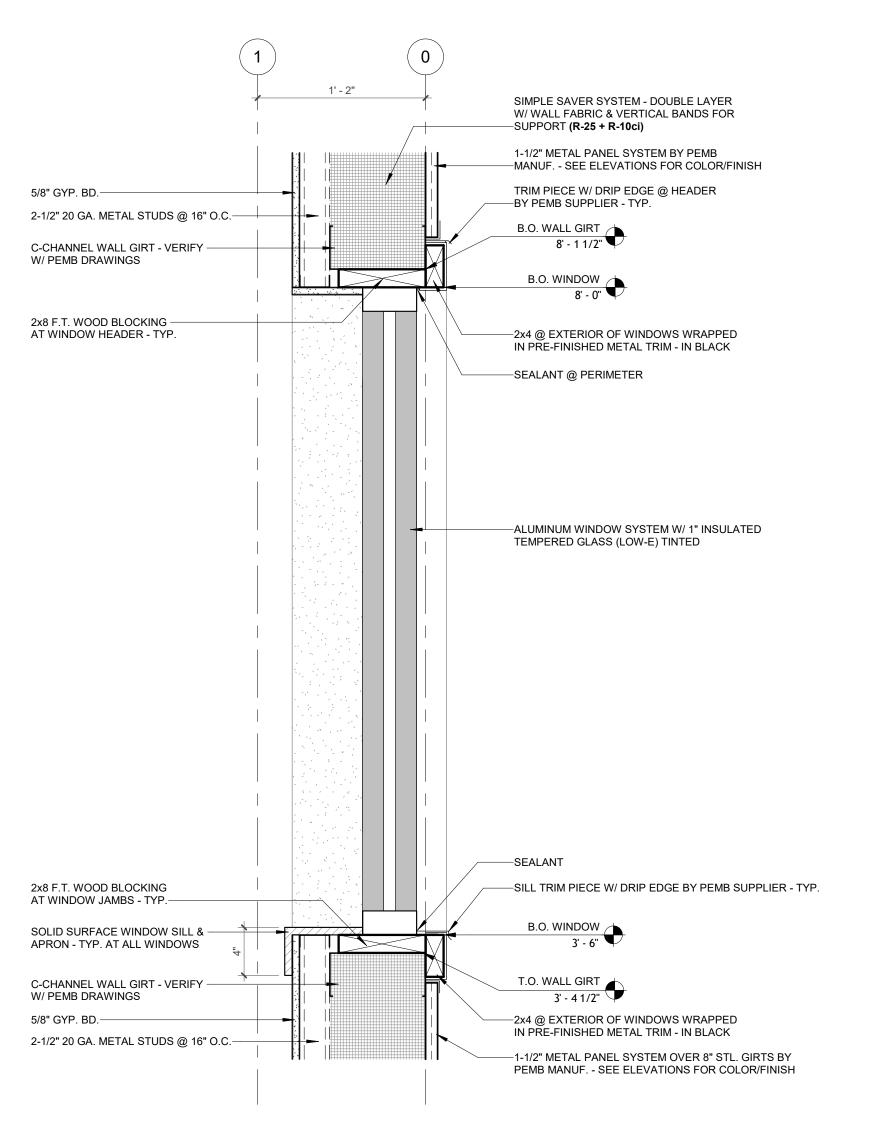


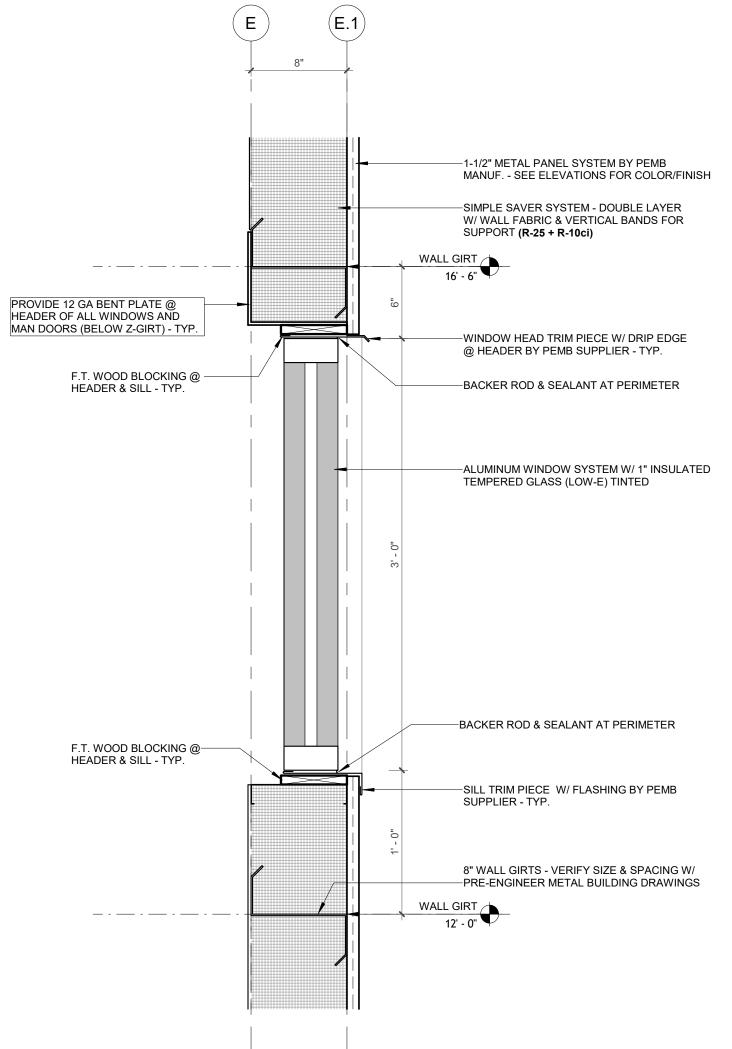

1 1/2" = 1'-0" WALL SECTION DETAIL OFFICE WINDOW - TYP.

WALL SECTION DETAIL @ GARAGE UPPER WINDOW 1 1/2" = 1'-0"

3 WALL SECTION DETAIL @ ABOVE CMU WALL PARTITION 1 1/2" = 1'-0"

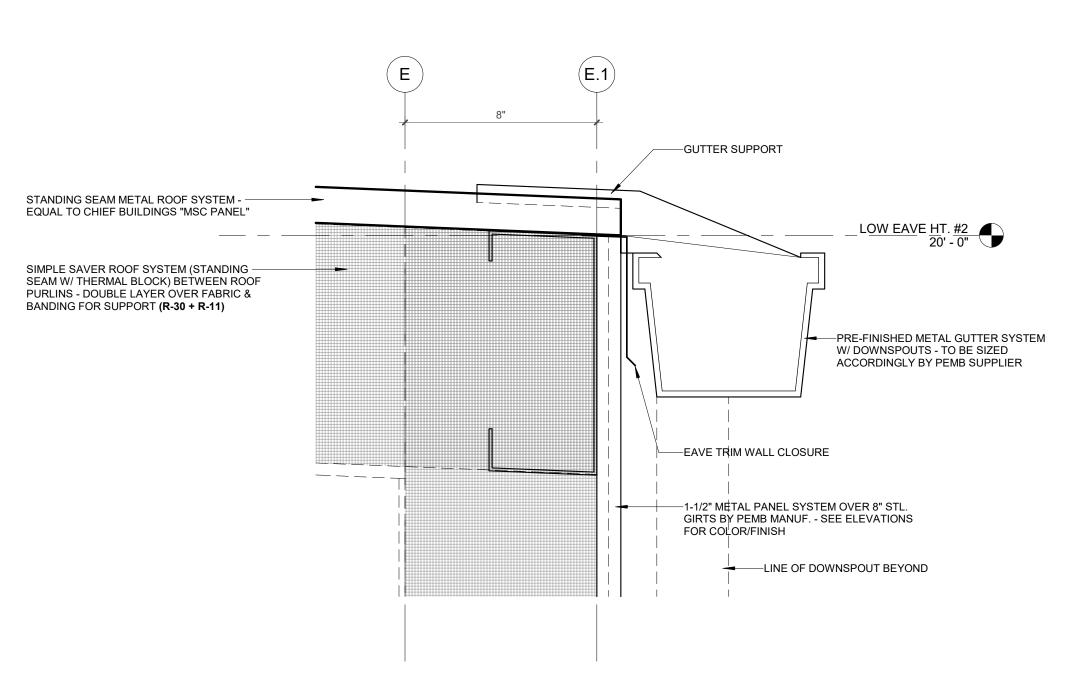

4 ENLARGED WALL SECTION @ GUTTER SYSTEM - TYP.

3" = 1'-0"



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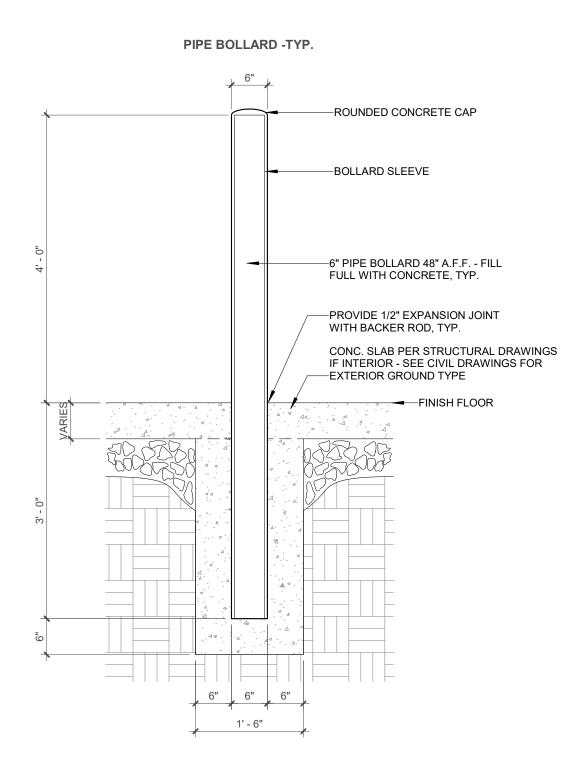
1)	05-08-2025	Initial Layo
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3)	08-27-2025	Design Developme
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WALL SECTION DETAILS


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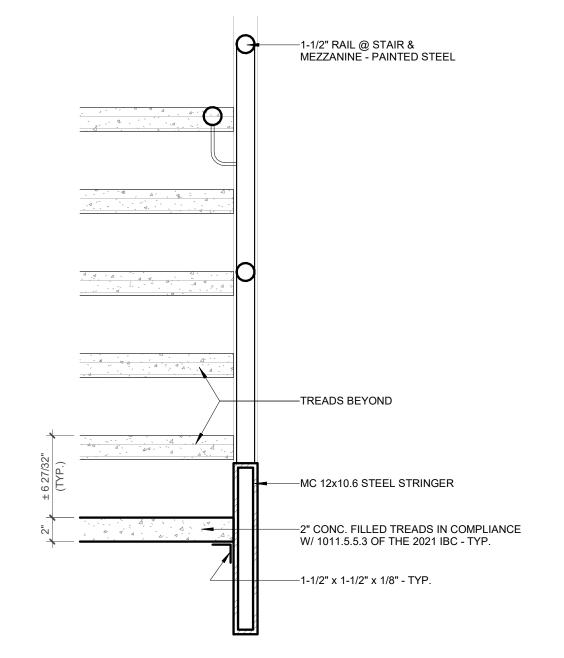
A601




3 PIPE BOLLARD SECTION - TYP. 3/4" = 1'-0"



1/2" = 1'-0" ENLARGED FLOOR PLAN @ METAL STAIRS

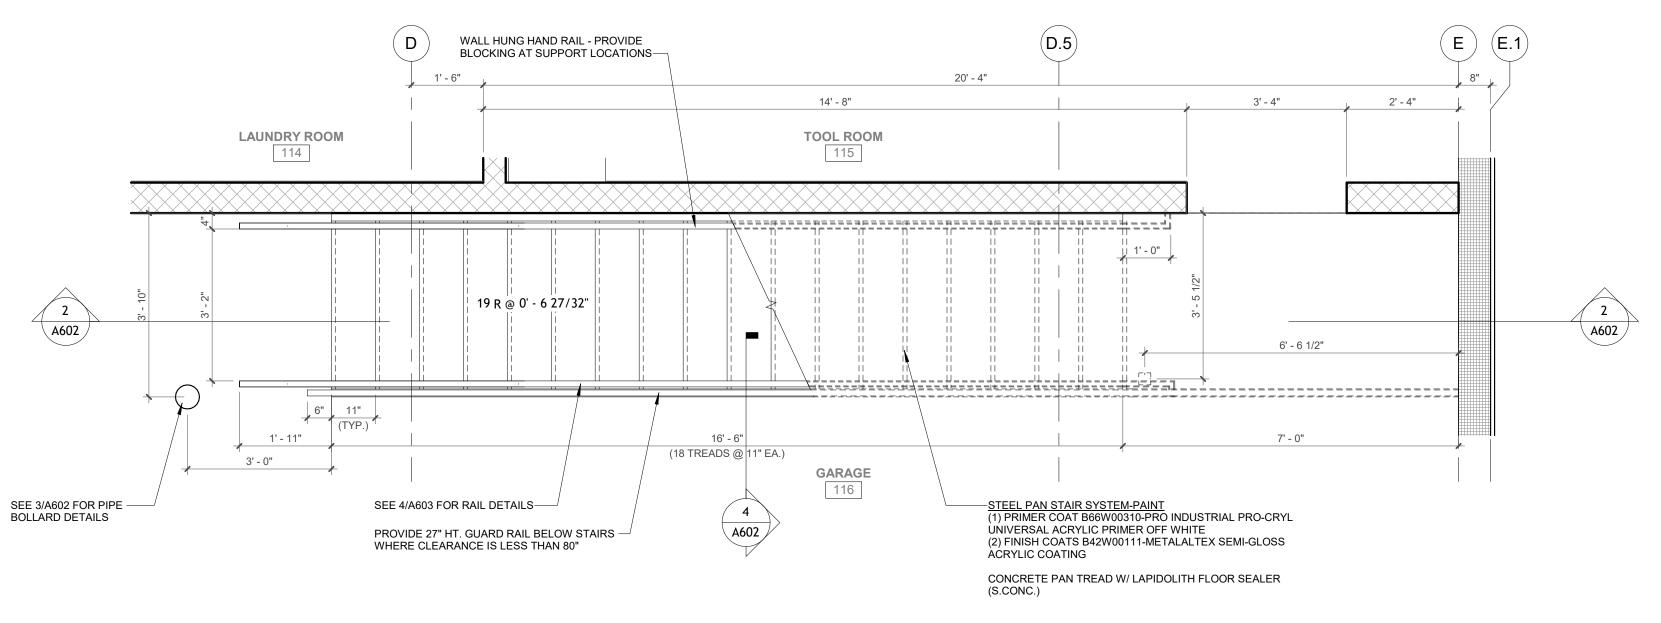


4 STAIR DETAIL @ RAIL - TYP.
1 1/2" = 1'-0"

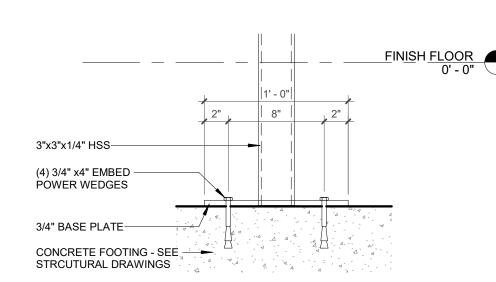

5 STAIR DETAIL @ COLUMN BASE - TYP.
1 1/2" = 1'-0"

2 ENLARGED SECTION @ METAL STAIRS
1/2" = 1'-0"

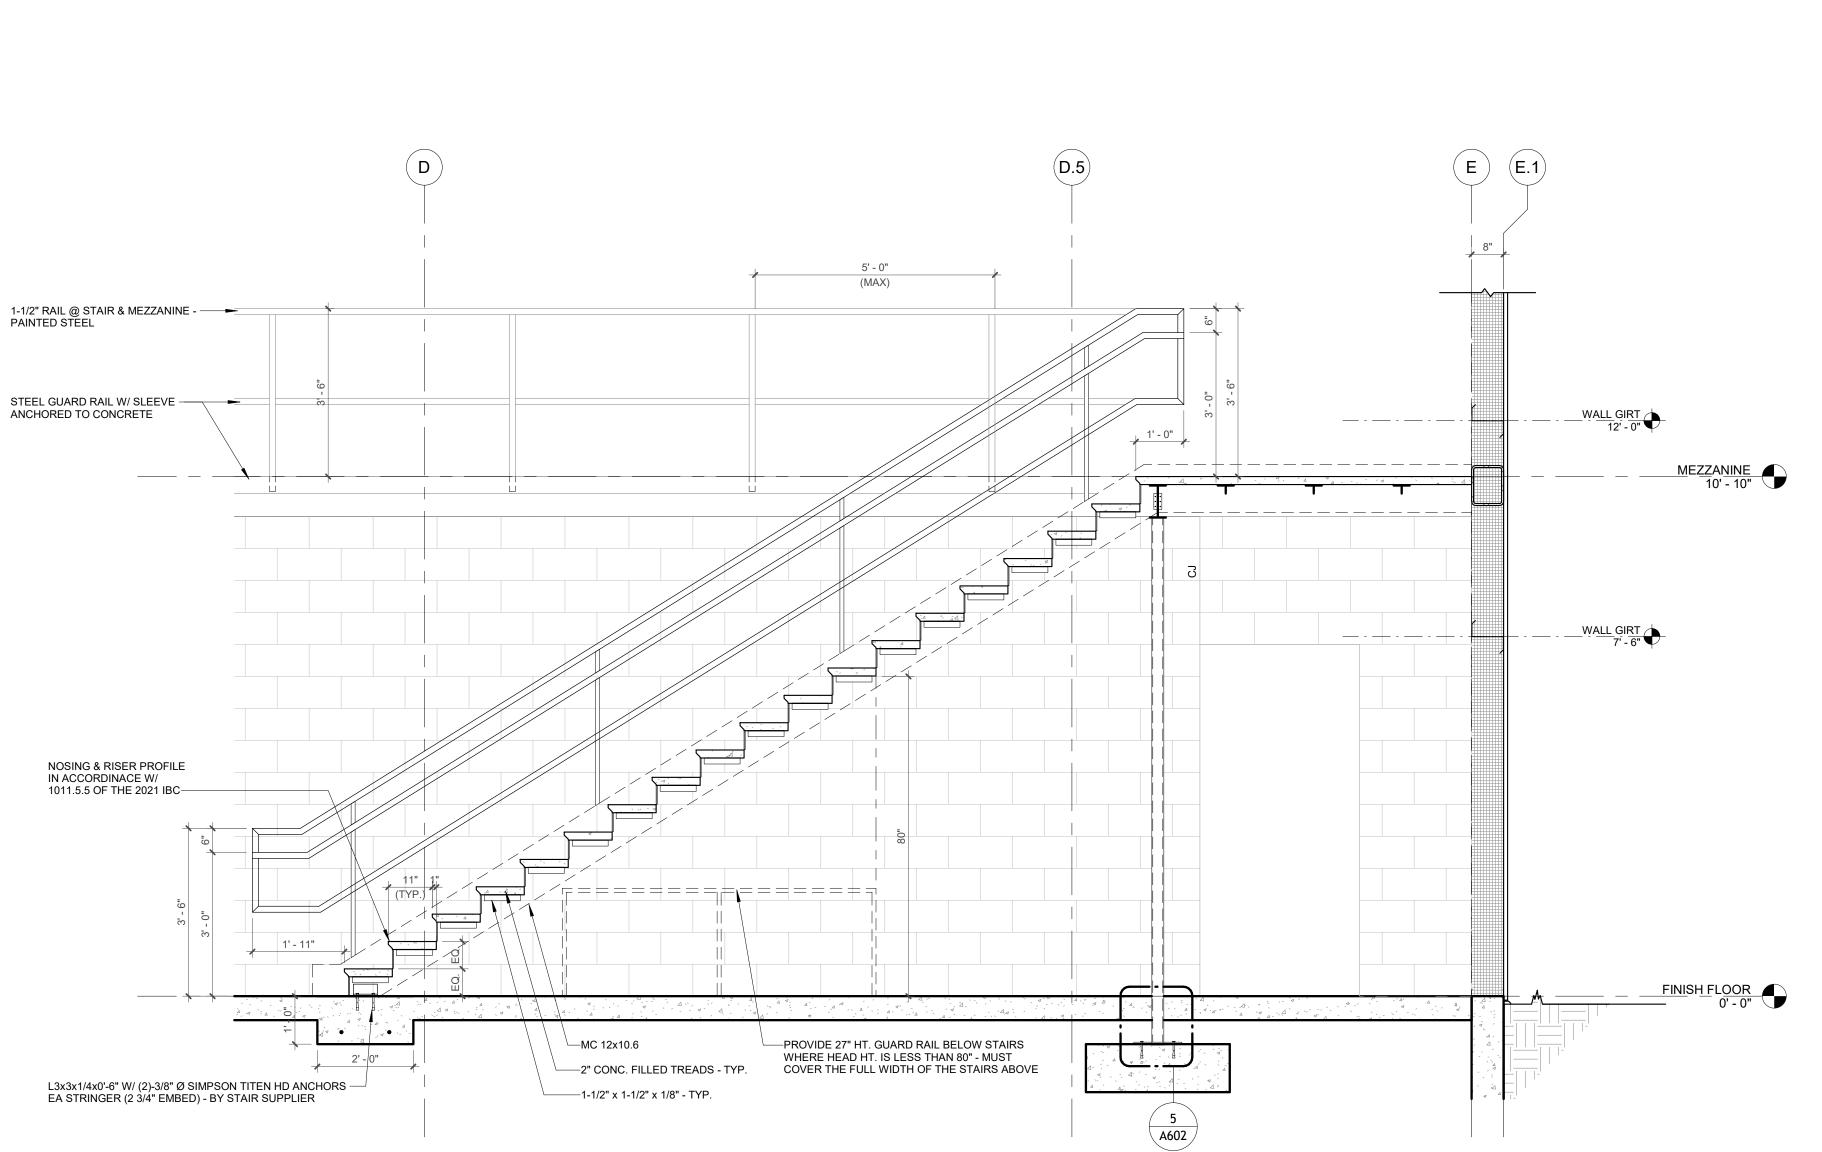

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METAL STAIRS DETAILS

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Sheet Title

Sheet No. A602

Sheet Number Sheet Name S000 3D VIEWS AND TITLE SHEET S001 STRUCTURAL GENERAL NOTES S002 STRUCTURAL GENERAL NOTES & SCHEDULES S100 OVERALL FOUNDATION PLAN S100-1 FOUNDATION PLAN S100-2 FOUNDATION PLAN S101 OVERALL MEZZANINE FRAMING PLAN S102 MEZZANINE FRAMING PLAN S103 ENLARGED FLOOR PLANS S104 ALTERNATE BID CANOPY S300 CONCRETE SECTIONS & DETAILS S301 CONCRETE SECTIONS & DETAILS S302 CONCRETE SECTIONS & DETAILS S340 PRECAST SECTIONS & DETAILS S400 MASONRY SECTIONS & DETAILS S600 WOOD SECTIONS, DETAILS, & ELEVATIONS
STRUCTURAL MATTHEW M. CHRISTIANSON 081-008029



STRUCTURAL SHEET INDEX

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12" = 1'-0"

DESCRIPTION

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C4E Project #: 25114 IL DESIGN FIRM 184-006824

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SECTIONS, AND DETAILS FOR THE COMPLETE STRUCTURAL REQUIREMENTS. IF

3D VIEWS AND TITLE SHEET

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S000

Sheet No.

DESIGN CRITERIA 1. BUILDING CODE - INTERNATIONAL BUILDING CODE (IBC) 2021 / ASCE7-16 WITH LOCAL ADOPTED AMENDMENTS. 2. DEAD LOADS MEZZANINE 125 PSF ROOF 15 PSF 3. ROOF LIVE LOADS 20 PSF 4. FLOOR LIVE LOADS 50 PSF OFFICES LOBBIES & FIRST FLOOR CORRIDORS 100 PSF CORRIDORS ABOVE FIRST FLOOR 80 PSF STORAGE (LIGHT) 125 PSF STAIRS 100 PSF 5. SNOW LOADS 30 PSF GROUND SNOW, Pg EXPOSURE FACTOR, Ce 1.0 TEMPERATURE FACTOR, Ct 1.1 SLOPED ROOF FACTOR, Cs 1.0 IMPORTANCE FACTOR, Is 1.0 23.1 PSF FLAT ROOF SNOW, Pf 23.1 PSF SLOPED ROOF SNOW, Ps SLIDING & DRIFTING SNOW, IN ADDITION TO FLAT ROOF SNOW, SEE PLANS UNBALANCED SNOW PER ASCE 7 WIND LOADS 115 MPH ULTIMATE WIND SPEED, V RISK CATEGORY EXPOSURE CATEGORY INTERNAL PRESSURE COEFFICIENT, Gcpi COMPONENTS & CLADDING NOT DESIGNED BY THE ENGINEER OF RECORD SHALL BE DESIGNED FOR THE WIND PRESSURES SHOWN ON THE COMPONENTS AND CLADDING DIAGRAM. WIND PRESSURES FOR LARGER TRIBUTARY AREAS MAY BE USED BASED ON DELEGATED DESIGN CALCULATIONS. 7. SEISMIC LOADS RISK CATEGORY IMPORTANCE FACTOR, I 1.0 SITE CLASS MAPPED SPECTRAL RESPONSE ACCELERATIONS 0.140 g 0.066 g SPECTRAL RESPONSE COEFFICIENTS SDS 0.120 g 0.094 g SEISMIC DESIGN CATEGORY SEISMIC FORCE RESISTING SYSTEM STEEL SYSTEMS NOT SPECIFICALLY DETAILED FOR SEISMIC RESISTANCE RESPONSE MODIFICATION FACTOR, R RESPONSE COEFFICIENT, Cs 0.042 Cs x (WEIGHT OF BUILDING) DESIGN BASE SHEAR **EQUIVALENT LATERAL FORCE** ANALYSIS PROCEDURE 8. SOIL DESIGN VALUES REFERENCE GEOTECHNICAL REPORT NUMBER: PREPARED BY CGGMT, INC. DATED **09/12/2025** ALL VALUES ARE ASSUMED UNLESS REFERENCED IN GEOTECHNICAL REPORT SOIL UNIT WEIGHT (Y) 120 PCF LATERAL EARTH PRESSURE ACTIVE (RETAINING WALLS) 45 PSF/FT (ASSUMED) AT-REST (BASEMENT WALLS) 60 PSF/FT (ASSUMED) PASSIVE / BEARING PRESSURE LATERAL 150 PSF/FT (ASSUMED) ALLOWABLE SOIL BEARING PRESSURES 2,000 PSF VERTICAL (NET) LATERAL SLIDING RESISTANCE COEFFICENT OF SLIDING FRICTION 0.25 (ASSUMED) SUBGRADE MODULUS 100 PCI 9. RAIN LOADS 6.37 IN/HR (15-MIN DURATION) RAIN INTENSITY 10. COMPONENT DESIGN PRECAST PLANK DEAD (SUPERIMPOSED) 50 PSF

SEE NOTE 4

L/480

L/360

DEFLECTION CRITERIA

GENERAL REQUIREMENTS

- 1. THE CONTRACT DOCUMENTS REPRESENT THE FINISHED STRUCTURE. THEY DO NOT INCLUDE THE METHOD OF CONSTRUCTION. CONTRACTOR SHALL PROVIDE ALL MEASURES NECESSARY TO PROTECT THE STRUCTURE DURING CONSTRUCTION. SUCH MEASURES SHALL INCLUDE, BUT NOT BE LIMITED TO: BRACING, SHORING FOR LOADS DUE TO CONSTRUCTION EQUIPMENT, TEMPORARY STRUCTURES. AND PARTIALLY COMPLETED WORK. OBSERVATION VISITS TO THE SITE BY STRUCTURAL ENGINEER SHALL NOT INCLUDE INSPECTION OF THE ABOVE ITEMS.
- 2. GENERAL CONTRACTOR TO DISTRIBUTE ALL SHEETS IN THE SET TO SUBCONTRACTORS
- 3. THE ARCHITECT AND/OR ENGINEER OF RECORD SHALL NOT HAVE CONTROL OVER OR BE IN CHARGE OF, AND SHALL NOT BE RESPONSIBLE IN ANY WAY FOR CONSTRUCTION MEANS, METHODS TECHNIQUES, SEQUENCES, OR PROCEDURES, OR FOR SAFETY OR SAFETY PRECAUTIONS AND PROGRAMS IN CONNECTION WITH ANY CONSTRUCTION ACTIVITIES, SINCE THESE ARE SOLELY THE CONTRACTOR'S RESPONSIBILITY.
- SUBMITTALS PREPARED BY SUBCONTRACTORS SHALL BE REVIEWED BY
- CONTRACTOR PRIOR TO SUBMITTING TO ARCHITECT/ENGINEER. 5. CONTRACTOR SHALL VERIFY DIMENSIONS AND CONDITIONS AT THE JOB SITE ANY DISCREPANCIES BETWEEN THE CONDITIONS FOUND AND THOSE INDICATED IN THE CONTRACT DOCUMENTS SHALL BE BROUGHT TO THE
- ATTENTION OF ARCHITECT PRIOR TO PROCEEDING WITH THE WORK. 6. SEE DOCUMENTS FROM OTHER DISCIPLINES FOR FLOOR, WALL, AND ROOF OPENINGS, TRENCHES, PITS, PIPE SLEEVES, EQUIPMENT PADS, METAL PAN STAIRS, MISCELLANEOUS IRON, ETC.
- 7. DO NOT PLACE PIPES, DUCTS, CHASES, ETC. IN STRUCTURAL BEAM AND COLUMN MEMBERS. DO NOT CUT ANY STRUCTURAL MEMBER FOR PIPES, DUCTS, ETC., UNLESS NOTED OTHERWISE. NOTIFY STRUCTURAL ENGINEER WHEN DOCUMENTS BY OTHER DISCIPLINES SHOW OPENINGS, POCKETS, ETC NOT INDICATED IN THE STRUCTURAL DRAWINGS BUT ARE LOCATED IN THE STRUCTURAL MEMBERS. CONTRACTOR SHALL OBTAIN PRIOR APPROVAL FROM STRUCTURAL ENGINEER FOR INSTALLATION OF SUCH PIPES, DUCTS CHASES, ETC.
- 8. DETAILS LABELED "TYPICAL" ON THE STRUCTURAL DRAWINGS APPLY TO ALL SITUATIONS OCCURRING ON PROJECT THAT ARE THE SAME OR SIMILAR TO THOSE LOCATIONS SPECIFICALLY INDICATED. WHERE A DETAIL IS NOT INDICATED, THE DETAIL SHALL BE THE SAME AS FOR OTHER SIMILAR CONDITIONS.
- 9. DELEGATED DESIGNED ELEMENTS SHALL BE DESIGNED BY LICENSED PROFESSIONAL ENGINEERS REGISTERED IN THE STATE WHERE THE PROJECT IS LOCATED. GENERAL CONTRACTOR SHALL SUBMIT SHOP DRAWINGS, DESIGN LOAD DATA, SUPPORT REACTIONS, AND CERTIFICATION THAT ELEMENTS WERE DESIGNED FOR LOADS SPECIFIED IN THE CONTRACT DOCUMENTS OR IN THE BUILDING CODE. ALLOW MINIMUM 10 BUSINESS DAYS FOR REVIEW BY EOR. ALL DOCUMENTS NOTED SHALL BE SEALED BY THE LICENSED ENGINEER. IF CRITERIA INDICATED ARE NOT SUFFICIENT, SUBMIT A WRITTEN REQUEST FOR ADDITIONAL INFORMATION TO THE ARCHITECT. THE FOLLOWING ELEMENTS AND THEIR CONNECTIONS SHALL BE CONTRACTOR
 - A. STRUCTURAL STEEL CONNECTIONS NOT DETAILED OR SHOWN ON THE DRAWINGS
- B. STEEL STAIRS, LADDERS, HANDRAILS & GUARDS PREFABRICATED METAL BUILDINGS
- PRECAST ELEMENTS INCLUDING: FLOOR PLANKS & CONNECTIONS
- E. STRUCTURAL GLUE-LAMINATED TIMBER & CONNECTIONS F. PREFABRICATED EXTERIOR CANOPIES & BALCONIES
- G. EARTH RETENTION SYSTEMS H. TEMPORARY SHORING DURING CONSTRUCTION

METAL BUILDING SYSTEM

- 1. METAL BUILDING WORK SHALL CONFORM TO THE FOLLOWING LATEST EDITION: A. AISC - "SPECIFICATION FOR DESIGN, FABRICATION AND ERECTION OF STEEL
- B. AISC "CODE OF STANDARD PRACTICE FOR STEEL BUILDINGS AND BRIDGES" C. AWS D1.1 - " STRUCTURAL WELDING CODE - STEEL"
- D. AISC "STRUCTURAL STEEL DETAILING MANUAL".
- MBMA "METAL BUILDING SYSTEMS MANUAL". F. DESIGN LOADS AND CODE AS NOTED ON THESE DRAWINGS.
- 2. THE METAL BUILDING SHALL BE DESIGNED AND FABRICATED BY A MBMA MEMBER MANUFACTURER.
- 3. THE METAL BUILDING MANUFACTURER (MBM) SHALL PROVIDE STAMPED DRAWINGS AND CALCULATIONS BY A REGISTERED PROFESSIONAL ENGINEER LICENSED IN THE JURISDICTION IN WHICH THE BUILDING IS LOCATED.
- 4. THE MBM SHALL CONFORM TO THE FOLLOWING DEFLECTION CRITERIA AISC -"DESIGN GUIDE #3 SERVICEABILITY DESIGN CONSIDERATIONS FOR STEEL BUILDING" UNLESS NOTED ON THE DRAWINGS.
- 5. ANCHOR RODS SHALL BE PRESET WITH TEMPLATES.
- THE MBM SHALL BE RESPONSIBLE FOR ALL CONNECTIONS, STIFFENERS, AND ETC. REQUIRED TO SAFELY ERECT THE BUILDING. THE MBM IS RESPONSIBLE FOR ANY REQUIRED HOLES SHOWN PASSING THROUGH THE MBM STEEL ON THE DRAWINGS. 7. THE MBM SHALL PROVIDE FOUNDATION REACTIONS, COLUMN LOCATIONS AND
- BASE PLATE SIZES TO THE ENGINEER IN A TIMELY MANNER. CHANGES TO, OR OMISSIONS OF REACTIONS, ETC. BY THE MBM THAT REQUIRE REDESIGN OF THE FOUNDATIONS WILL REQUIRE ADDITIONAL ENGINEERING FEES.
- 8. ALL WELDS SHALL BE MADE BY ASW CERTIFIED WELDERS CERTIFIED IN THE POSITION IN WHICH THE WELD IS TO BE MADE.
- 9. THE ERECTION OF ANY STRUCTURAL STEEL MEMBERS SHALL NOT COMMENCE UNTIL ALL SUPPORTING CONCRETE/MASONRY ELEMENTS HAVE ATTAINED AT LEAST 75% OF THEIR INTENDED MINIMUM COMPRESSIVE STRENGTH.
- 10. THE CONTRACTOR SHALL PROVIDE TEMPORARY ERECTION BRACING AND SUPPORTS AS REQUIRED FOR THE SAFE ERECTION OF ALL STEEL. TEMPORARY BRACING SHALL REMAIN IN PLACE UNTIL PERMANENT BRACING HAS BEEN INSTALLED AND FLOOR SLAB CONCRETE HAS ATTAINED 75% OF ITS REQUIRED
- 11. STRUCTURAL STEEL SHALL BE TRUE AND PLUMB BEFORE FINAL BOLTING OR
- WELDING OF CONNECTIONS. 12. THE CONTRACTOR SHALL NOT MODIFY OR CUT ANY STRUCTURAL STEEL WITHOUT
- WRITTEN APPROVAL FROM THE EOR AND MBM. 13. THE CONTRACTOR SHALL FIELD TOUCH UP ALL ABRASIONS, BURNS AND SIMILAR DEFECTS IN PAINT OF STRUCTURAL STEEL.

SPREAD FOUNDATIONS

- 1. ALL FOUNDATIONS SHALL BE SUPPORTED ON APPROVED EXISTING SUBGRADE OR APPROVED COMPACTED STRUCTURAL FILL HAVING A MINIMUM ALLOWABLE BEARING CAPACITY AS INDICATED IN THE SOIL DESIGN VALUES.
- 2. SUBSURFACE CONDITIONS SHALL BE IMPROVED TO MEET CAPACITY AS REQUIRED, WHEN RECOMMENDED IN GEOTECHNICAL REPORT. 3. THE ENGINEER ASSUMES NO RESPONSIBILITY FOR THE VALIDITY OF THE
- SUBSURFACE CONDITIONS DESCRIBED IN THE DRAWINGS. SPECIFICATIONS TEST BORINGS OR GEOTECHNICAL REPORTS. THIS DATA IS INCLUDED TO ASSIST THE CONTRACTOR DURING BIDDING AND SUBSEQUENT CONSTRUCTION, AND TO REPRESENT CONDITIONS ONLY AT SPECIFIC LOCATIONS AT THE PARTICULAR TIME THE OBSERVATIONS WERE MADE.
- 4. ALL EXTERIOR FOUNDATIONS SHALL BEAR ON APPROVED SUBGRADE EXTENDED BELOW THE FROST LINE DEPTH OF THE LOCALITY.
- 5. FOOTING ELEVATIONS SHOWN ON THE DRAWINGS REPRESENT ESTIMATED DEPTHS AND ARE NOT TO BE CONSTRUED AS LIMITING THE AMOUNT OF EXCAVATION REQUIRED TO REACH SUITABLE BEARING MATERIAL. 6. THE CONTRACTOR SHALL PROVIDE TEMPORARY SUPPORTS IN ALL EXCAVATIONS AS REQUIRED TO PREVENT HORIZONTAL MOVEMENT OR
- VERTICAL SETTLEMENT OF SURROUNDING SOIL AND/OR PROPERTY WHICH WILL ENDANGER LIVES OR PROPERTY. 7. THE CONTRACTOR SHALL PROVIDE CONTROL OF SURFACE AND SUBSURFACE
- WATER PROMPTLY TO ENSURE THAT ALL FOUNDATION WORK IS PERFORMED IN A DRY CONDITION.
- 8. FOUNDATIONS SHALL NOT BE PLACED ON FROZEN SUBGRADE. 9. THE CONTRACTOR SHALL PROTECT IN-PLACE FOUNDATIONS AND SLABS-ON-
- GRADE FROM FROST PENETRATION UNTIL THE PROJECT IS COMPLETE. 10. FOUNDATION WALLS SHALL BE BRACED DURING BACKFILLING AND COMPACTION OPERATIONS. BRACING SHALL BE LEFT IN PLACE UNTIL PERMANENT STRUCTURAL SUPPORT SYSTEM IS INSTALLED AND APPROVED BY THE ENGINEER
- 11. WHERE FOUNDATION WALLS HAVE FILL ON BOTH SIDES, BACKFILLING SHALL BE DONE SIMULTANEOUSLY ON BOTH SIDES OF THE WALL

CONCRETE

CODES & S	TANDARDS:
ACI 301	SPECIFICATIONS FOR CONCRETE CONSTRUCTION
ACI 305	GUIDE TO HOT WEATHER CONCRETING
ACI 306	GUIDE TO COLD WEATHER CONCRETING
ACI 318	BUILDING CODE REQUIREMENTS FOR STRUCTURAL CONCRETE

FOOTINGS	f'c=3,000 PSI
INTERIOR SLAB ON GRADE	f'c=4,000 PSI
EXTERIOR SLAB ON GRADE (EXCLUDING SIDEWALKS)	f'c=5,000 PSI
FOUNDATION WALLS / GRADE BEAMS / PIERS	f'c=4,500 PSI
BEAMS / COLUMNS	f'c=4,000 PSI
CONCRETE ON METAL DECK	f'c=4,000 PSI
CONCRETE TOPPING	f'c=4,000 PSI

- 1. CONCRETE MIX DESIGN (INCLUDING AGGREGATE SIZE, WATER CEMENT RATIO, AIR ENTRAINMENT, ADMIXTURES, SLUMP AND HISTORY OF BREAK TESTS) SHALL BE SUBMITTED TO THE EOR FOR APPROVAL PRIOR TO THE COMMENCEMENT OF ANY WORK. CONCRETE SHALL BE NORMAL WEIGHT
- 2. MAXIMUM WATER/CEMENT RATIO PERMITTED SHALL BE 0.55 FOR FOOTINGS, 0.50 FOR INTERIOR SLABS ON GRADE, 0.45 FOR BELOW GRADE CONCRETE AND 0.40 FOR CONCRETE EXPOSED TO WATER AND DEICING CHEMICALS.
- 3. CONCRETE WHICH WILL BE EXPOSED TO THE WEATHER (INCLUDING FOUNDATION WALLS) SHALL HAVE AIR-ENTRAINING ADMIXTURE AS REQUIRED TO PROVIDE 6% ± 1% AIR ENTRAINMENT
- 4. MAXIMUM AGGREGATE SIZE SHALL BE 3/4" FOR SLABS ON GRADE, WALLS, BEAMS & COLUMNS, 1" FOR FOOTINGS AND 3/8" FOR TOPPING SLABS. NORMAL WEIGHT AGGREGATE TO CONFORM TO ASTM C33, LIGHTWEIGHT AGGREGATE TO CONFORM TO ASTM C330.
- CONCRETE SHALL BE EVALUATED ACCORDING TO METHOD 1 OR METHOD 2 AS DESCRIBED IN ACI 301. THE RESULTS OF THESE ANALYSES SHALL BE SUBMITTED TO THE EOR FOR APPROVAL PRIOR TO ANY WORK.
- 6. THE CONTRACTOR SHALL MAKE PROVISIONS TO ALLOW AN INDEPENDENT TESTING AGENCY TO CAST 4 TEST CYLINDERS FOR EACH 50 CUBIC YARDS OF CONCRETE PLACED, OR FOR ANY DAY'S OPERATION. THE TESTING AGENCY SHALL BE RESPONSIBLE FOR CASTING AND CURING SPECIMENS IN COMPLIANCE TO ASTM C31 AND CASTING TESTING SPECIMENS IN COMPLIANCE TO ASTM C39.
- DRAWINGS SHOWING THE LOCATION OF CONSTRUCTION JOINTS, CONTROL JOINTS, AND PLACING SEQUENCE SHALL BE SUBMITTED TO THE ENGINEER FOR APPROVAL PRIOR TO THE PREPARATION OF REINFORCING SHOP DRAWINGS. MAXIMUM POUR LENGTHS OF WALLS TO BE 40'-0" AND A MINIMUM OF 4'-0" AWAY FROM INTERSECTIONS AND CORNERS.
- GROUT USED TO SET PLATES SHALL BE NON-SHRINK AND NON-METALLIC. 9. THE CONTRACTOR SHALL USE SMOOTH FORMS FOR EXPOSED CONCRETE
- SURFACES. BOARD FORMS MAY BE USED FOR UNEXPOSED CONCRETE SURFACES, EARTH FORMS ARE FORBIDDEN. 10. PROVIDE COMPACTED GRANULAR FILL UNDER ALL SLABS ON GRADE, SEE
- CONCRETE SLAB ON GRADE SCHEDULE. 11. VAPOR BARRIER TO BE AS INDICATED ON TYPICAL SLAB JOINT DETAIL, LAP MINIMUM 6" AND TAPE ALL SEAMS. VERIFY ADDITIONAL REQUIREMENTS WITH ARCHITECTURAL SPECIFICATIONS.
- 12. FLOOR FLATNESS AND LEVELNESS OF SLAB ON GRADE CONCRETE SHALL HAVE THE FOLLOWING TOLERANCES, AS RECOGNIZED BY THE MOST CURRENT VERSION OF ASTM E 1155 AND ACI 302.1. SEE SPECIFICATION FOR FURTHER REQUIREMENTS (F(F) SPECIFIED OVERALL VALUE (SOV) OF 50. MINIMUM LOCALIZED VALUE (MLV) OF 25 AND F(L) SPECIFIED OVERALL VALUE (SOV) OF 33, MINIMUM LOCALIZED VALVE (MLV) OF 17).

CONCRETE REINFORCING

WELDED WIRE FABRIC

MACRO FIBER REINFORCING

ACI 315	GUIDE TO PRESENTING REINFORCING STEEL DESIGN DETAILS		
ACI 318	BUILDING CODE REQUIREMENTS FOR STRUCTURAL CONCRETE		
MSP2	CRSI MANUAL OF STANDARD PRACTICE		
AWS D1.4	STRUCTURAL WELDING CODE - REINFORCING STEEL		
WRI	WELDED WIRE FABRIC MANUAL OF STANDARD PRACTIC		

	WELDABLE REINFORCING BARS	ASTM A706	Fy=60 KSI
1.	THE REINFORCEMENT FABRICATOR S SHOP DRAWINGS ALL REQUIRED REIN		
	ACCESSORIES TO HOLD REINFORCEM	IENT SECURELY IN PLAC	CE AT THE

ASTM A185

ASTM C1116 Type III

- CORRECT LOCATIONS. THE REQUIRED CLEARANCE FOR REINFORCEMENT (UNO) SHALL BE 3" FOR CONCRETE PLACED DIRECTLY AGAINST EARTH, 2" (#6 & LARGER) AND 1 1/2" (#5 & SMALLER) FOR CONCRETE EXPOSED TO EARTH OR WEATHER, 1 1/2" (# 14 & LARGER) AND 3/4" (#11 & SMALLER) FOR CONCRETE NOT EXPOSED TO EARTH OR WEATHER.
- THE CONTRACTOR SHALL REFER TO TYPICAL DETAILS SHOWN ON THE CONTRACT DRAWINGS FOR ADDITIONAL REINFORCING REQUIREMENTS
- WHERE REINFORCEMENT IS REQUIRED IN SECTIONS, REINFORCEMENT IS CONSIDERED TYPICAL WHEREVER THE SECTION APPLIES WELDED WIRE FABRIC SHALL HAVE A MINIMUM OF 6" LAP AND BE TIED
- TOGETHER. 6. THE CONTRACTOR SHALL NOTIFY THE ARCHITECT OF COMPLETION OF REINFORCEMENT INSTALLATION AND ALLOW AT LEAST 24 HOURS BEFORE SCHEDULED CONCRETE PLACEMENT FOR THE ARCHITECT TO INSPECT REINFORCEMENT.
- MACRO FIBER TO BE 1-1/2" MINIMUM LENGTH, WHERE INDICATED IN CONCRETE SLAB ON GRADE OR METAL DECK SCHEDULE.

PRECAST CONCRETE

CODES & STANDARDS:	
PCI MNL	PCI DESIGN HANDBOOK - PRECAST AND PRESTRESSED CONCRETE
ACI 318	BUILDING CODE REQUIREMENTS FOR STRUCTURAL CONCRETE

- 1. THE PRECAST SUPPLIER SHALL DESIGN AND PROVIDE TO THE ARCHITECT/ENGINEER PLANS AND CALCULATIONS SIGNED AND SEALED BY A REGISTERED PROFESSIONAL ENGINEER LICENSED IN THE LOCAL JURISDICTION OF THE BUILDING.
- PRECAST MEMBERS SHALL BE ATTACHED AND SUPPORTED BY THE STRUCTURE AS INDICATED ON THE DRAWINGS. ALL JOINTS SHALL BE
- PRECAST MEMBERS SHALL BE DESIGNED AND REINFORCED FOR SELF WEIGHT PLUS THE SUPERIMPOSED LOADS SHOWN ON THE DRAWINGS. HANDLING AND ERECTION LOADS.
- THE PRECAST CONTRACTOR SHALL DESIGN, FURNISH AND INSTALL ALL MATERIAL (HANGERS, PLATES, CLIPS, HEADERS, ANCHORS, ETC.) WHICH
- MUST BE PRECAST INTO MEMBERS UNLESS NOTED OTHERWISE COORDINATE WITH ALL OTHER TRADES ALL HOLES OR OPENINGS THROUGH THE PRECAST BEFORE FABRICATION. ALL HOLES GREATER THAN 8" SHALL BE SHOP FABRICATED. ALL HOLES LESS THAN 8" MAY BE FIELD CUT. ALL FIELD CUT HOLES SHALL BE APPROVED BY THE PRECAST
- REINFORCE TOPPING SLABS W/ FORTA FERRO FIBER REINF (3 LB/CY) UNO SEE ALSO CONCRETE SPECIFICATIONS.

REINFORCED MASONRY

ACI 530.1/ASCE 6/TMS 602 SPECIFICATION FOR MASONRY STRUCTURES ACI 530/ASCE 5/TMS 402 | BUILDING CODE REQUIREMENTS FOR

MASON	IRY STRUCTURES	
MATERIALS:		
CONCRETE MASONRY BLOCK	ASTM C-90	2,000 PSI
TYPE M/S MORTAR	ASTM C270	
GROUT (28 DAY STRENGTH)	ASTM C476	2,000 PSI
REINFORCING BARS	ASTM A615 Gr 60	Fy=60 KSI

- THE REQUIRED MINIMUM 28 DAY COMPRESSIVE STRENGTH OF THE COMBINATION OF CONCRETE BLOCK, GROUT AND MORTAR ON THE NET AREA OF THE CONSTRUCTION (fm) SHALL BE A MINIMUM OF 2,000 PSI.
- ALL CONCRETE BLOCK MASONRY UNITS SHALL BE NORMAL WEIGHT. ALL CONCRETE BLOCK MASONRY UNITS SHALL BE LAID IN RUNNING
- BOND, UNO. MASONRY BLOCK CELLS CONTAINING VERTICAL REINFORCING SHALL BE GROUTED SOLID. FILLING CELLS WITH MORTAR IS UNACCEPTABLE.
- ALL BOND BEAMS TO BE GROUTED SOLID. 6. THE BASE OF EACH CELL IN WHICH REINFORCING BAR IS PLACED MUST
- HAVE A CLEAN OUT HOLE. 7. VERTICAL REINFORCING BARS SHALL BE LAPPED PER SCHEDULE. MECHANICAL SPLICES MAY BE USED IN LIEU OF LAP SPLICES.
- PROVIDE CONTINUOUS REINFORCED BOND-BEAMS IN ALL REINFORCED MASONRY WALLS AT THE TOP, AND AS REQUIRED IN THE CONTRACT DRAWINGS. BOND-BEAMS AT THE TOP OF THE WALL SHALL BE CONTINUOUS AT MASONRY CONTROL JOINTS, ALL OTHER BOND-BEAMS SHALL NOT BE CONTINUOUS AT MASONRY CONTROL JOINTS. BOND-BEAM REINFORCING SHALL EXTEND INTO AND BE CONTINUOUS WITH ALL
- INTERSECTING BOND-BEAMS. 9. REINFORCED MASONRY WALLS SHALL HAVE #9 GAUGE (LADDER TYPE) HORIZONTAL REINFORCING AT SPACING AS NOTED ON CONTRACT
- DRAWINGS, BUT AT A MAXIMUM OF 16" O.C. VERTICALLY. 10. FILL CORES OF MASONRY UNDER ALL BEARING PLATES. THE MINIMUM WIDTH SHALL BE 3 TIMES THE BEARING PLATE LENGTH FOR THREE
- COURSES BELOW BEARING, UNO. 11. BRACE ALL MASONRY WALLS DURING CONSTRUCTION AS REQUIRED TO RESIST WIND AND OTHER TEMPORARY LOADS UNTIL FINAL STRUCTURAL MEMBERS ARE INSTALLED.
- 12. PROVIDE BAR POSITIONERS ON ALL REINFORCING TO HOLD AND MAINTAIN PROPER REBAR LOCATIONS AND COVER DURING GROUTING.

MASONRY VENEERS

CODES:

ACI 530/ASCE 5/TMS 402	BUILDING CODE REQUIREMENTS MASONRY STRUCTURES	FOR
MATERIALS:		
VENEER ANCHORS	ASTM A153 CLASS B2	
TYPE N/S MORTAR	ASTM C270	
GROUT (28 DAY STRENGT)	H) ASTM C476	2,000 PSI
REINFORCING BARS	ASTM A615 Gr 60	Fy=60 KSI

ACI 530.1/ASCE 6/TMS 602 SPECIFICATION FOR MASONRY STRUCTURES

- 1. SEE ACI 530.1/ASCE 6/TMS 602-05 TABLES C-4 AND C-5 FOR ASTM
- SPECIFICATION REQUIREMENTS. THE AIR SPACE BETWEEN THE VENEER AND THE BUILDING WALL IS TO BE NO LESS THAN 1" AND NO GREATER THAN 4 1/2".
- WICK AND TUBE WEEP SPACING SHALL NOT BE GREATER THAN 16" OC, OPEN HEAD JOINT WEEPS SHALL NOT BE SPACED GREATER THAN 24" OC.
- 4. VENEER ANCHORS SHALL BE A MINIMUM W1.7 ADJUSTABLE WIRE ANCHORS, HOT DIPPED GALVANIZED, TWO PIECE. THE HORIZONTAL SPACING SHALL BE 32" OC, MAX., THE VERTICAL SPACING SHALL BE 18" OC, MAX. THE MAXIMUM WALL AREA THAT ONE ANCHOR MAY TIE SHALL BE LESS THAN 2 SQFT.
- 5. VENEER ANCHORS SHALL BE SECURED TO STEEL STUDS THRU SHEETING WITH A MINIMUM OF (2)-#10 (.190" Ø) SELF-TAPPING SCREWS, TO WOOD STUDS THRU SHEETING WITH A MINIMUM OF (2)-8d (.131" Ø) GALVANIZED NAILS AND TO STRUCTURAL MASONRY WALL WITH A MINIMUM OF (2)-3/16" Ø MASONRY SCREWS. 6. VERTICAL EXPANSION JOINTS SHALL BE PLACED AT A MAXIMUM OF 25'-0"

OC, WITHIN 10'-0" OF CORNERS, AT OFFSETS, INTERSECTIONS, SETBACKS

AND CHANGES IN WALL HEIGHT. HORIZONTAL EXPANSION JOINTS SHALL BE PLACED IMMEDIATELY BELOW SHELF ANGLES.

STRUCTURAL WOOD CONSTRUCTION

CODES & STANDARDS:

GLUE-LAMINATED TIMBER

WOOD PANELS (COMPOSITE,

ORIENTED STRANDBOARD &

TONGUE & GROOVE DECKING

PLYWOOD)

FIRE-RETARDANT

TREATED LUMBER

AWC NDS	NATIONAL DESIGN SPECIFICATION FOR WOOD CONSTRUCTION		
AWC SDPWS	SPECIAL DESIGN PROVISIONS FOR WIND & SEISMIC		
APA A190.1	STRUCTURAL GLU	BER	
APA PDS	PANEL DESIGN SPECIFICATION		
AWC WFMC	WOOD FRAME CONSTRUCTION MANU FAMILY DWELLINGS		AL FOR ONE & TWO
MATERIALS:			SPECIES/GRADE
SAWN LUMBER WALL STUDS COLUMNS JOISTS & BEAMS		ASTM D1990-96A OR ASTM D245	SPF STUD SPF No.1/No.2 SPF No.1/No.2
I-JOISTS		ASTM D5055	
LSL WALL STUDS RIM BOARD			1.3E 1.3E Fcp = 710 PSI
LVL WALL STUDS HEADERS		ASTM D5055	2600 Fb, 2.0E
PSL BEAMS COLUMNS		ASTM D5055	2.0E 1.8E

AITC A190.1 &

ASTM E84 CLASS A

ASSOCIATION WOOD

AND PAPER

CONSTRUCTION

24F -1.8E

E=1.8 KSI

DOC PS 1 OR PS 2 APA RATED

AMERICAN FOREST | Fb=1000 PSI

ASTM D3737

DF BALANCED PRESERVATIVE TREATED WOOD AWPA STD U1 & M4 S. PINE No.2

1. ALL WOOD SHALL HAVE A MAXIMUM MOISTURE CONTENT OF 15% PRIOR TO INSTALLATION. MOISTURE CONTENT SHALL BE DETERMINED PER ASTM

2. ALL WOOD SHALL BE PROTECTED FROM MOISTURE BEFORE INSTALLATION. ALL WOOD STORED AT THE BUILDING SITE SHALL BE ELEVATED 6" ABOVE THE GROUND AND COVERED WITH PLASTIC TARPAULINS.

3. ALL STRUCTURAL WOOD SHALL MEET OR EXCEED ALLOWABLE UNIT STRESSES AND/OR GRADE AS REQUIRED BY THE DRAWINGS.

- JOISTS SHALL BE BRIDGED WITH 1" X 3" CROSS BRIDGING, OR SOLID BLOCKING, AT INTERVALS NOT EXCEEDING 8'-0" OC AND AT JOIST ENDS. ALL WOOD PERMANENTLY EXPOSED TO WEATHER OR IN CONTACT WITH THE GROUND, MASONRY OR CONCRETE SHALL HAVE A PRESERVATIVE
- TREATMENT EQUAL TO 0.4 PCF RETENTION OF PRESSURE INJECTED PRESERVATIVE. ALL JOISTS AND RAFTERS SHALL BE SUPPORTED BY DIRECT END BEARING ON WALLS, BEAMS OR JOIST HANGERS.
- WOOD MEMBERS SHALL NOT BE IN DIRECT CONTACT WITH CONCRETE OR MASONRY WITHOUT BEING MADE OF NATURALLY DURABLE OR PRESERVATIVE TREATED WOOD UNLESS 1/2" AIR SPACE IS PROVIDED AROUND (TOP, SIDES, END) OF WOOD RAFTERS/JOISTS/GIRDERS; IMPERVIOUS MOISTURE BARRIER OR 1" ELEVATED BASE IS PROVIDED AT WOOD COLUMNS; IMPERVIOUS MOISTURE BARRIER IS PROVIDED AT SILL
- WOOD ROOF & FLOOR STRUCTURAL PANELS SHALL BE LAID WITH THE LONG PANEL DIRECTION PERPENDICULAR TO THE SUPPORTING MEMBERS, WITH
- ENDS STAGGERED. 9. WOOD STRUCTURAL PANELS SHALL BEAR THE APPROPRIATE GRADING STAMP BY THE REVIEWING AGENCY.
- 10. ALL NAILS GIVEN ON THE PLANS SHALL BE CONSIDERED "COMMON NAILS" UNLESS NOTED ON THE PLANS. 11. ALL FASTENERS FOR WOOD CONSTRUCTION CONNECTORS (JOIST HANGERS,

ETC.) SHALL BE PROVIDED BY OR APPROVED BY THE CONNECTOR'S

- MANUFACTURER. 12. ALL FASTENERS AND WOOD CONSTRUCTION CONNECTORS IN CONTACT WITH FIRE RETARDANT TREATED WOOD OR PRESERVATIVE-TREATED WOOD SHALL BE IN ACCORDANCE WITH THE MANUFACTURER'S RECOMMENDATIONS. IN THE ABSENCE OF MANUFACTURER'S RECOMMENDATIONS FASTENERS AND WOOD CONSTRUCTION CONNECTORS SHALL BE STAINLESS STEEL OR HOT-
- DIPPED GALVANIZED STEEL. 13. ALL BOLTS AND LAG SCREWS SHALL CONFORM TO ASTM A307. PROVIDE WASHERS BETWEEN THE HEAD OR NUT AND THE WOOD SURFACE. 14. NO WOOD MEMBER SHALL BE CUT, NOTCHED, OR DRILLED WITHOUT THE SPECIFIC WRITTEN PERMISSION OF THE EOR.
- 15. THE GLUE-LAMINATED TIMBER FABRICATOR SHALL SUBMIT DRAWINGS AND CALCULATIONS, INCLUDING CONNECTIONS, TO THE ARCHITECT/ENGINEER FOR REVIEW PRIOR TO FABRICATION. THE CALCULATIONS MUST BE STAMPED BY A REGISTERED PROFESSIONAL ENGINEER LICENSED IN THE LOCAL JURISDICTION.

COLD-FORMED STRUCTURAL STEEL

MATERIALS:

CODES:	
AISC	SPECIFICATION FOR DESIGN, FABRICATION AND ERECTION OF STEEL FOR BUILDINGS
AISI	SPECIFICATION FOR THE DESIGN OF LIGHT-GAUGE COLD- FORMED STEEL STRUCTURAL MEMBERS
SSMA	STEEL STUD MANUFACTURERS ASSOCIATION PRODUCT TECHNICAL GUIDE
	LIGHT GAUGE STRUCTURAL INSTITUTE FRAMING
	SYSTEMS DESIGN HANDBOOK

CEE/ZEE GIRTS & PURLINS ASTM A570 Fy=55 KSI STUDS, JOISTS, TRACKS, ACC. ASTM A653/653M G60 | Fy=33/50 KSI WHERE SPECIFIC SIZES ARE NOT SHOWN ON DRAWINGS OR AS REQUIRED BY CONTRACT, THE COLD FORM SUPPLIER IS RESPONSIBLE FOR DESIGN AND SIZING OF MEMBERS. THE UNBRACED LENGTH OF BOTH THE TENSION

COLD-FORMED STEEL SECONDARY FRAMING MEMBERS CEE & ZEE SHAPED GIRTS AND PURLINS SHALL HAVE A 2 MIL. THICK RED OXIDE PRIMER ON ALL STEEL SURFACES, UNO.

AND COMPRESSION FLANGE SHALL BE CONSIDERED. CALCULATIONS ARE

3. DESIGN FOR ALL MEMBERS SHALL BE PER THE CODE AND LOADS NOTED UNDER THE DESIGN LOADS SECTION OF THESE NOTES. COLD-FORMED STEEL LIGHT-GAUGE STUDS, JOISTS, TRACKS AND ACCESSORIES SHALL HAVE A MINIMUM STRENGTH EQUAL TO OR GREATER

REQUIRED WITH THE SHOP DRAWINGS FOR APPROVAL

THAN THE MEMBERS TO BE CONNECTED, UNO. 5. SCREWS SHALL BE CORROSION RESISTANT, SELF DRILLING PAN OR HEX WASHER HEAD AS SHOWN ON THE DRAWINGS. 6. POWDER ACTUATED FASTENERS SHALL BE AIS! 1662 OR 1065 STEEL WITH A

MINIMUM CORE HARDNESS OF 50 TO 54 HRC, ZINC PLATED IN ACCORDANCE WITH ASTM B 633. THE DIAMETER AND LENGTH SHALL BE AS SHOWN ON THE DRAWINGS. F OF ILL 10/27/25 EXP 11/30/26





New Building

Forest Preserves of Winnebago County

Meridian Rd., Winnebago County, Illinois

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BA Project No. 2025-09

Scale

Sheet Title

engineering

N70 W5185 Columbia Road

Cedarburg, WI 53012 | 262.236.9372

C4E Project #: 25114

IL DESIGN FIRM 184-006824

12" = 1'-0"

STRUCTURAL GENERAL

NOTES Ref. North

Sheet No.

STRUCTURAL STEEL

CODES & STA	NDARDS:		
AISC 360	SPECIFICATION FOR S	STRUCTURAL STEEL B	UILDINGS
AISC	CODE OF STANDARD AND BRIDGES	PRACTICE FOR STEEL	BUILDINGS
AWS D1.1	STRUCTURAL WELDIN	IG CODE - STEEL	
AISC	STRUCTURAL STEEL L	DETAILING MANUAL	
MATERIALS:			
HOT ROLLED	W & WT SHAPES	ASTM A992	Fy=50 KSI
ANGLES, CHA	NNELS & PLATES	ASTM A36	Fy=36 KSI
S + M SHAPES	5	ASTM A36	Fy=36 KSI
HP SHAPES		ASTM A572 Gr 50	Fy=50 KSI
STEEL PIPE		ASTM A53 Gr B	Fy=35 KSI
RECTANGULA	R HSS	ASTM A500 Gr C	Fy=50 KSI
ROUND HSS		ASTM A500 Gr C	Fy=46 KSI
HIGH STRENG	TH BOLTS	ASTM A325	
HEAVY HEX N	UTS	ASTM A563	
HARDENED S	TEEL WASHERS	ASTM A436	

ASTM A108 HEADED STUD ANCHORS PROVIDE 2 MIL THICKNESS RED OR GRAY OXIDE PRIMER ON ALL STEEL

ASTM A36

ASTM F1554 Gr 36 Fy=36 KSI

Fy=36 KSI

- SURFACES (UNO). 2. ALL STEEL EXPOSED TO WEATHER SHALL BE HOT DIPPED GALVANIZED PER ASTM A123 AND FASTENERS HOT DIPPED GALVANIZED PER ASTM A153.
- 3. ANCHOR RODS SHALL BE PRESET WITH TEMPLATES.
- 4. COLUMN BASE PLATES SHALL BE GROUTED UNDER WITH NON-SHRINK, NON-METALLIC GROUT.

ANCHOR RODS THREADED RODS

- 5. CONNECTIONS MAY BE BOLTED OR WELDED AT THE FABRICATORS OPTION. BOLTED CONNECTIONS SHALL BE A MINIMUM BOLT DIAMETER OF 3/4" (UNO). HIGH STRENGTH BOLTS IN SINGLE OR DOUBLE SHEAR (UNO) AND SIMPLE SHEAR CONNECTIONS SHALL BE CAPABLE OF END ROTATION PER AISC REQUIREMENTS FOR UNRESTRAINED MEMBERS.
- 6. THE MINIMUM FILLET WELD SIZE SHALL NOT BE LESS THAN 3/16" (UNO). ALL WELDS SHALL USE WELD METAL CONFORMING TO E70XX AND
- CONFORMING TO AWS WELDING PROCEDURES AND STANDARDS.
- 8. ALL WELDS SHALL BE MADE BY AWS CERTIFIED WELDERS CERTIFIED IN THE POSITION IN WHICH THE WELD IS TO BE MADE. 9. THE ERECTION OF ANY STRUCTURAL STEEL MEMBERS SHALL NOT
- COMMENCE UNTIL ALL SUPPORTING CONCRETE/MASONRY ELEMENTS HAVE ATTAINED AT LEAST 75% OF THEIR INTENDED MINIMUM COMPRESSIVE STRENGTH. 10. THE CONTRACTOR SHALL PROVIDE TEMPORARY ERECTION BRACING AND
- SUPPORTS AS REQUIRED FOR THE SAFE ERECTION OF ALL STEEL. TEMPORARY BRACING SHALL REMAIN IN PLACE UNTIL PERMANENT BRACING HAS BEEN INSTALLED AND FLOOR SLAB CONCRETE HAS ATTAINED 75% OF ITS REQUIRED STRENGTH.
- 11. STRUCTURAL STEEL SHALL BE TRUE AND PLUMB BEFORE FINAL BOLTING OR WELDING OF CONNECTIONS.
- 12. THE CONTRACTOR SHALL NOT MODIFY OR CUT ANY STRUCTURAL STEEL WITHOUT WRITTEN APPROVAL FROM THE EOR.
- 13. THE CONTRACTOR SHALL FIELD TOUCH UP ALL ABRASIONS, BURNS, AND
- SIMILAR DEFECTS IN PAINT OF STRUCTURAL STEEL. 14. PROVIDE 1/4" CLOSURE/END PLATES FOR ALL OPEN ENDS OF HSS & PIPE MEMBERS.
- 15. CONTRACTOR SHALL INCLUDE IN PROPOSAL COST TO FURNISH, DELIVER, FABRICATE AND ERECT 1.0 TONS OF STRUCTURAL STEEL IN ADDITION TO THAT SPECIFIED IN THE CONSTRUCTION DOCUMENTS. ANY UNUSED MATERIAL SHALL BE CREDITED TO THE OWNER AT THE END OF THE

STEEL DECK AND SHEAR CONNECTORS

NONCOMPOSITE DECK - PAINTED

COMPOSITE DECK - GALVANIZED

CODES:

GALVANIZING

AISC	SPECIFICATION FOR DESIGN, FABRICATION AND ERECTION OF STEEL FOR BUILDINGS				
AISI	SPECIFICATION FOR THE DESIGN OF LIGHT GAUGE COLD FORM STEEL STRUCTURAL MEMBERS				
AWS D1.3	STRUCTURAL WELDING CODE - SHEET METAL				
SDI	OI CODE OF PRACTICE				
MATERIALS:					
ROOF DECK	- PAINTED	ASTM A611 Gr C	Fy=33 KSI		
ROOF DECK	- GALVANIZED	ASTM A446 Gr A	Fy=33 KSI		

ASTM A446 Gr E

ASTM A446 Gr 1

ASTM A525 CLASS G60 MIN

Fy=50 KSI

Fy=50 KSI

- PRIMER PAINT SHALL BE SHOP APPLIED OVER CLEAN AND PHOSPHATIZED
- 2. STEEL DECK SHALL EXTEND OVER THREE OR MORE SPANS WHENEVER
- POSSIBLE. MINIMUM BEARING AT ENDS SHALL BE 1 1/2".
- 3. STEEL DECK SHALL BE FASTENED AS SHOWN ON THE PLANS. 4. IF STEEL DECK IS TO BE FASTENED WITH THE USE OF WELDS, USE 16 GA. WELD WASHERS AT ALL THICKNESS LESS THAN 22 GA, WELDS SHALL NOT BE USED AT SIDE LAP FASTENERS AND DECK SHALL BE WELDED TO SUPPORTS
- WITH HOBART 1139 WIRE (IRON POWER RODS) OR AN APPROVED EQUAL. 5. SHEAR CONNECTORS, NUMBER INDICATED ON THE FRAMING PLANS AT EACH BEAM BY (X) SHALL BE EQUALLY SPACED OVER THE LENGTH OF THE BEAM STARTING AS NEAR AS POSSIBLE TO THE BEAM SUPPORTS. WHERE STEEL DECK CORRUGATIONS DO NOT ALLOW FOR AN EVEN SPACING, THE SPACING SHALL BE VARIED SO THAT THE HIGHEST DENSITY OF CONNECTORS OCCURS NEAREST THE SUPPORT.

STEEL STAIRS, LADDERS, HANDRAILS AND GUARDS

ENGINEERED STEEL STAIR SYSTEM: STRINGERS, HEADERS, LANDINGS, RAILINGS. GUARD RAILS AND CONNECTIONS TO THIS STRUCTURE SHALL BE DESIGNED BY A REGISTERED PROFESSIONAL ENGINEER LICENSED IN THE LOCATION OF THIS BUILDING. PROVIDE SIGNED & SEALED STRUCTURAL CALCULATIONS WITH SHOP DRAWING SUBMITTAL.


2. THE CONFIGURATION OF THE STEEL STAIR SYSTEM SHALL BE AS SHOWN ON

- THE ARCHITECTURAL DRAWINGS. 3. THE LOADS REQUIRED FOR THE DESIGN OF THE STEEL STAIR SYSTEM SHALL
- BE AS INDICATED ON THE "DESIGN LOADS" SECTION OF THESE NOTES.
- 4. THE SHOP DRAWINGS SHALL INDICATE LOADS IMPOSED ON THE BUILDING STRUCTURE BY THE STAIR STRUCTURE.

POST- INSTALLED ANCHORS

- 1. THE DIAMETER, EMBEDMENT LENGTH AND TYPE OF ADHESIVE ANCHORS AND
- SCREW ANCHORS SHALL BE AS SPECIFIED ON THE DRAWINGS. 2. THE SUBSTITUTION OF OTHER MANUFACTURER'S SIMILAR PRODUCTS IS ALLOWED, PROVIDED THAT THE SIZE IS EQUAL TO, AND CAPACITY IN SHEAR AND UPLIFT ARE EQUAL TO OR GREATER THAN WHAT IS SPECIFIED ON THE DRAWINGS. THE COST OF REDESIGN OF SUCH SUBSTITUTIONS SHALL BE BORE
- BY THE CONTRACTOR. 3. INSTALLATION OF ANCHORS SHALL STRICTLY FOLLOW ALL MANUFACTURER'S WRITTEN INSTRUCTIONS AND SPECIFICATIONS. ALL DRILL HOLE PREPARATIONS
- 4. NO LOAD SHALL BE APPLIED TO ADHESIVE ANCHORS PRIOR TO THE FULL CURE TIME AS SPECIFIED BY THE MANUFACTURER.
- TESTING OF 10% OF ALL INSTALLED ANCHORS IS REQUIRED. TESTED ANCHORS SHALL MEET THE MANUFACTURERS PROOF LOAD REQUIREMENTS AND/OR INSTALLATION TORQUE REQUIREMENTS. MALFUNCTIONING FASTENERS SHALL BE REPLACED.
- 6. ALL ADHESIVE ANCHOR INSTALLATIONS IN THE HORIZONTAL TO VERTICALLY OVERHEAD ORIENTATION SHALL BE CONDUCTED BY A CERTIFIED ADHESIVE ANCHOR INSTALLER AS CERTIFIED BY ACI PER 318-11 9.2.2 OR AC1 318-14 17.8.2.2 OR ACI 318-19 17.2.3. OR APPROVED EQUIVALENT. CURRENT AAI CERTIFICATE MUST BE SUBMITTED TO THE ENGINEER OF RECORD FOR APPROVAL PRIOR TO COMMENCEMENT OF ANY ADHESIVE ANCHOR INSTALLATIONS.
- ADHESIVE ANCHORS IN CRACKED AND UNCRACKED CONCRETE SHALL BE DEWALT PURE 220+ (ICC-ES ESR 5144) OR SIMPSON SET 3G OR HILTI RE 500 V3.
- 8. SCREW ANCHORS IN CRACKED AND UNCRACKED CONCRETE SHALL BE DEWALT SCREW-BOLT+ (ICC-ES ESR 4042) OR SIMPSON TITEN HD OR HILTI KWIK KH-EZ / KWIK.

				FOOTING SCHEDULE	
		DIMENSIONS			
MARK	WIDTH	LENGTH	THICKNESS	REINFORCING	REMARKS
F3	3'-0"	3'-0"	1'-0"	(3) #5 EW	
F5	5'-0"	5'-0"	1'-2"	(6) #5 EW	
F6	6'-0"	6'-0"	1'-4"	(8) #5 EW	
F7	7'-0"	7'-0"	1'-6"	(7) #6 EW	
F8	8'-0"	8'-0"	1'-8"	(7) #7 EW	

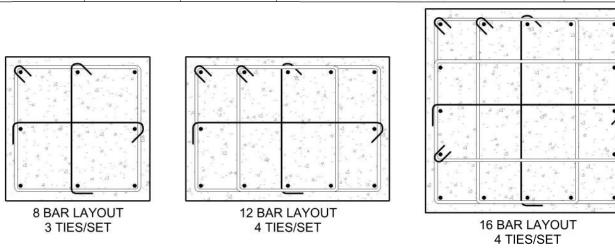

				PIER SCHEDUL	E	
MADIZ		DIMENSIONS		REINF	ORCING	DEMARKS
MARK	DIAMETER	WIDTH	LENGTH	VERTICAL	TIES	REMARKS
P16		1'-4"	1'-4"	(8)-#6	#3 @1'-0" OC	
P32		2'-8"	2'-8"	(12)-#6	#3 @1'-0" OC	
P1624		1'-4"	2'-0"	(8)-#6	#3 @1'-0" OC	

	LINTEL S	CHEDULE		
MARK	LINTEL	JAMB REINF	LINTEL TYPE	REMARKS
L1	8" BOND BEAM W/ (2)-#5 CONT	(1) #5	Α	
L2	16" BOND BEAM W/ (2)-#5 CONT	(1) #5	Α	

			CONCRETE SLAB ON GRADE SCHI	EDULE	
			CONCRETE SLAB	COMPACTED	
MARK	TYPE	THICKNESS	SLAB REINFORCING	GRAVEL THICKNESS	REMARKS
SOG 4	NWC	4"	FORTA FERRO FIBER REINFORCING (3 LB/CY)	6"	SEE TYPICAL SLAB JOINT DETAIL
SOG 8	NWC	8"	#4 @ 12" OC EACH WAY TOP & BOTTOM	8"	

PRECAST CONCRETE PLANK SCHEDULE							
	SYSTEM	PLANK	INSULATION		TOPPI	NG	
MARK	DEPTH	DEPTH	THICKNESS	THICKNESS	TYPE	REINFORCING	REMARKS
PC8+2	10"	8"	0"	2"	NWC - STRUCTURAL	FORTA FERRO FIBER REINF (3LB/CY)	

WOOD DECK/SHEATHING SCHEDULE

	SYSTEM	STRUCTURAL LAYER		TOPPING/OVERLAY	MENT	
MARK	DEPTH	TYPE	THICKNESS	TYPE	THICKNESS	REMARKS
WD062	5/8"	PLYWOOD/OSB WOOD SHEATHING	5/8"	-		PROVIDE SIMPSON PSC CLIPS AT PANEL EDGES
WD150	1 1/2"	2X6 TONGUE & GROOVE WOOD	1 1/2"		0"	



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New Building

for

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Meridian Rd., Winnebago County, Illinois

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Scale

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DESCRIPTION

Sheet Title


EXP 11/30/26

STRUCTURAL GENERAL **NOTES & SCHEDULES**

Ref. North

Sheet No.

engineering PROFESSIONAL DESIGN FIRM REGISTRATION # N70 W5185 Columbia Road 184-003342 Cedarburg, WI 53012 | 262.236.9372 C4E Project #: 25114 IL DESIGN FIRM 184-006824

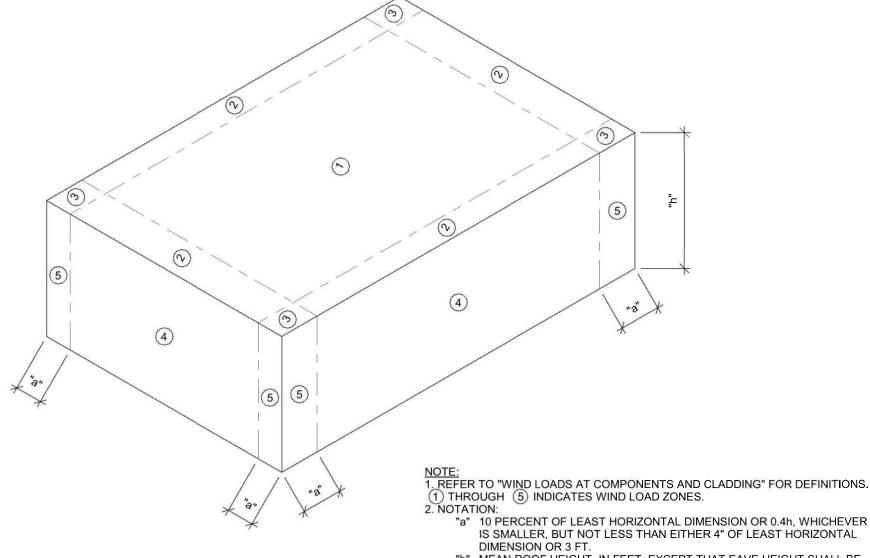

NOTE:
1. REFER TO "WIND LOADS AT COMPONENTS AND CLADDING" FOR DEFINITIONS.
1) THROUGH (5) INDICATES WIND LOAD ZONES.
2. NOTATION:
"a" 10 PERCENT OF LEAST HORIZONTAL DIMENSION OR 0.4h, WHICHEVER
IS SMALLER, BUT NOT LESS THAN EITHER 4" OF LEAST HORIZONTAL
DIMENSION OR 3 FT.
"h" MEAN ROOF HEIGHT, IN FEET, EXCEPT THAT EAVE HEIGHT SHALL BE
LISED FOR Ø < 10°

"Ø" ANGLE OF PLANE OF ROOF FROM HORIZONTAL, IN DEGREES.

NEGATIVE ZONE 3	-56.8	-44.6	-36.2
POSITIVE ALL ZONES	16.0	16.0	16.0
OVERHANG ZONE 1&1'	-38.9	-36.6	-22.9
OVERHANG ZONE 2	-52.6	-36.5	-25.2
OVERHANG ZONE 3	-73.3	-45.0	-25.2
ULTIMATE PARAP	ET SURFACE P	RESSURE (PSF	=)
AREA (SF)	10.0	50.0	100.0
CASE A: INTERIOR ZONE	-	-	-
CASE A: CORNER ZONE	-	-	-
CASE B: INTERIOR ZONE	-	-	-
CASE B: CORNER ZONE	-	-	-
ULTIMATE WALL	SURFACE PR	ESSURE (PSF)	
AREA (SF)	20.0	100.0	200.0
NEGATIVE ZONE 4	-25.7	-23.1	-22.0
NEGATIVE ZONE 5	-30.8	-25.7	-23.5
POSITIVE ZONE 4 & 5	23.6	21.1	20.0

ULTIMATE ROOF SURFACE PRESSURE (PSF)

-43.3

-24.7

AREA (SF)

NEGATIVE ZONE 1

NEGATIVE ZONE 2

500.0


-27.0


-16.0

100.0

-33.6

-24.7

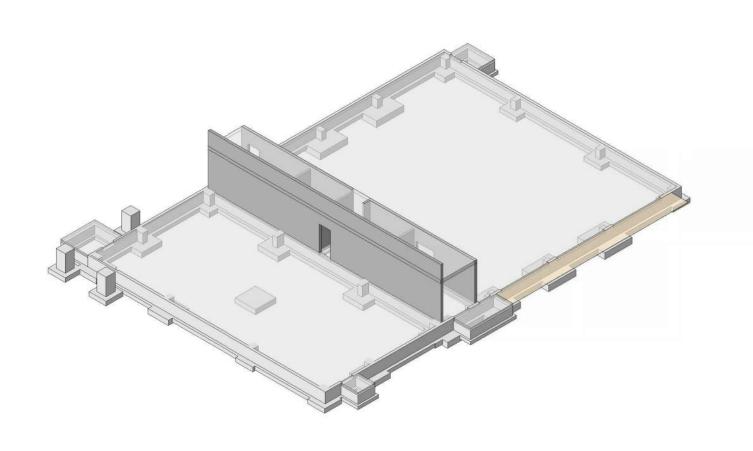

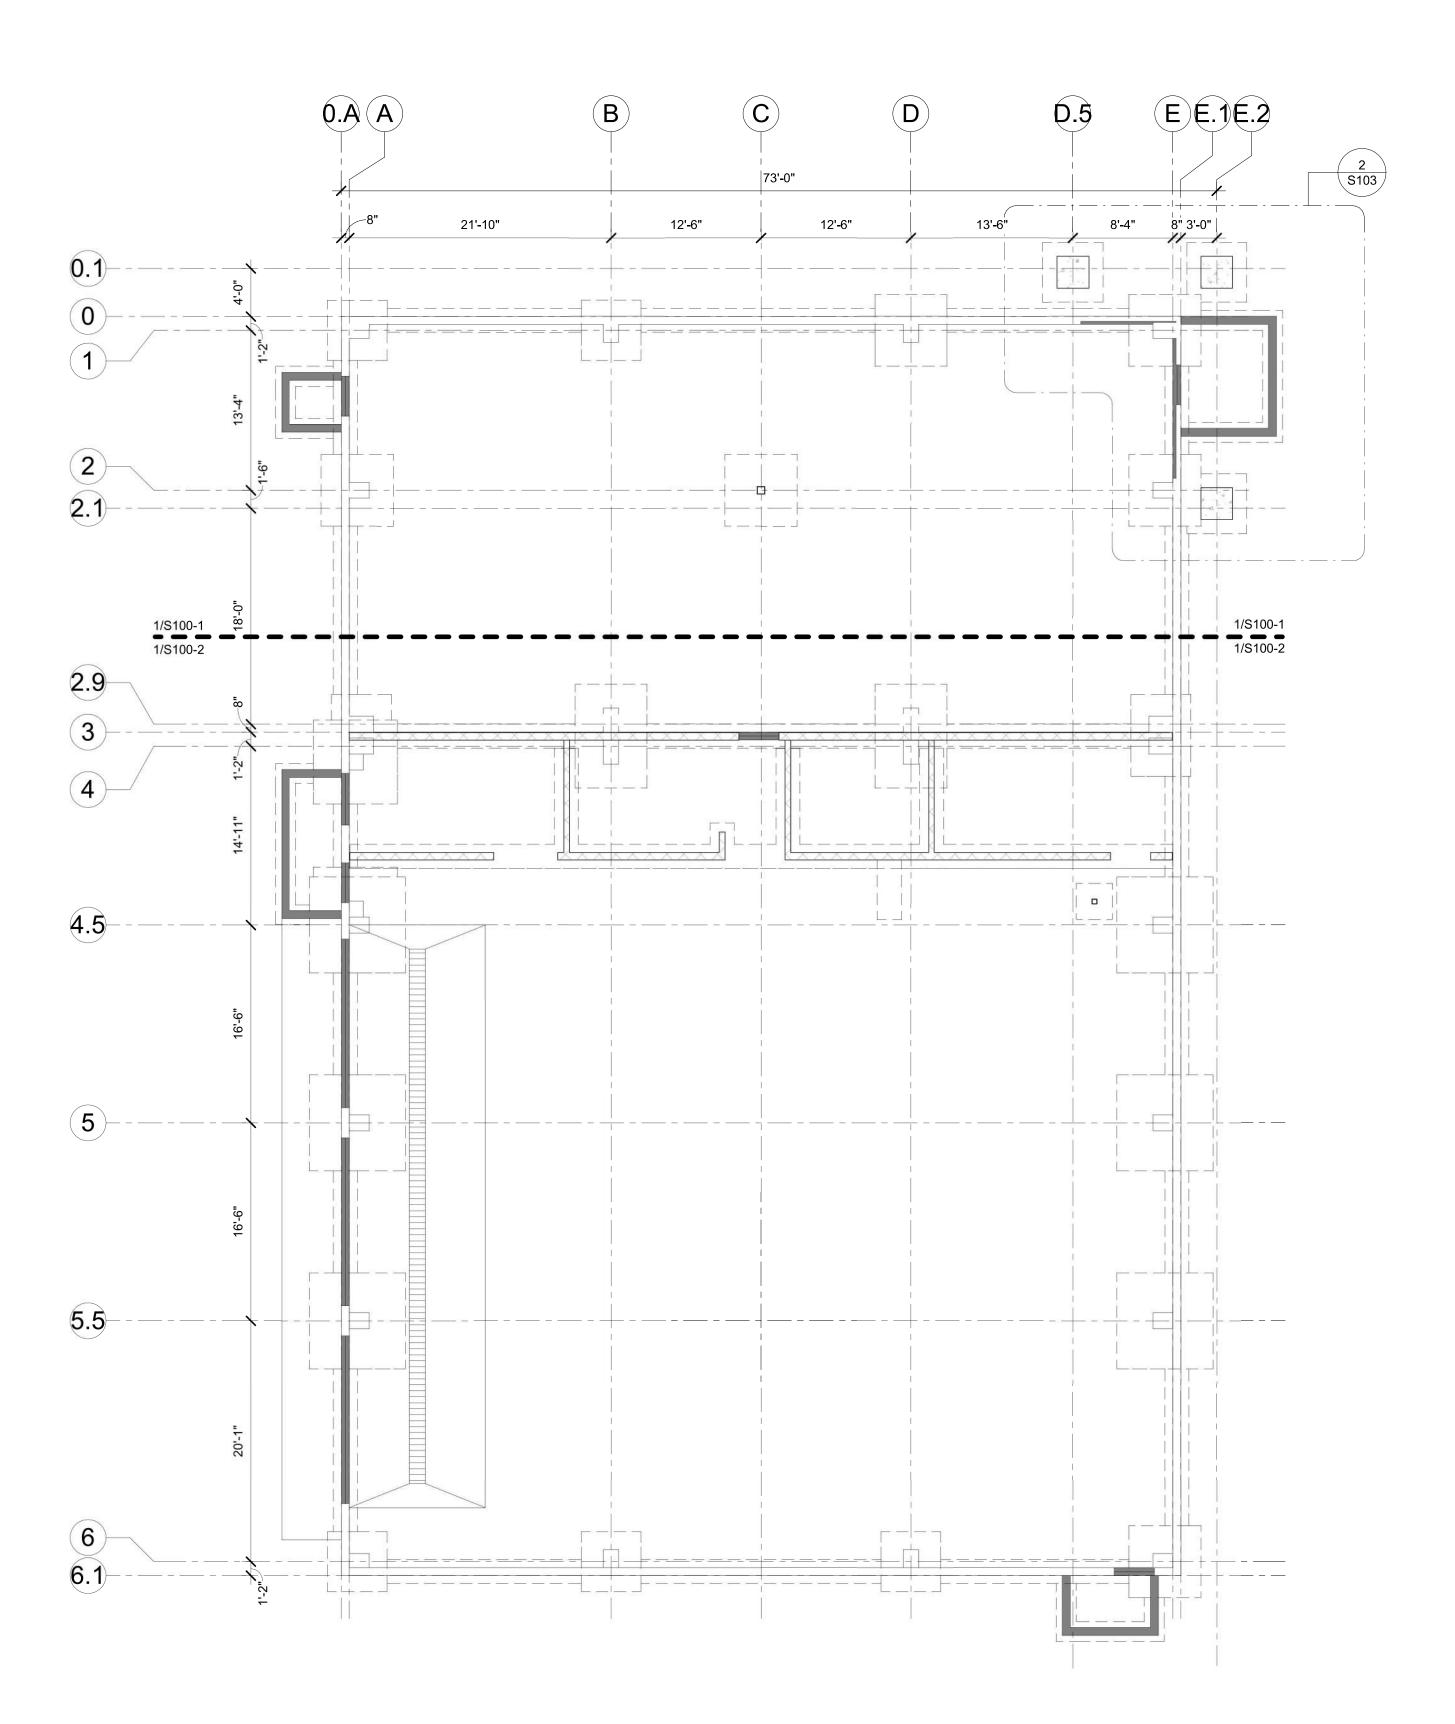

FOUNDATION PLAN - OVERALL
S100 SCALE: 1/8" = 1'-0"

- FOUNDATION PLAN NOTES:
 SEE SHEET S001 FOR STRUCTURAL GENERAL NOTES AND S002 FOR STRUCTURAL SCHEDULES.
 SEE SHEET S300 FOR FOUNDATION WALL CONSTRUCTION JOINTS AND TYPICAL REINFORCING DETAILS.
 TOP OF EXTERIOR FOOTING ELEVATION = -3'-0" UNO.
 TOP OF INTERIOR FOOTING ELEVATION = -1'-0" UNO.

- 5. TOP OF PIER ELEVATION = 0'-0" UNO.
- 6. TOP OF FOUNDATION WALL ELEVATION = 0'-0" UNO.
 7. SEE MECHANICAL DRAWINGS FOR HOUSEKEEPING PADS REQUIRED FOR MECHANICAL EQUIPMENT.
- 8. SEE ARCHITECTURAL DRAWINGS FOR DOOR OPENING SIZES AND LOCATIONS IN WALLS. COORDINATE WITH ARCHITECTURAL DRAWINGS AND FRAMING PLANS FOR HOLDDOWN REINFORCING LOCATIONS IN FOUNDATION
- 10. GENERAL CONTRACTOR TO PROVIDE ALL SHORING REQUIRED FOR EXISTING BUILDING AND/OR NEW BUILDING. SEE GENERAL REQUIREMENTS NOTE 1 AND EXISTING CONSTRUCTION NOTE 3 FOR ADDITIONAL INFORMATION.



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Meridian Rd., Winnebago County, Illinois

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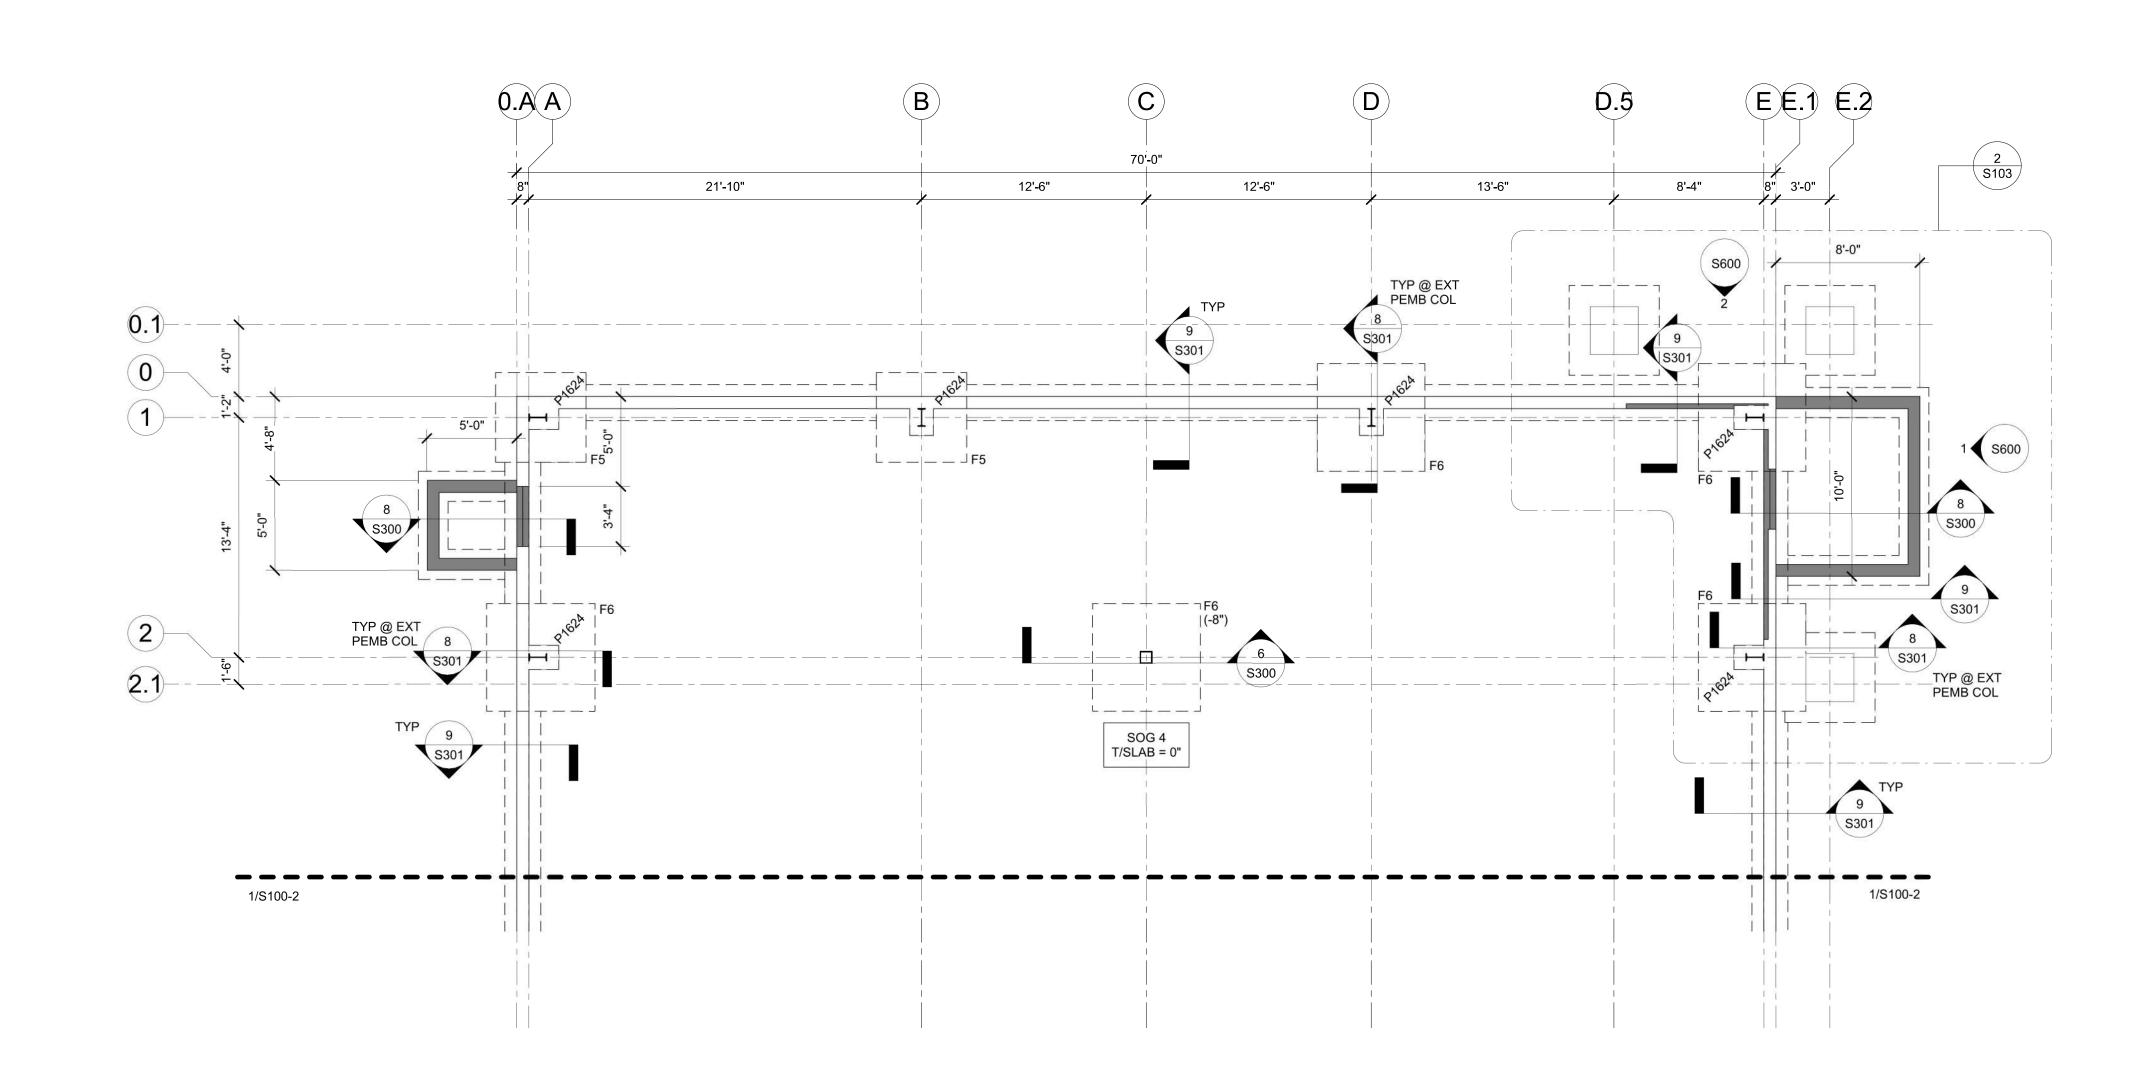
Sheet Title

OVERALL FOUNDATION PLAN

Ref. North

Sheet No. **S100**







FOUNDATION PLAN NOTES:

1. SEE SHEET S001 FOR STRUCTURAL GENERAL NOTES AND S002 FOR

2. SEE SHEET S300 FOR FOUNDATION WALL CONSTRUCTION JOINTS

7. SEE MECHANICAL DRAWINGS FOR HOUSEKEEPING PADS REQUIRED

SEE ARCHITECTURAL DRAWINGS FOR DOOR OPENING SIZES AND

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REQUIREMENTS NOTE 1 AND EXISTING CONSTRUCTION NOTE 3 FOR

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AND TYPICAL REINFORCING DETAILS.

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5. TOP OF PIER ELEVATION = 0'-0" UNO.

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STRUCTURAL SCHEDULES.

FOR MECHANICAL EQUIPMENT.

ADDITIONAL INFORMATION.

LOCATIONS IN WALLS.

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engineering

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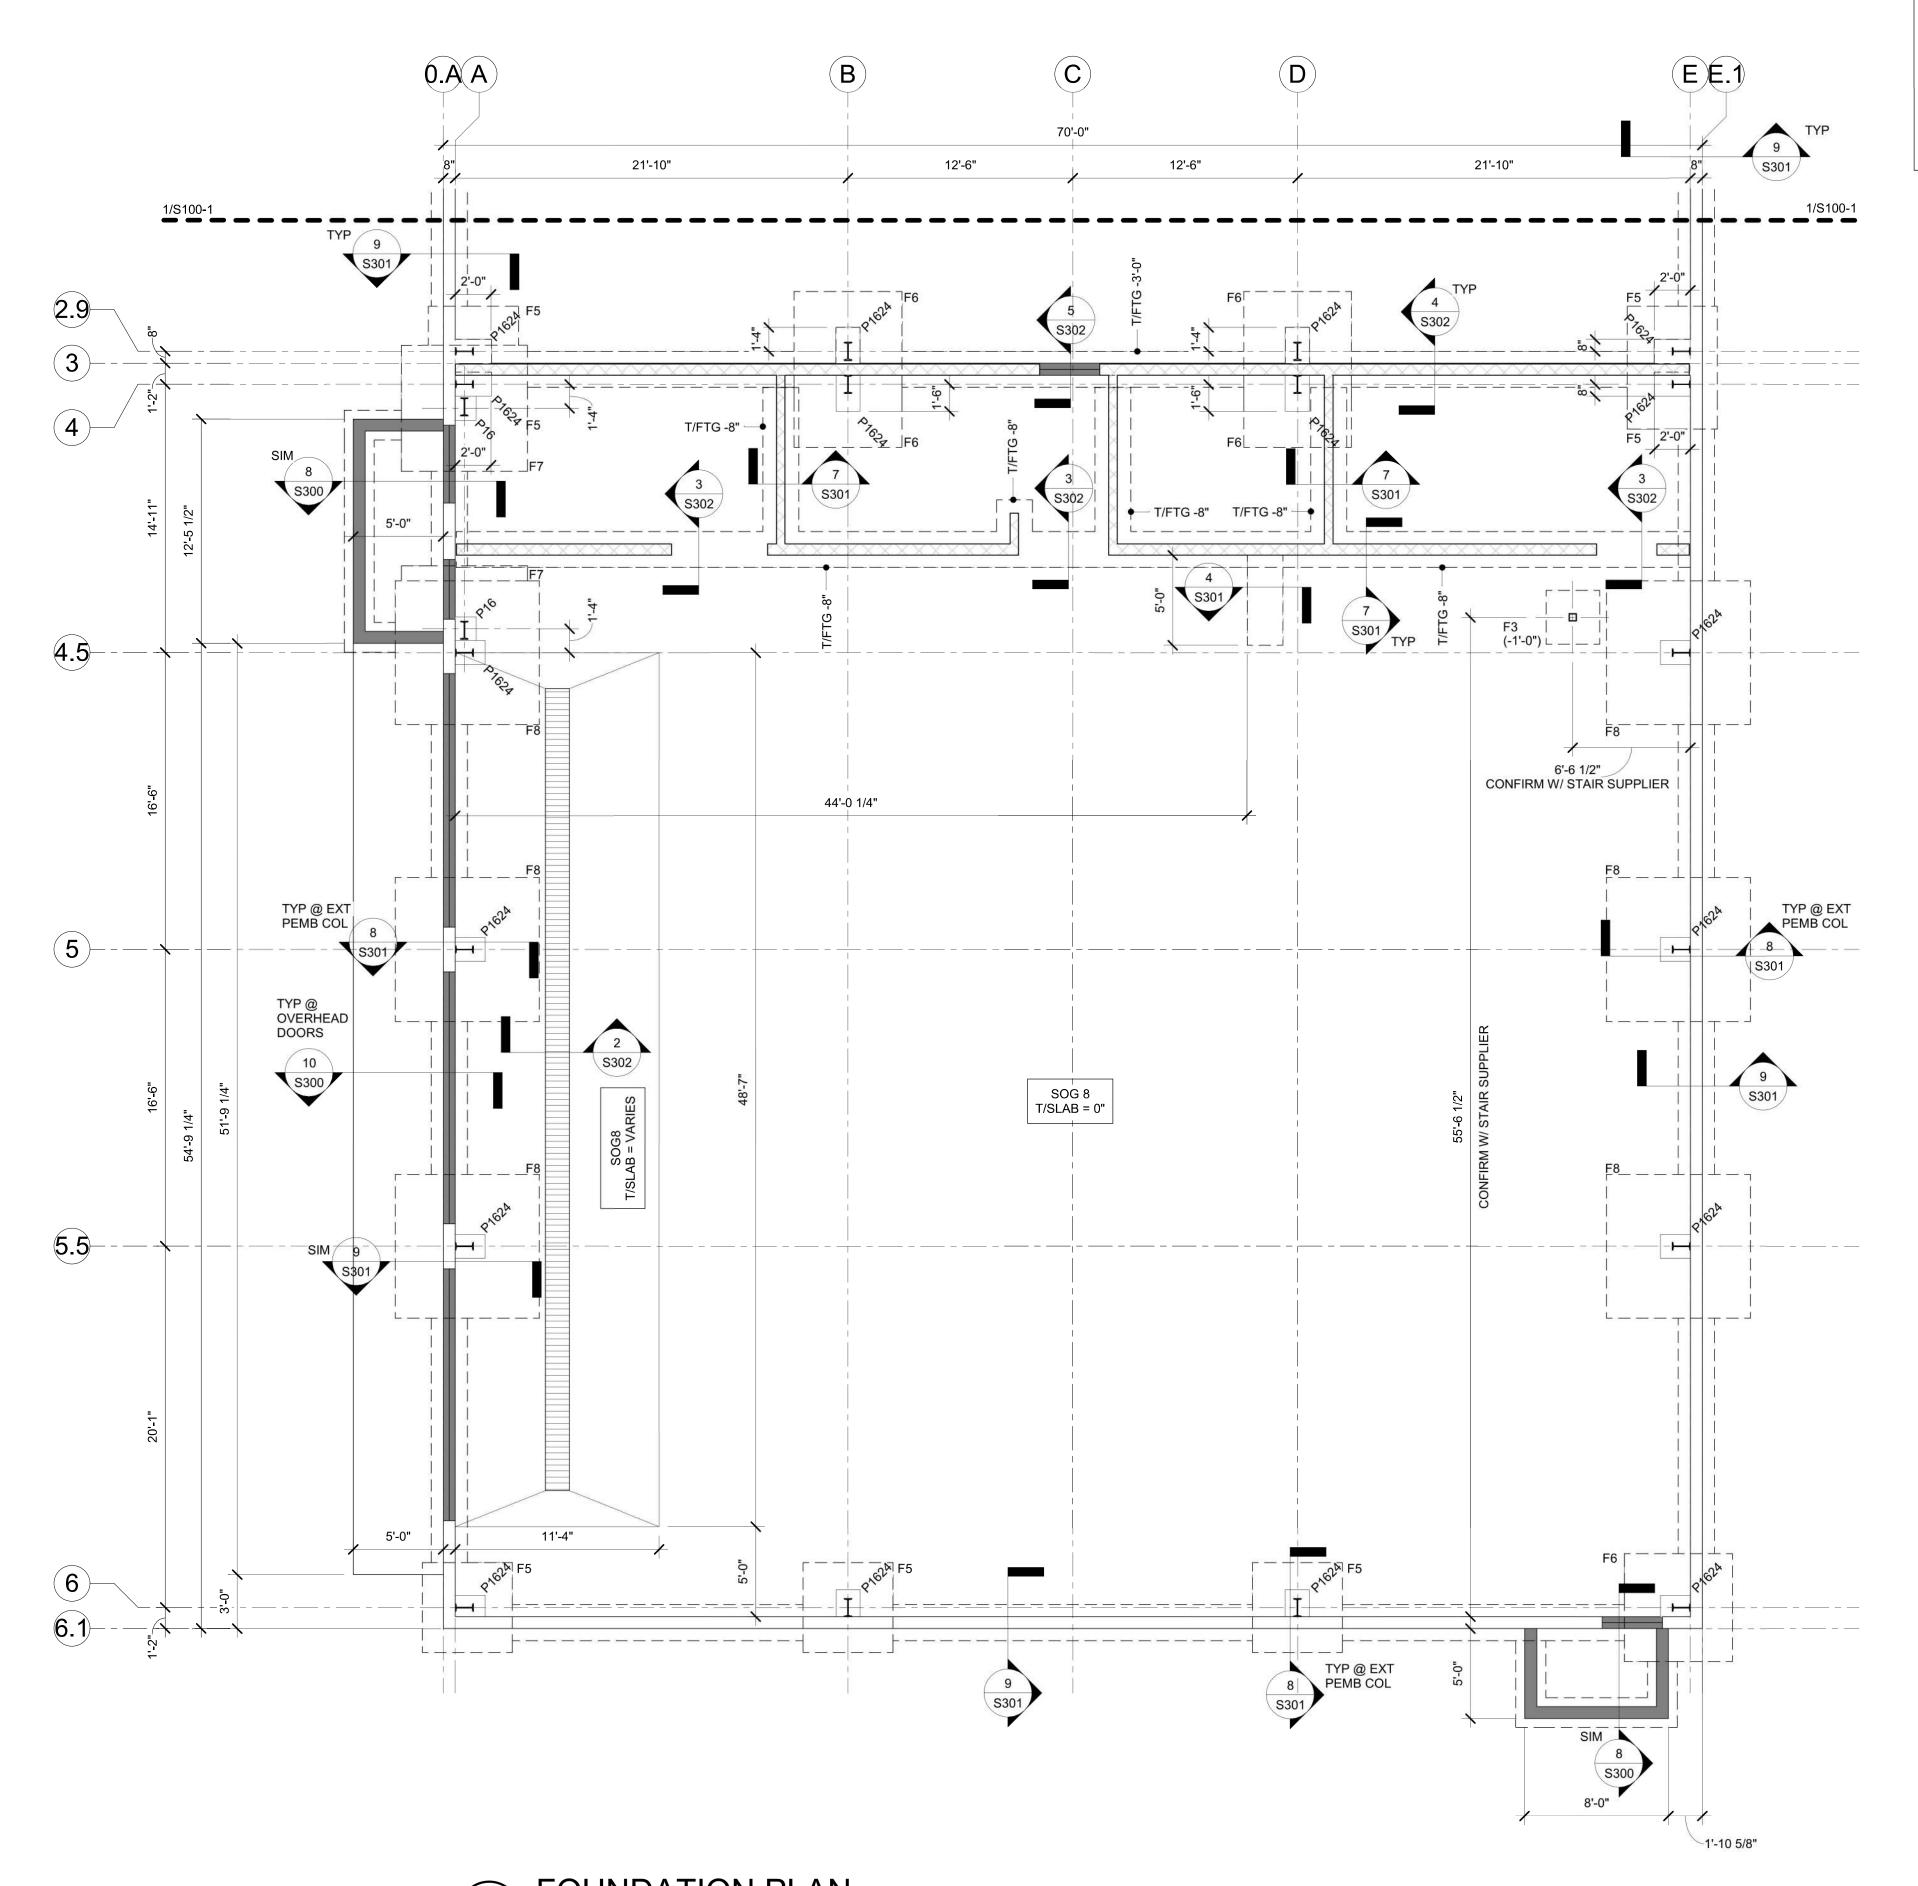
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FOUNDATION PLAN

Sheet No.

S100-1





- FOUNDATION PLAN NOTES:

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- AND TYPICAL REINFORCING DETAILS.

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 7. SEE MECHANICAL EQUIPMENT.
- FOR MECHANICAL EQUIPMENT.

 8. SEE ARCHITECTURAL DRAWINGS FOR DOOR OPENING SIZES AND
- LOCATIONS IN WALLS.

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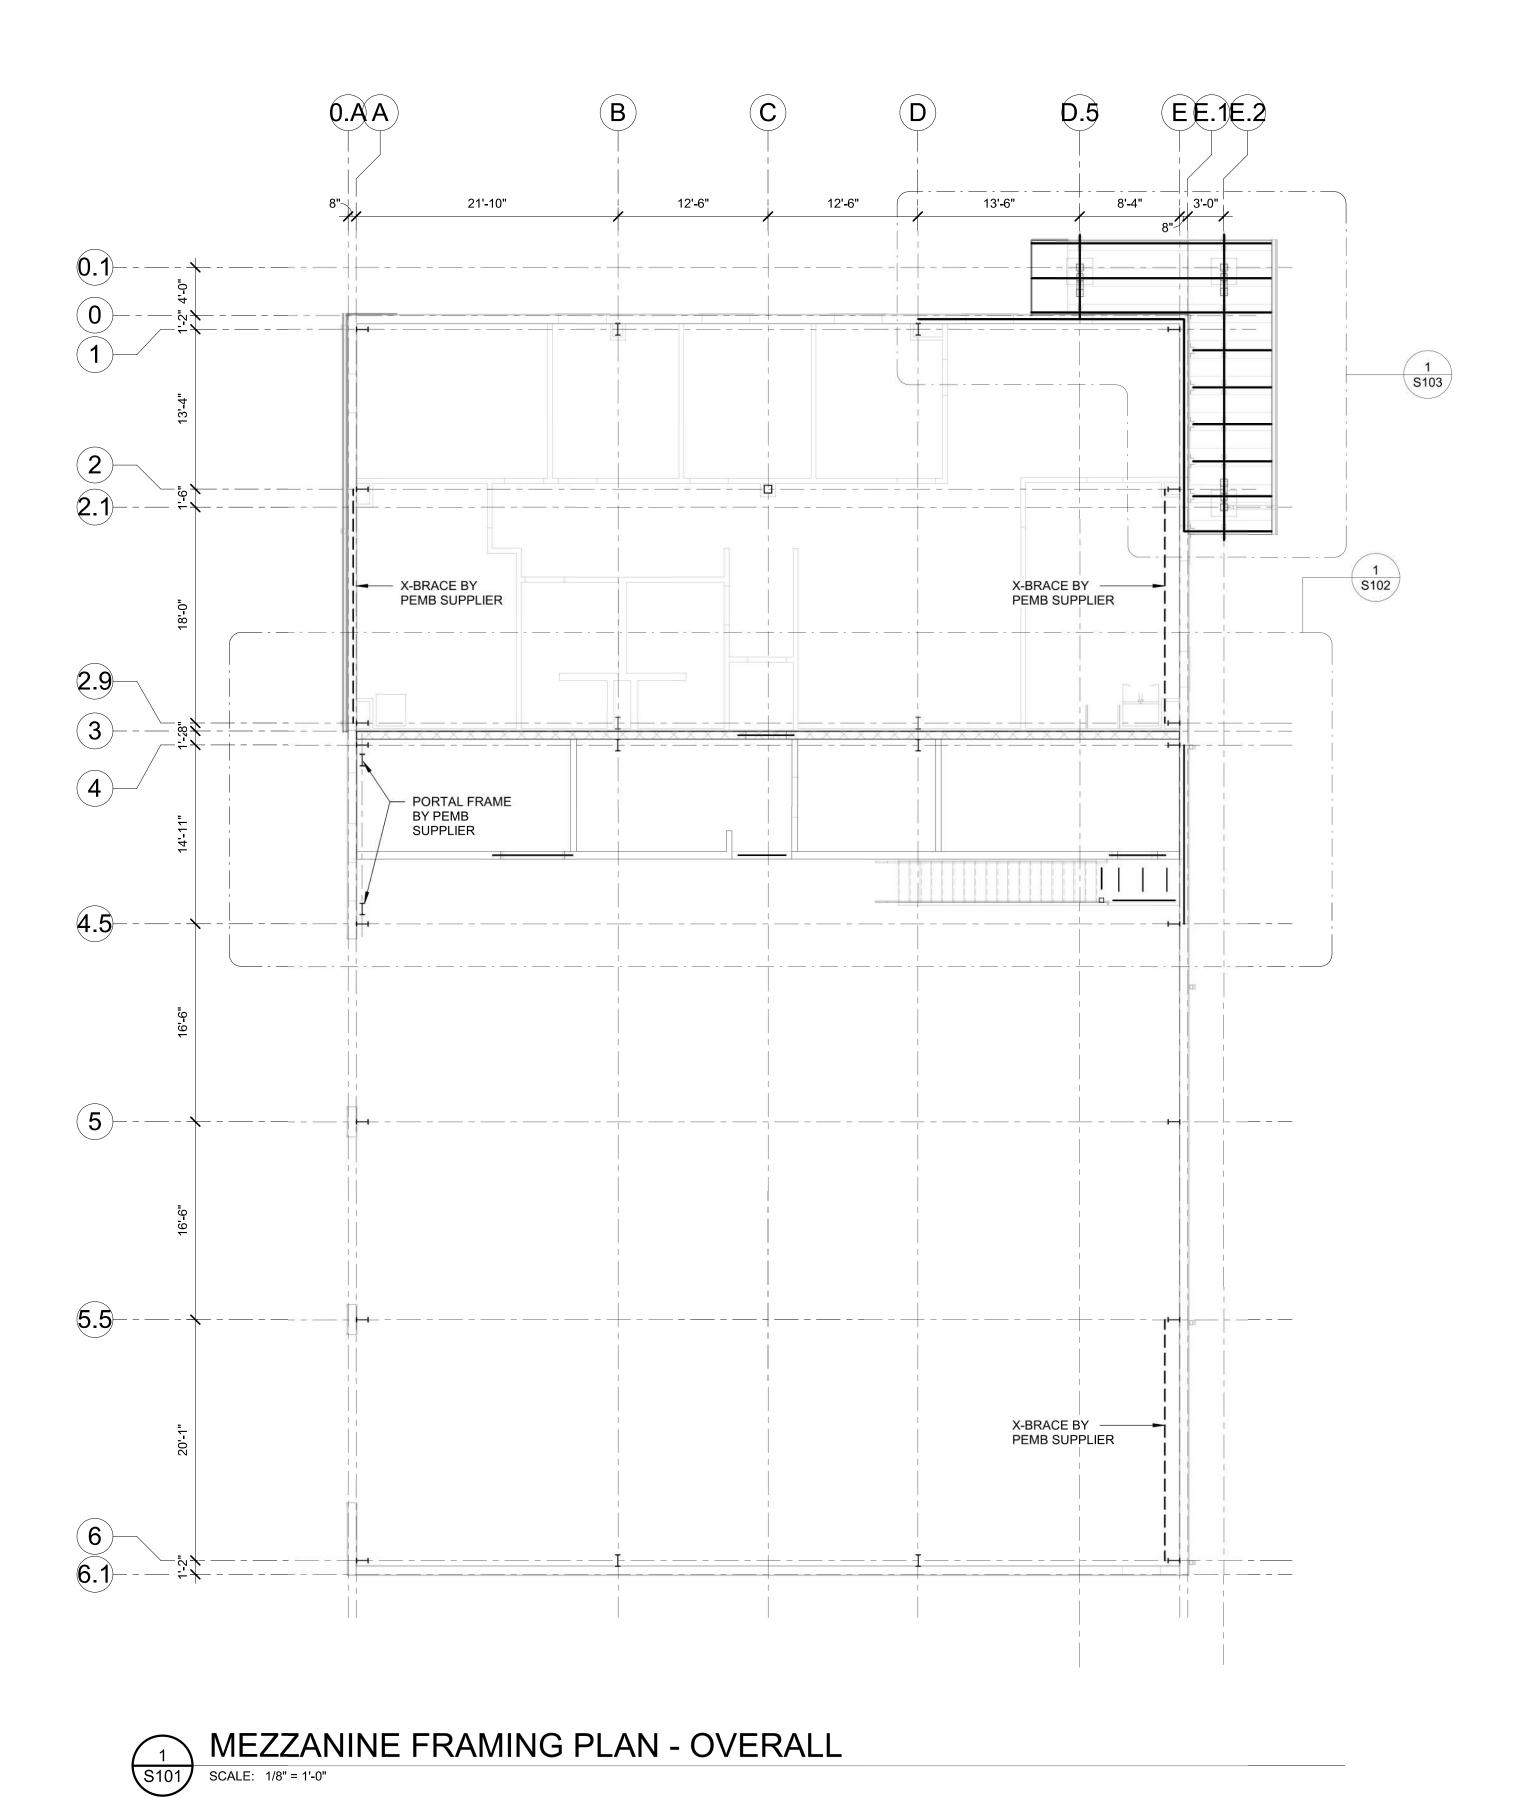
Sheet Title

FOUNDATION PLAN

Sheet No. S100-2

PROFESSIONAL DESIGN FIRM REGISTRATION # 184-003342

N70 W5185 Columbia Road Cedarburg, WI 53012 | 262.236.9372 **C4E** Project #: 25114 IL DESIGN FIRM 184-006824



FLOOR FRAMING PLAN NOTES:

1. SEE SHEET S001 FOR STRUCTURAL GENERAL NOTES AND S002 FOR STRUCTURAL SCHEDULES.

2. SEE SHEET S400 FOR TYPICAL MASONRY SECTIONS AND DETAILS,

INCLUDING TYPICAL WALL REINFORCING.

SEE SHEET S500 FOR TYPICAL STEEL SECTIONS AND DETAILS.

SEE ARCHITECTURAL DRAWINGS FOR DOOR OPENING SIZES, ELEVATIONS AND LOCATIONS IN MASONRY WALLS NOT SHOWN ON

GC TO COORDINATE SIZE & LOCATIONS OF ALL FLOOR PENETRATIONS & WALL OPENINGS WITH MECHANICAL, PLUMBING & ELECTRICAL CONTRACTORS.

6. ALL PRECAST PLANK JOINTS SHALL BE GROUTED. GENERAL CONTRACTOR TO PROVIDE ALL SHORING REQUIRED FOR EXISTING BUILDING AND/OR NEW BUILDING. SEE GENERAL REQUIREMENTS NOTE 1 AND EXISTING CONSTRUCTION NOTE 3 FOR ADDITIONAL INFORMATION.



400 N. First Street Rockford, IL 61107 T: 815-227-0023 E: brian@blakemore-architects.com Web: blakemore-architects.com



New Building

for

Forest Preserves of Winnebago County

Meridian Rd., Winnebago County, Illinois

THE CONTRACTOR SHALL DETERMINE EXACT DIMENSIONS AND CONDITIONS AT THE SITE PRIOR TO SUBMITTING A BID. THE CONTRACTOR SHALL COORDINATE ALL DRAWINGS WITH ACTUAL FIELD WORK AND NOTIFY THE ARCHITECT OF ANY DISCREPANCIES. THIS DRAWING IS THE PROPERTY OF BLAKEMORE ARCHITECTS AND MAY NOT BE REPRODUCED WITHOUT THE PRIOR WRITTEN PERMISSION OF THE ARCHITECT.

DESCRIPTION	DATE	NO.
Initial Layout	05-08-2025	1)
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Design Development	08-27-2025	3)
Final Owner Review Set	10-17-2025	4)
Issued for Bids / Permit	10-27-2025	5)

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BA Project No.

Scale

As indicated

2025-09

Sheet No.


S101

Sheet Title

OVERALL MEZZANINE FRAMING PLAN

Ref. North



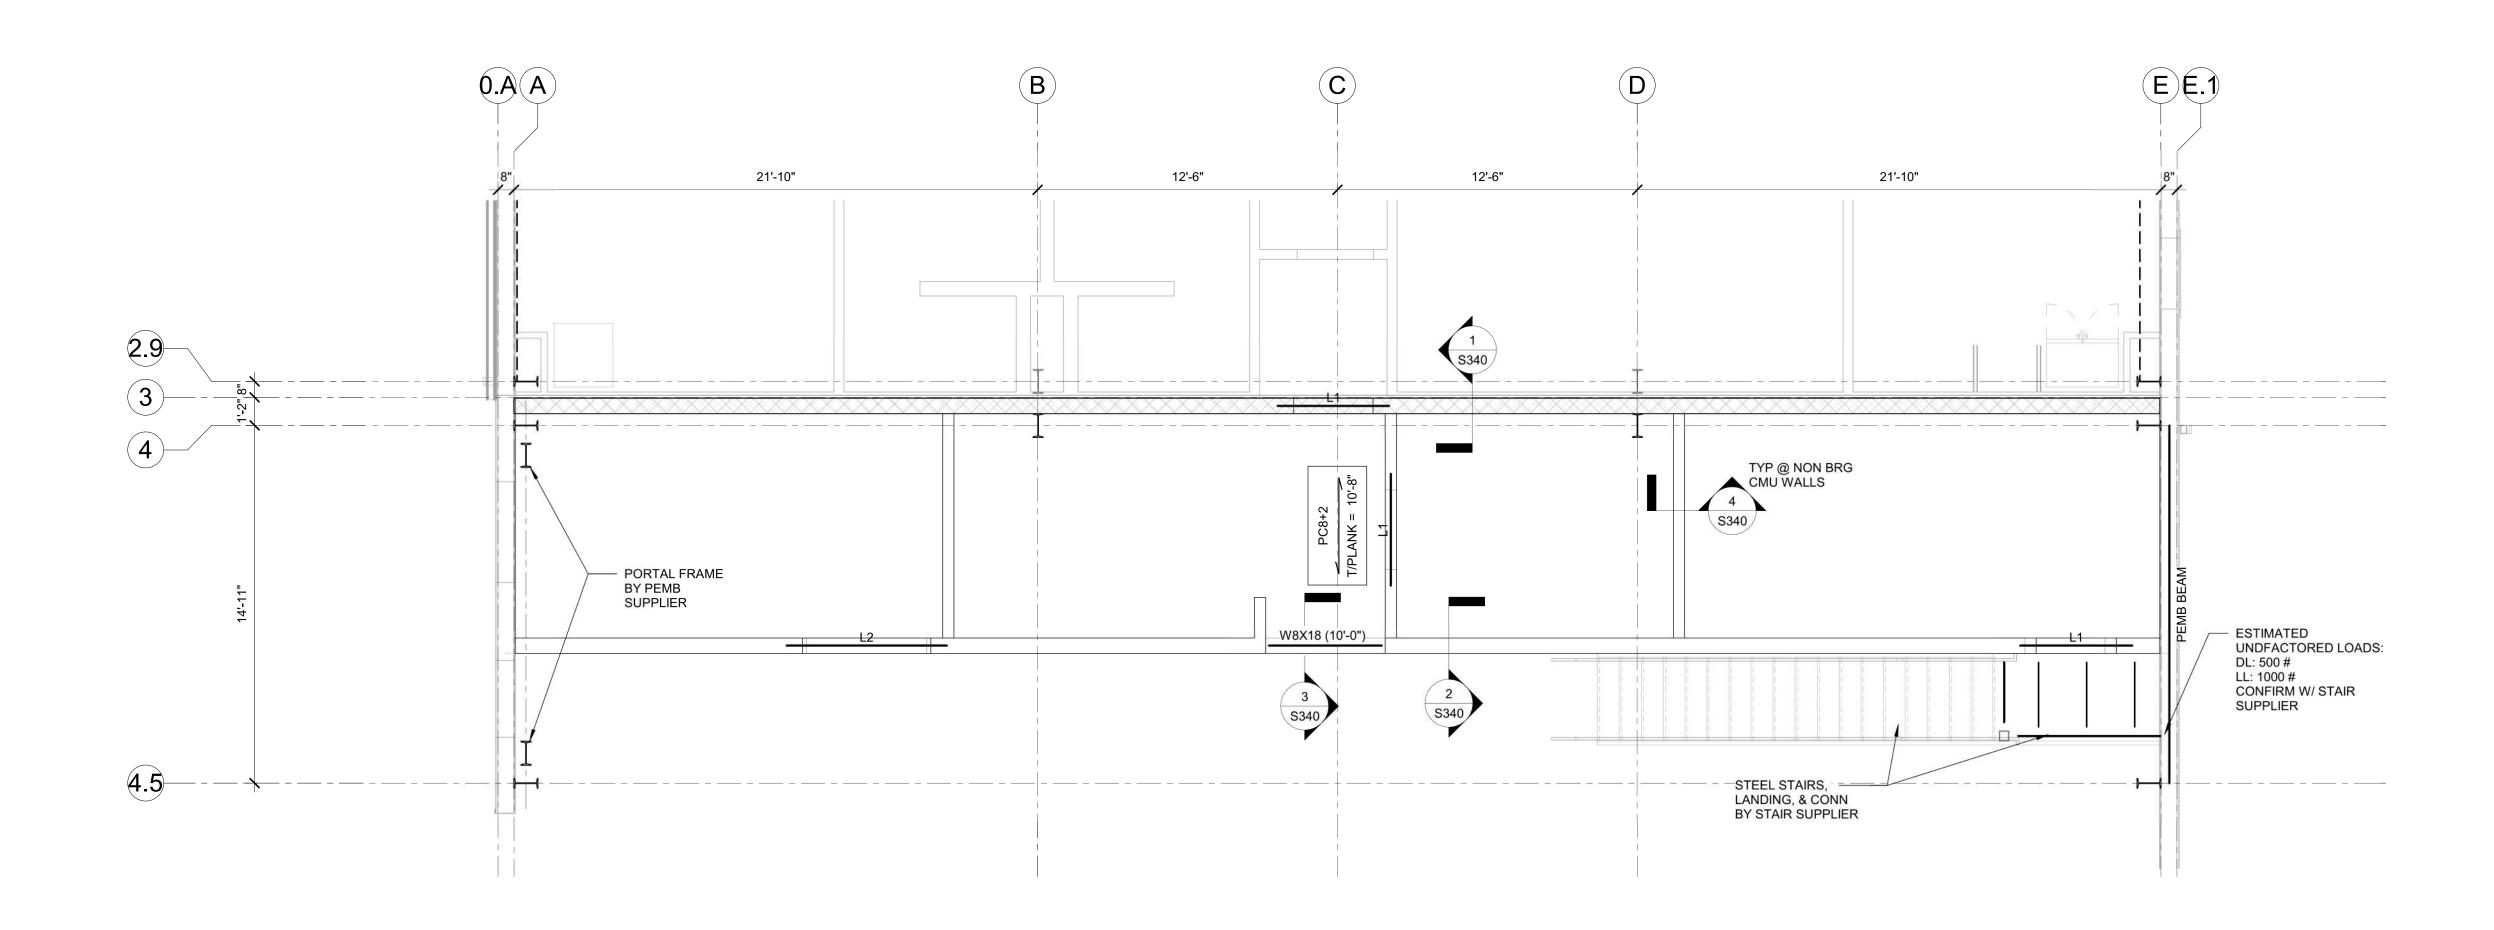

FLOOR FRAMING PLAN NOTES:

1. SEE SHEET S001 FOR STRUCTURAL GENERAL NOTES AND S002 FOR STRUCTURAL SCHEDULES.

- 2. SEE SHEET S400 FOR TYPICAL MASONRY SECTIONS AND DETAILS, INCLUDING TYPICAL WALL REINFORCING.
 3. SEE SHEET S500 FOR TYPICAL STEEL SECTIONS AND DETAILS.
 4. SEE ARCHITECTURAL DRAWINGS FOR DOOR OPENING SIZES,
 - ELEVATIONS AND LOCATIONS IN MASONRY WALLS NOT SHOWN ON
- PLAN.
 5. GC TO COORDINATE SIZE & LOCATIONS OF ALL FLOOR
 PENETRATIONS & WALL OPENINGS WITH MECHANICAL, PLUMBING &
 ELECTRICAL CONTRACTORS.
 6. ALL PRECAST PLANK JOINTS SHALL BE GROUTED.
 7. GENERAL CONTRACTOR TO PROVIDE ALL SHORING REQUIRED FOR EXISTING BUILDING AND/OR NEW BUILDING. SEE GENERAL REQUIREMENTS NOTE 1 AND EXISTING CONSTRUCTION NOTE 3 FOR ADDITIONAL INFORMATION.



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Sheet Title

N70 W5185 Columbia Road

C4E Project #: 25114 IL DESIGN FIRM 184-006824

MEZZANINE FRAMING PLAN

Ref. North

S102


Sheet No.

engineering PROFESSIONAL DESIGN FIRM REGISTRATION # 184-003342 Cedarburg, WI 53012 | 262.236.9372




FOUNDATION PLAN NOTES: 1. SEE SHEET S001 FOR STRUCTURAL GENERAL NOTES AND S002 FOR

- STRUCTURAL SCHEDULES. SEE SHEET S300 FOR FOUNDATION WALL CONSTRUCTION JOINTS AND TYPICAL REINFORCING DETAILS. . TOP OF EXTERIOR FOOTING ELEVATION = -3'-0'' UNO.
- 4. TOP OF INTERIOR FOOTING ELEVATION = -1'-0" UNO. 5. TOP OF PIER ELEVATION = 0'-0" UNO.
- 6. TOP OF FOUNDATION WALL ELEVATION = 0'-0" UNO.
 7. SEE MECHANICAL DRAWINGS FOR HOUSEKEEPING PADS REQUIRED FOR MECHANICAL EQUIPMENT.
- SEE ARCHITECTURAL DRAWINGS FOR DOOR OPENING SIZES AND LOCATIONS IN WALLS. COORDINATE WITH ARCHITECTURAL DRAWINGS AND FRAMING
- PLANS FOR HOLDDOWN REINFORCING LOCATIONS IN FOUNDATION
- 10. GENERAL CONTRACTOR TO PROVIDE ALL SHORING REQUIRED FOR EXISTING BUILDING AND/OR NEW BUILDING. SEE GENERAL REQUIREMENTS NOTE 1 AND EXISTING CONSTRUCTION NOTE 3 FOR ADDITIONAL INFORMATION.

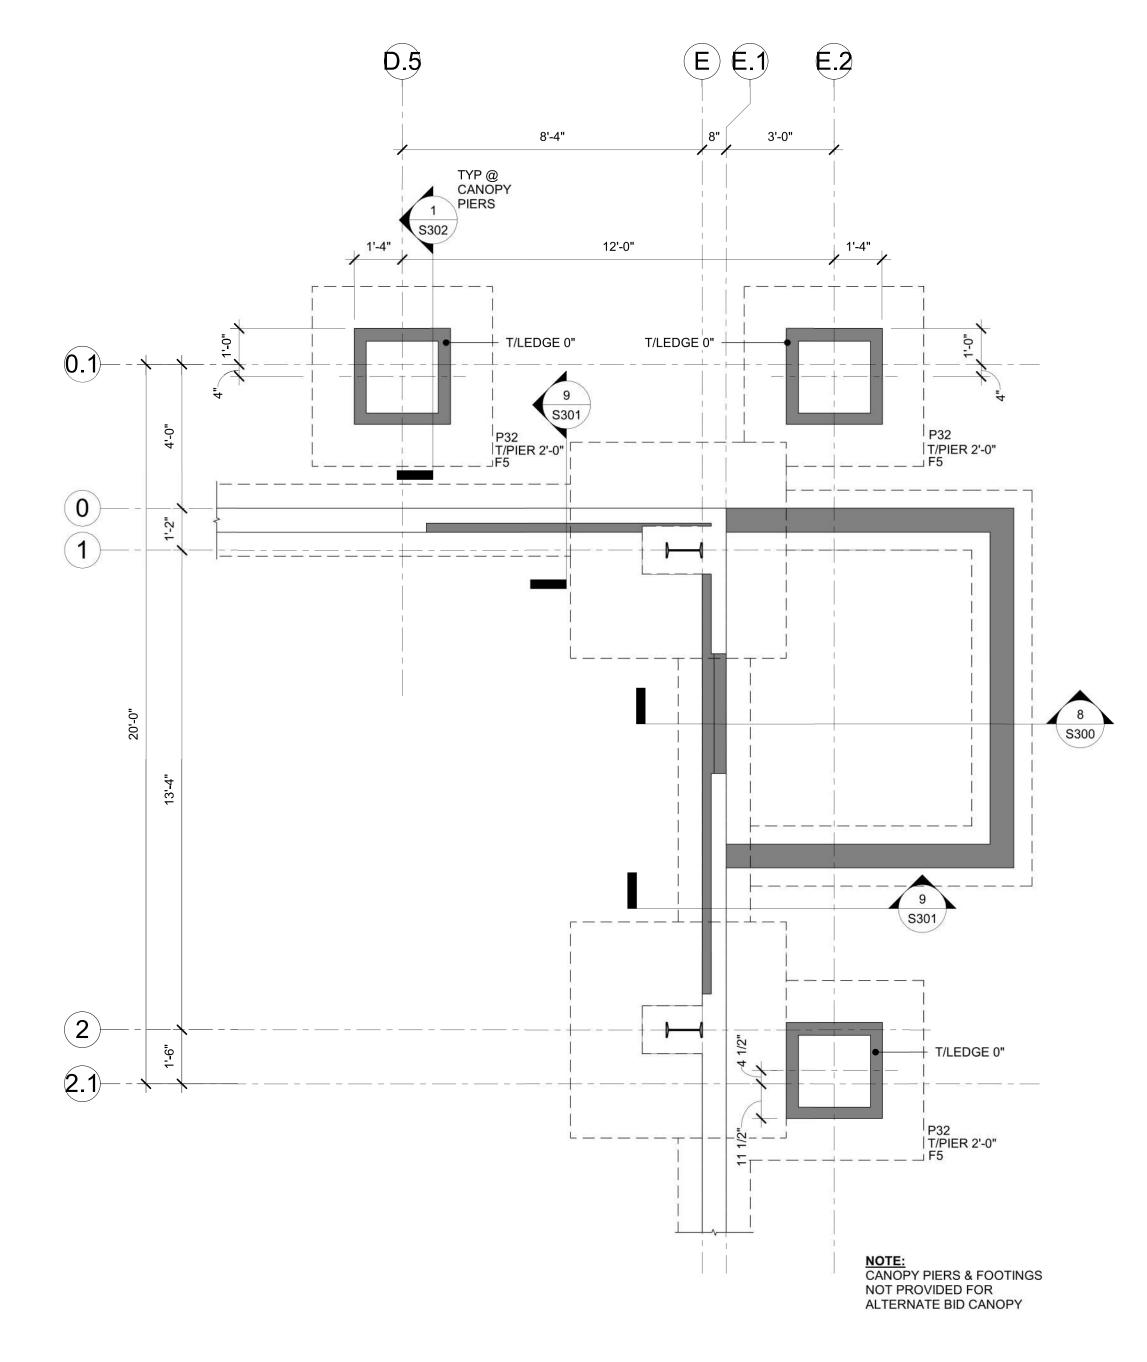



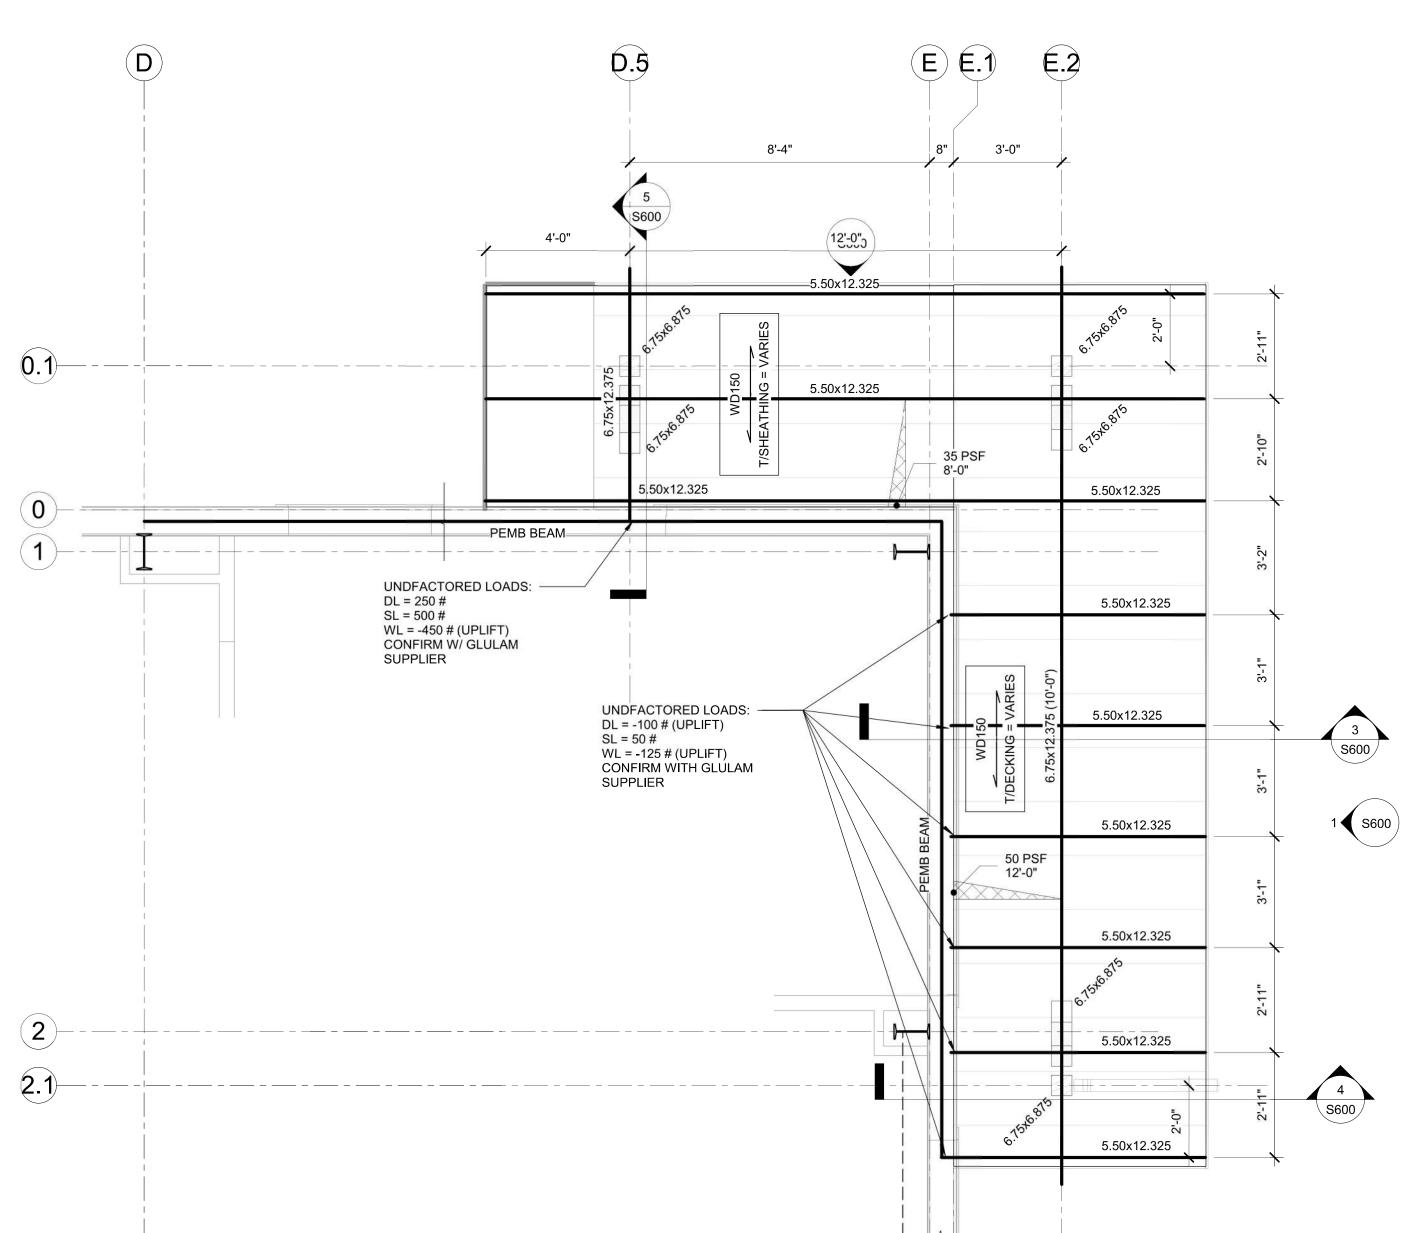







ROOF PLAN NOTES:

1. SEE SHEET S001 FOR STRUCTURAL GENERAL NOTES AND S002 FOR

STRUCTURAL SCHEDULES.
2. SEE SHEET S400 FOR TYPICAL MASONRY SECTIONS AND DETAILS,

SEE SHEET S600 FOR TYPICAL WOOD SECTIONS AND DETAILS.
 SEE ARCHITECTURAL DRAWINGS FOR GLULAM PROFILES, HEEL

HEIGHTS, TRUSS BEARING ELEVATIONS AND ROOF SLOPES. 5. ALL GLULAM MEMBERS ARE TO BE SOUTHERN PINE, TREATED &

GC TO COORDINATE FINAL SIZE AND LOCATION OF OPENINGS, EQUIPMENT AND ROOF DRAINS WITH MECHANICAL AND PLUMBING

GENERAL CONTRACTOR TO PROVIDE ALL SHORING REQUIRED FOR EXISTING BUILDING AND/OR NEW BUILDING. SEE GENERAL

REQUIREMENTS NOTE 1 AND EXISTING CONSTRUCTION NOTE 3 FOR

INCLUDING TYPICAL WALL REINFORCING.

CONTRACTORS.

ADDITIONAL INFORMATION.

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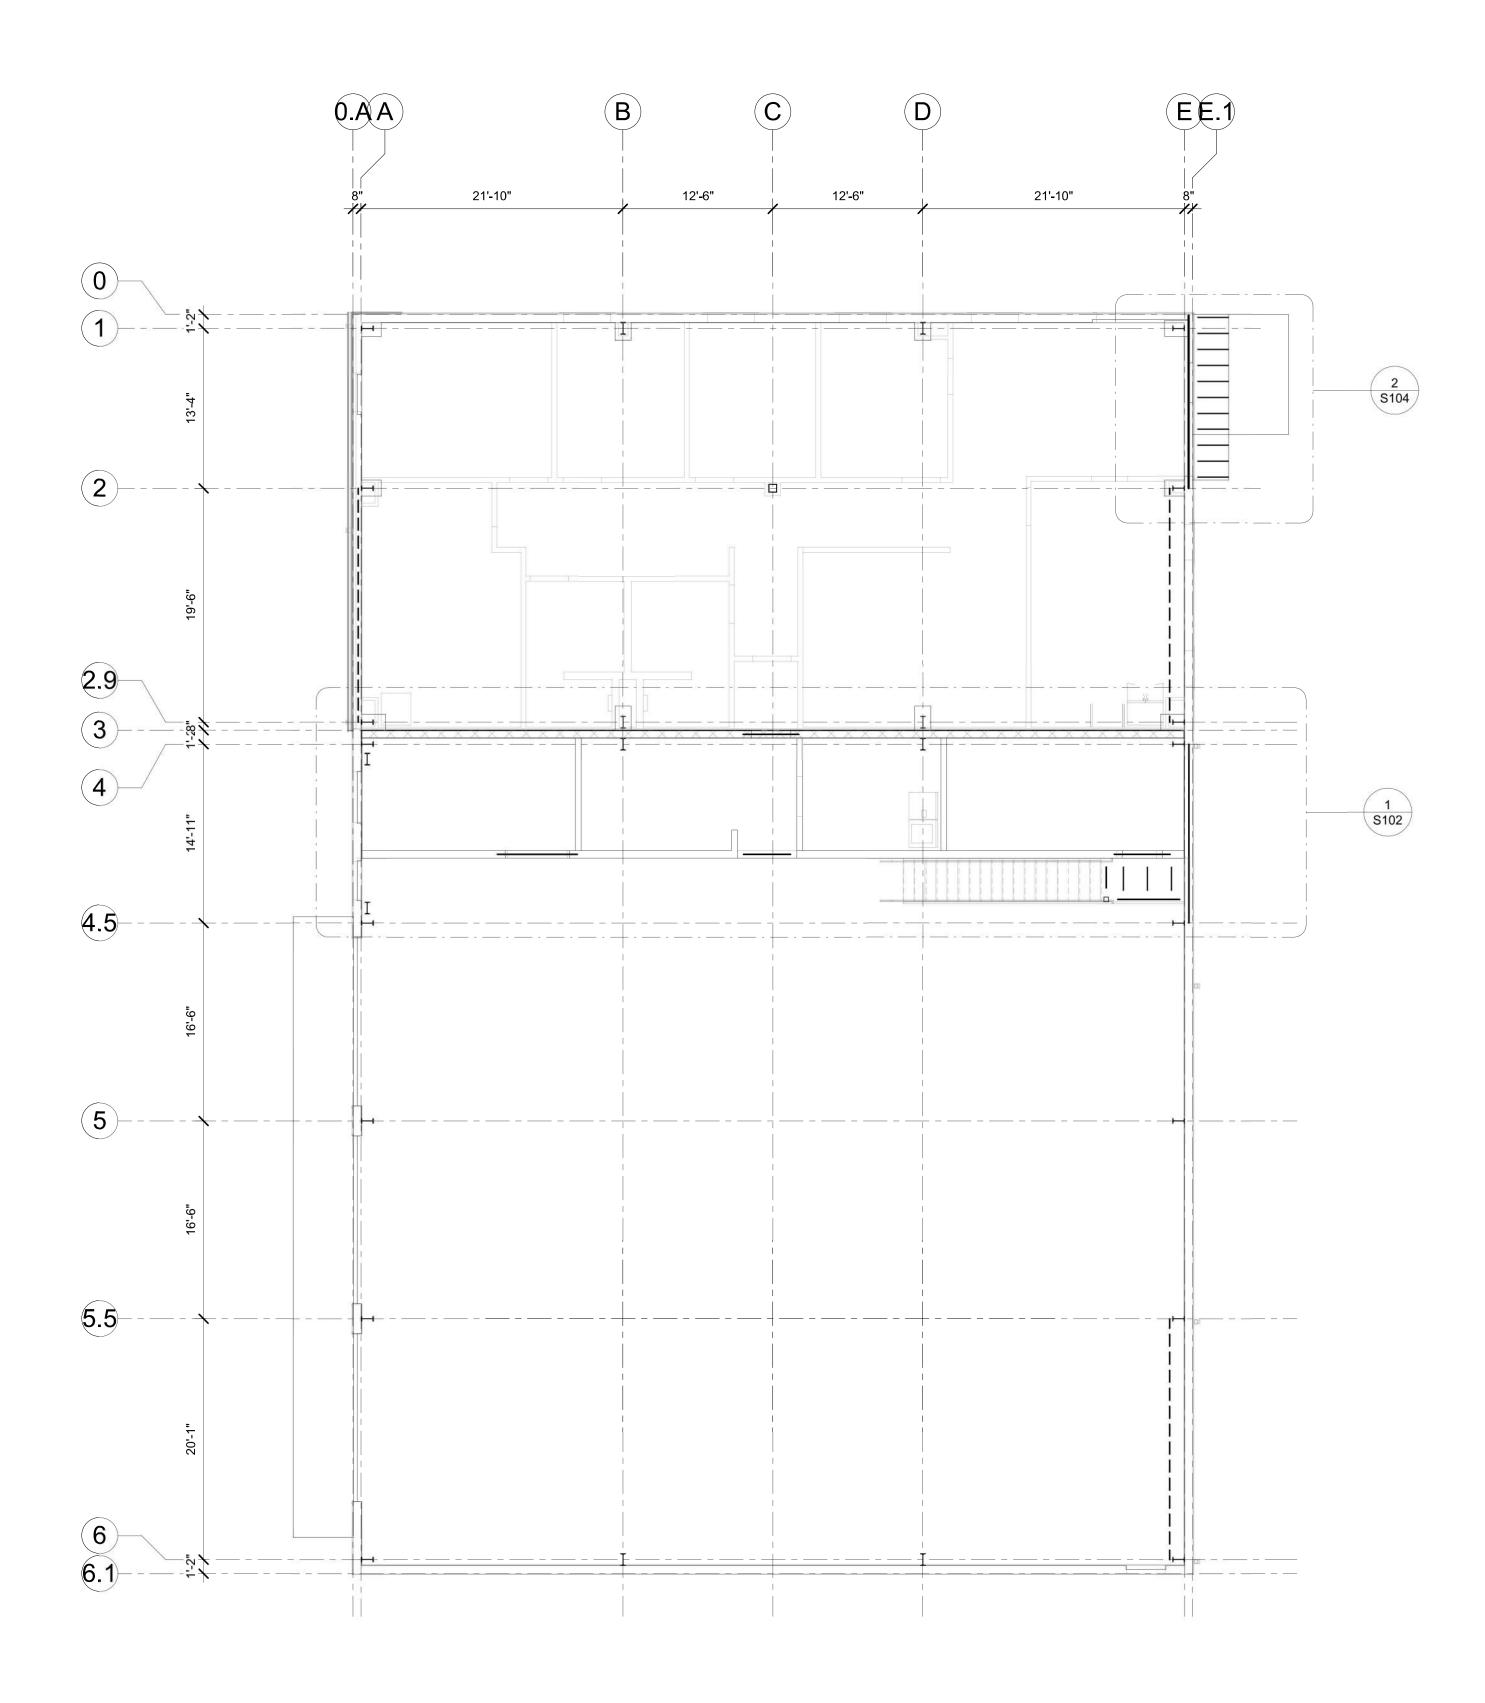
Sheet Title

ENLARGED FLOOR PLANS


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S103







MEZZANINE FRAMING PLAN - OVERALL
S104) SCALE: 1/8" = 1'-0"

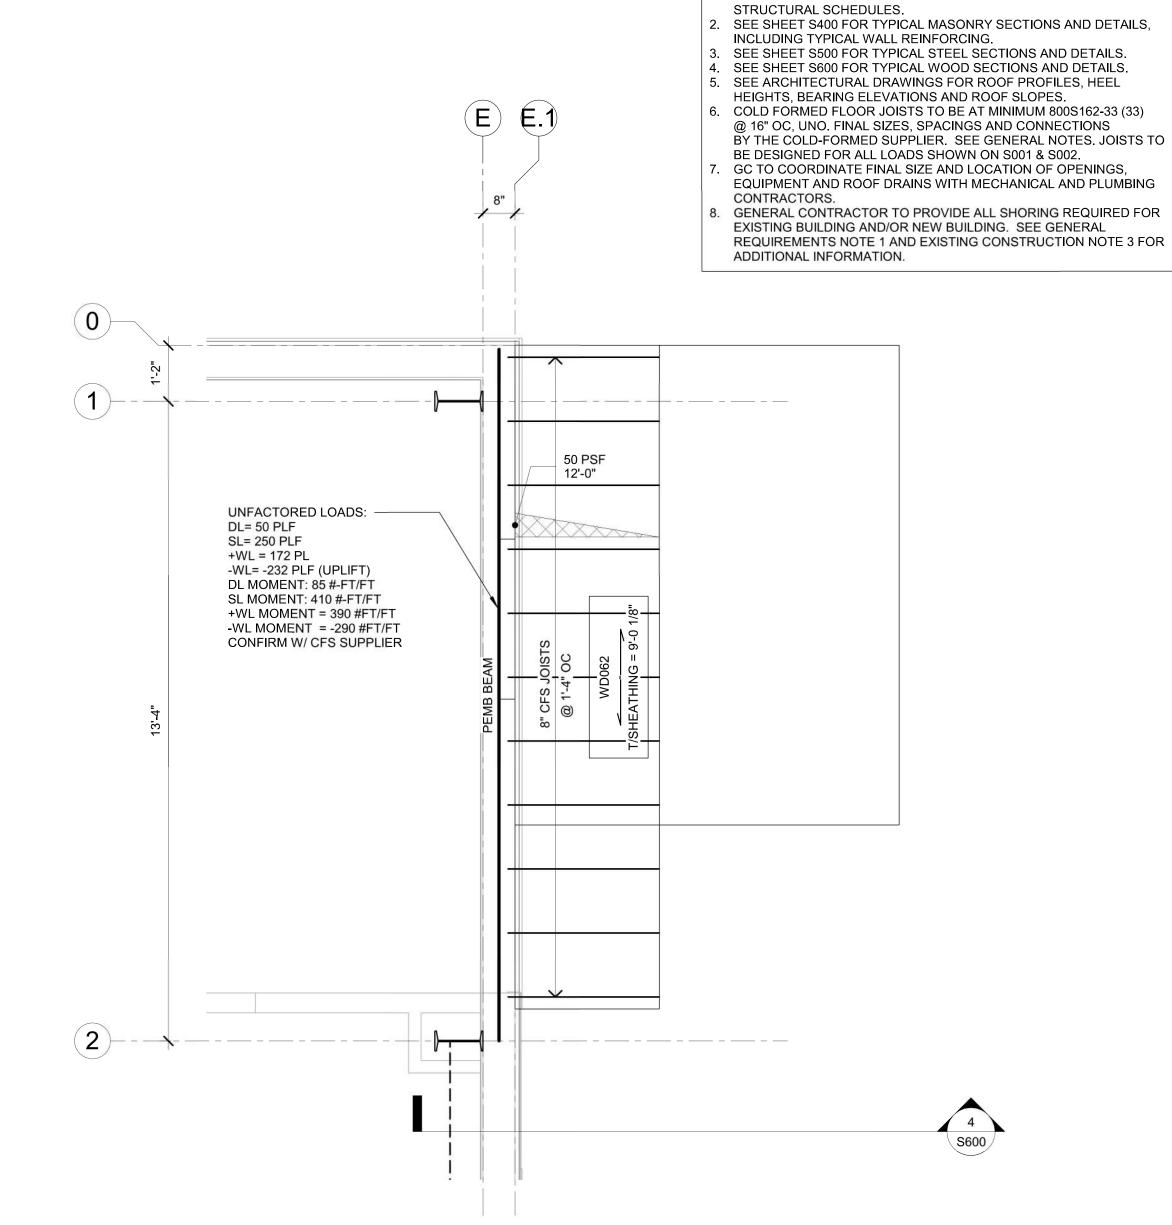

ALTERNATE BID CANOPY ROOF FRAMING PLAN SCALE: 1/2" = 1'-0"

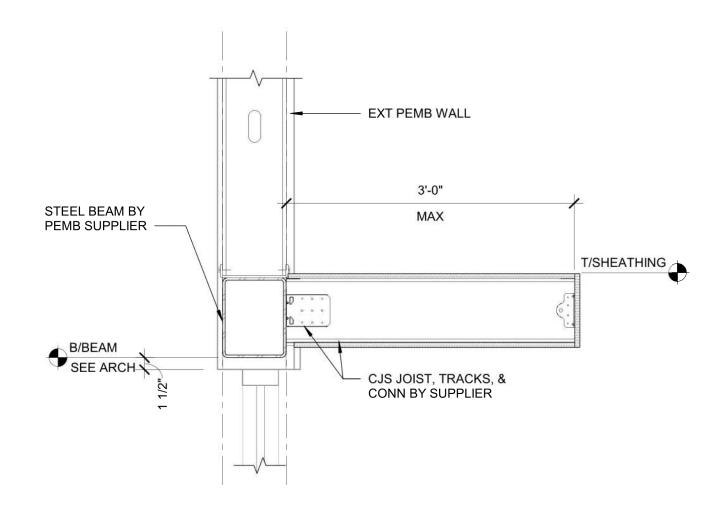



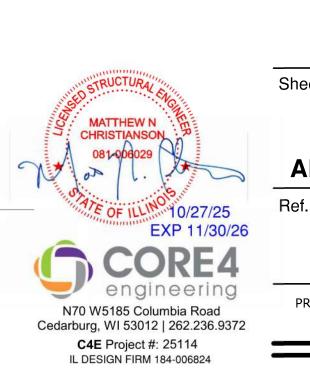



ROOF PLAN NOTES:

1. SEE SHEET S001 FOR STRUCTURAL GENERAL NOTES AND S002 FOR

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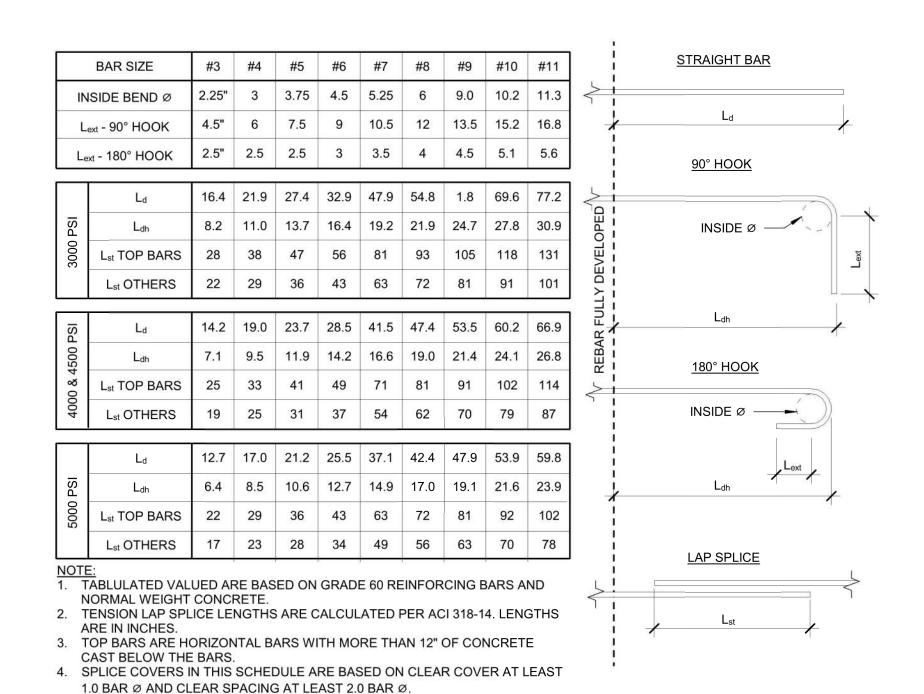
Sheet Title

ALTERNATE BID CANOPY

Ref. North

Sheet No.


S104



REINFORCING STEEL TYPICAL DEVELOPMENT LENGTHS & LAP SPLICES SCALE: NTS

ISOLATION JOINT

AROUND COLUMN

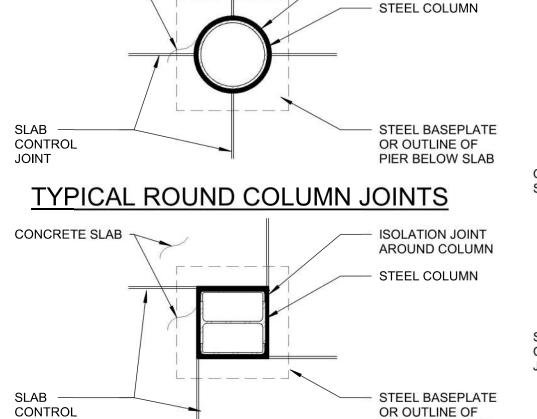


S300

CONCRETE SLAB ~

TYPICAL SQUARE COLUMN JOINTS



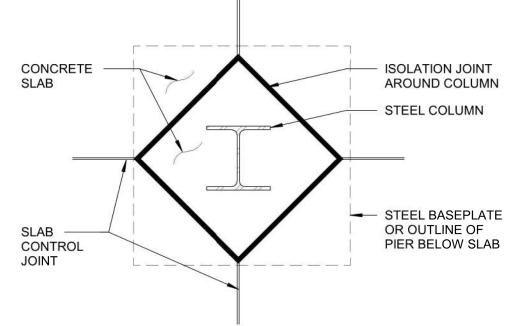

TYPICAL DIAMOND COLUMN JOINTS

4" CONCRETE

SLAB W/ #4's @

12" OC EACH WAY

(1) #5 CONT @ TOP


FOUNDATION WALL &


FOOTING TYPICAL 3

(2) #5 CONT



TYPICAL WALL **CONSTRUCTION JOINT**

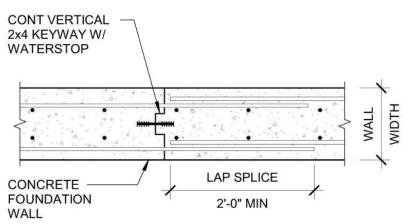

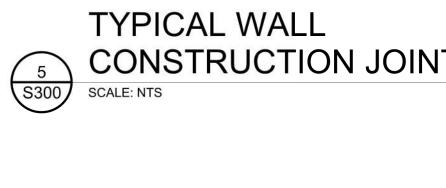

SLAB-ON-GRADE CONSTRUCTION SHOULD CONFORM WITH THE

RECOMMENDATIONS AND REQUIREMENTS SET FORTH IN THE

DRAWINGS & SPECIFICATIONS FOR SUB-FLOOR DRAINAGE SYSTEM,

SUBGRADE PREPARATION, MUD SLAB AND/OR VAPOR RETARDER

REFER TO PLANS FOR SLAB THICKNESS ("T") AND REINFORCEMENT

(WWF OR REINFORCEMENT BARS). REFER TO SPECIFICATIONS FOR

FIBER REINFORCEMENT TO BE INCORPORATED IN CONCRETE MIX,

IF ANY. WHERE PRESENT, REINFORCING BARS SHALL BE CHAIRED

CONTROL AND/OR CONSTRUCTION JOINTS AT EVERY COLUMN LINE

DOES NOT EXCEED 36 x ("T") UNO. THE RESULTING PANELS SHOULD

BREAK THE BOND BETWEEN NEW AND PREVIOUSLY PLACES SLABS

BY SPRAYING OR BY PAINTING THE EXPOSED SIDE OF THE JOINT

WITH A CURING COMPOUND, ASPHALTIC EMULSION, OR FORM OIL.

FOR SAW-CUT CONTROL JOINTS, MAKE THE SAW-CUT AS SOON AS

SAWING EQUIPMENT WITHOUT DAMAGE TO THE FINISHED SURFACE

THE SLAB IS ABLE TO SUPPORT THE WEIGHT OF WORKERS AND

DEPTH OF SAW-CUT SHOULD BE 1 1/4" IF PRODUCED USING THE

3. VERIFY WITH ARCHITECT FOR EPOXY RESIN OR ELASTOMERIC

EARLY ENTRY DRY-CUT PROCESS AND "T"/4 (1" MIN) IF PRODUCED

FORM CONTROL JOINTS BY INSERTING A PRE-MOLDED STRIP INTO

THE FRESH CONCRETE UNTIL THE TOP SURFACE OF THE STRIP IS

TYPICAL SLAB JOINTS

2. TOOL THE SLAB EDGES ROUND ON EACH SIDE OF THE INSERT, 1/8"

AFTER THE CONCRETE HAS CURED, REMOVE THE INSERTS AND

AND IN BETWEEN THE COLUMNS SUCH THAT THE JOINT SPACING

5. PROVIDE (2) #5 x 4'-0" AT ALL RE-ENTRANT CORNERS AND OTHER

6. UNLESS SHOWN OTHERWISE ON THE DRAWINGS, PROVIDE

3. THE SUBGRADE SHALL BE FREE OF STANDING WATER AT THE TIME

REQUIREMENTS

OF CONCRETE PLACEMENT.

BY SOIL SUPPORTED SLAB BOLSTERS.

SIMILAR SLAB DISCONTINUITIES.

BE APPROXIMATELY SQUARE.

SECTION 2: CONSTRUCTION JOINT NOTES

OF THE SLAB, BUT WITHIN 24 HOURS.


USING THE CONVENTIONAL WET-CUT PROCESS.

SECTION 4: FORMED CONTROL JOINT OPTION NOTES

FLUSH WITH THE TOP SURFACE OF THE SLAB.

CLEAN THE GROOVE OF LOOSE DEBRIS.

SEALANT REQUIREMENTS TO FILL CONTROL JOINTS.

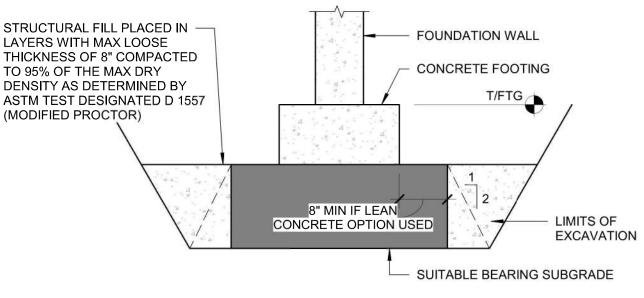


<u>NOTES:</u> 1. CONTRACTOR'S OPTION: ELIMINATE STRUCTURAL FILL BY LOWERING DESIGNED FOOTING ELEVATION SO THAT FOOTING RESTS DIRECTLY ON UNDER THE FOOTING AS SHOWN HATCHED ABOVE, OR INCREASE FOOTING THICKNESS TO REACH SUITABLE BEARING SUBGRADE THIS DETAIL APPLIES ONLY AT THOSE LOCATIONS WHERE GEOTECH ENGINEER DEEMS SOILS AT DESIGNED FOOTING ELEVATIONS ARE INADEQUATE FOR FOOTING SUPPORT. WHERE THIS WORK IS REQUIRED, CONTRACTOR WILL BE

COMPENSATED ON A PRE-ESTABLISHED UNIT COST AGREED UPON BY THE


TYPICAL OVER EXCAVATION DETAIL

CONTRACTOR, ARCHITECT/ENGINEER, AND OWNER.

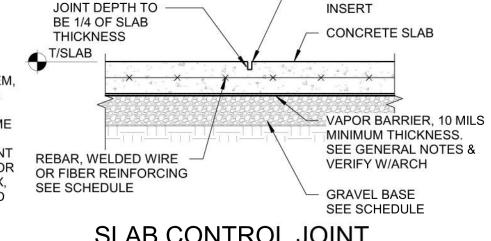

SAWCUT CONTROL JOINT OR PLASTIC

SLAB CONTROL JOINT

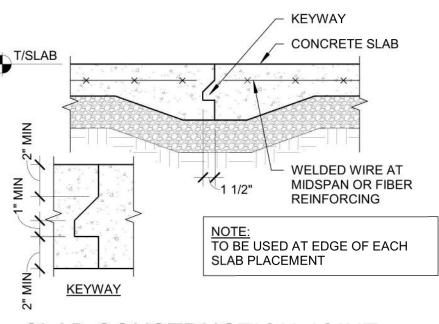

SLAB CONSTRUCTION JOINT

1'-0" MIN


TYPICAL WALL

REINFORCING
SCALE: NTS


CONTINUOUS


VERTICAL 2x4

KEYWAY W/ WATERSTOP

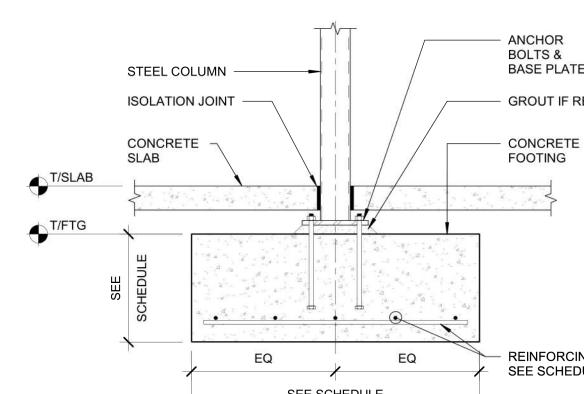

TYPICAL COLUMN BEARING (3 (S300)

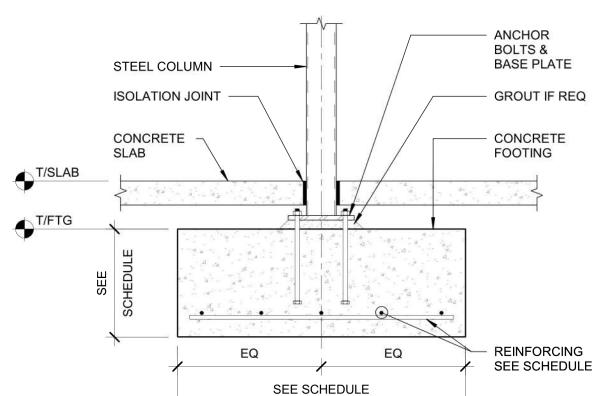

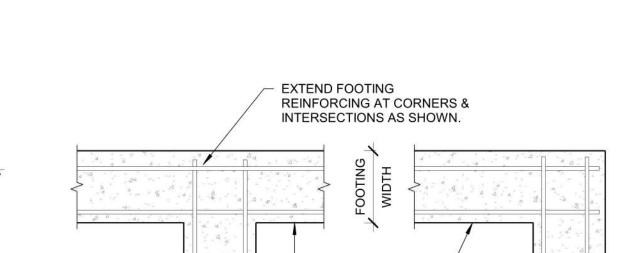


CONCRETE

FOOTING

TYPICAL FOOTING REINFORCING



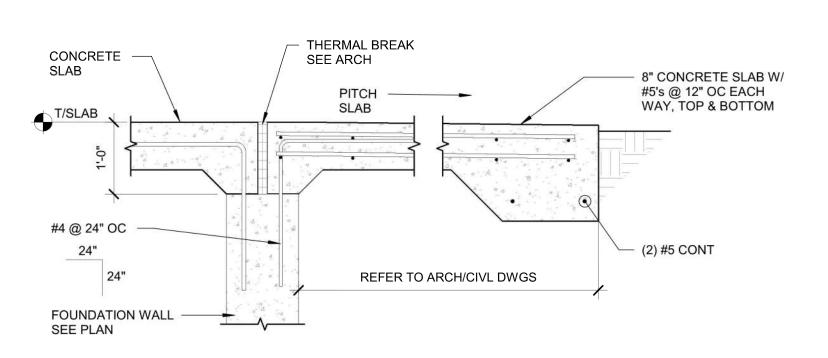

TYP VERT WALL

REINF (2-#5 MIN)

CONCRETE


FOUNDATION WALL

MATCH SIZE & SPACING

BENT BARS TO

OF HORIZ BARS

NOTE: BETWEEN OVERHEAD DOORS PROVIDE #4 BARS x 24" AT 18" OC (MAX), 6" EMBED INTO ADJACENT FND WALL.

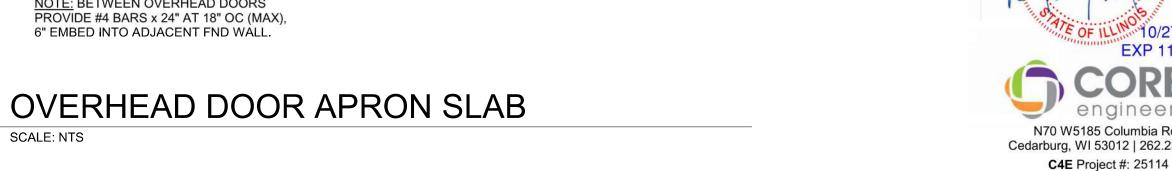



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Sheet Title

EXP 11/30/26

IL DESIGN FIRM 184-006824

CONCRETE SECTIONS & DETAILS

Ref. North

Sheet No

S300

PROFESSIONAL DESIGN FIRM REGISTRATION #

engineering N70 W5185 Columbia Road 184-003342 Cedarburg, WI 53012 | 262.236.9372

SCALE: NTS

CONCRETE

#4 @ 24" OC

SEE PLAN

FOUNDATION WALL

T/SLAB.

TYPICAL STOOP SECTION

CLEAR STONE, NON-

MINIMUM STOOP DIMENSIONS AS FOLLOWS:

4" BEYOND DOOR JAMB AT HINGE SIDE

1'-6" BEYOND DOOR JAMB AT LATCH SIDE

COORDINATE FINAL LOCATION WITH ARCH/CIVIL.

5'-0" FROM FACE OF BUILDING


COMPACTED BACKFILL


THERMAL BREAK


SLAB

#4 @ 24" OC

SEE ARCH

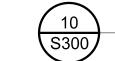

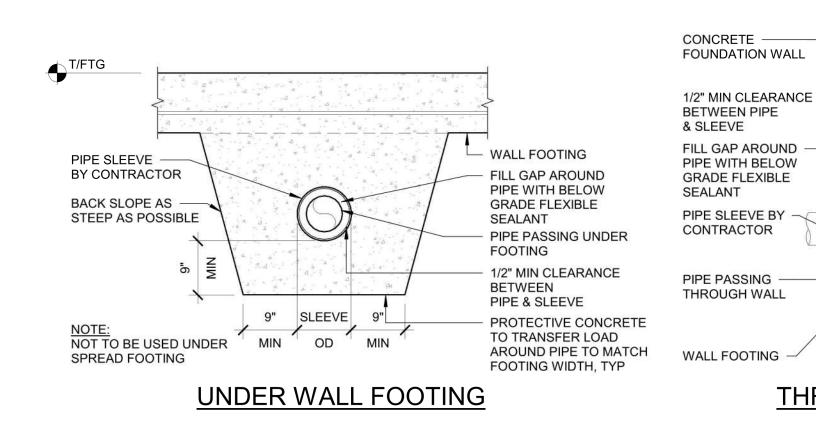

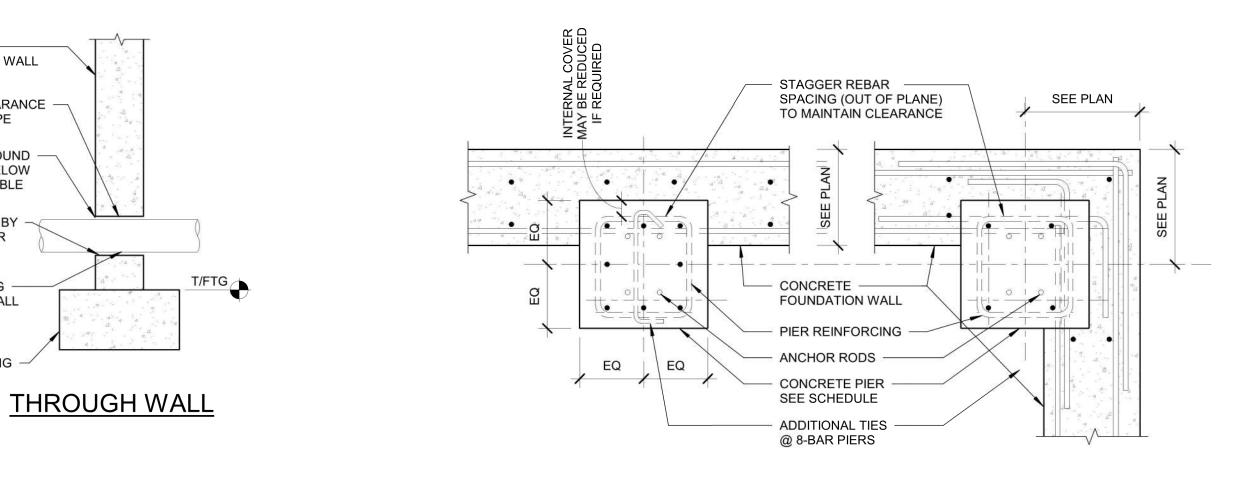

S301

EMBED LENGTH

(IN.)

12

14

3/4

7/8

1 1/4

1 1/2

1 3/4

2 1/2

TYPICAL PEMB ANCHOR ROD


TYPICAL PIER AT WALL AND CORNER

6" DIA CONCRETE

ISOLATION JOINT


FILLED STEEL POST


6 S301

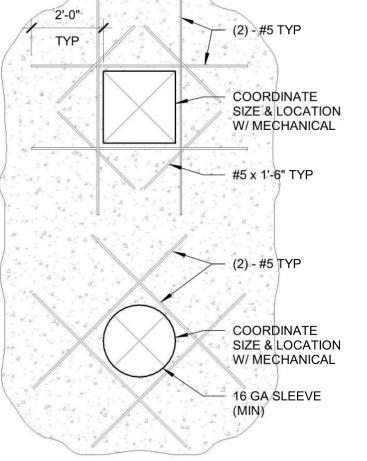



1. APPLIES TO 24" (MAX) OPENINGS THROUGH FOUNDATION WALL. 2. TOP OF OPENING TO BE 24" (MIN) FROM TOP OF WALL. 3. REINFORCING LAYERS TO MATCH FOUNDATION WALL 4. USE 90° STANDARD HOOK AT CORNERS AND ENDS OF WALL




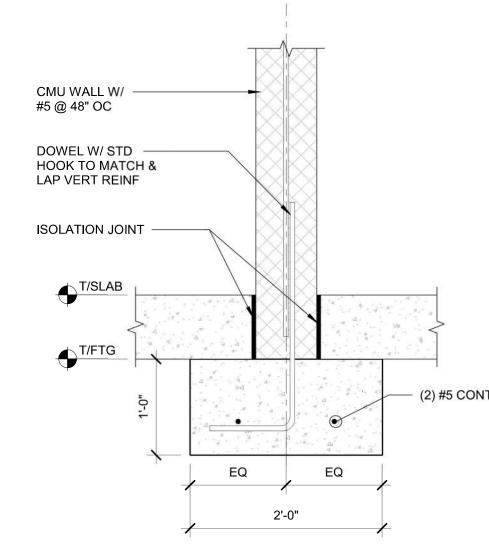

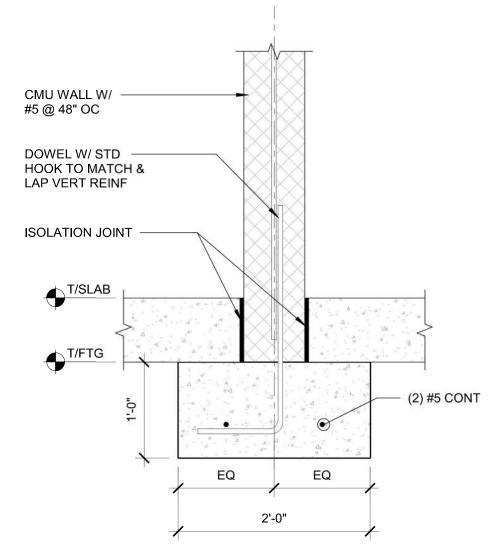

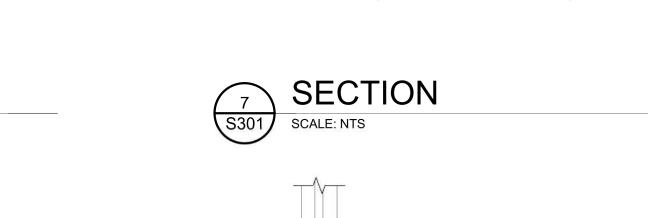

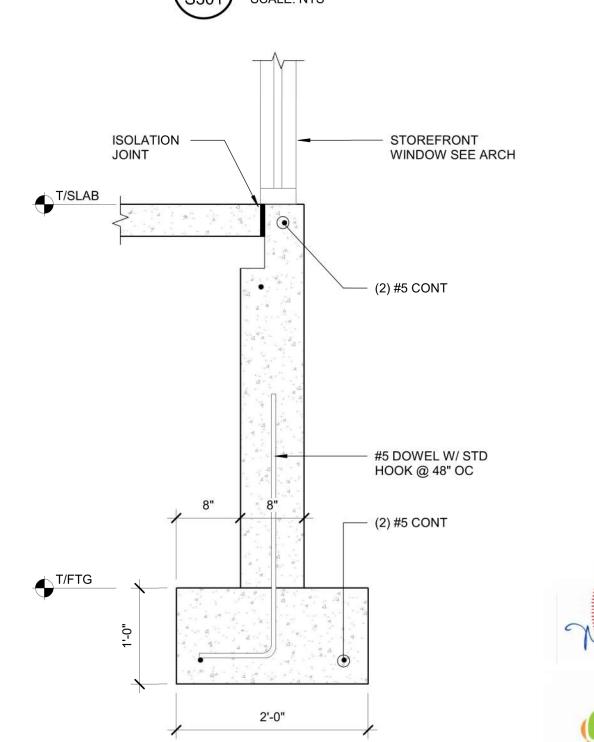

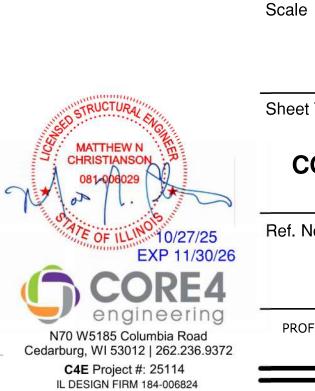

blakemore-architects.com

BLAKEMORE

ARCHITECTS

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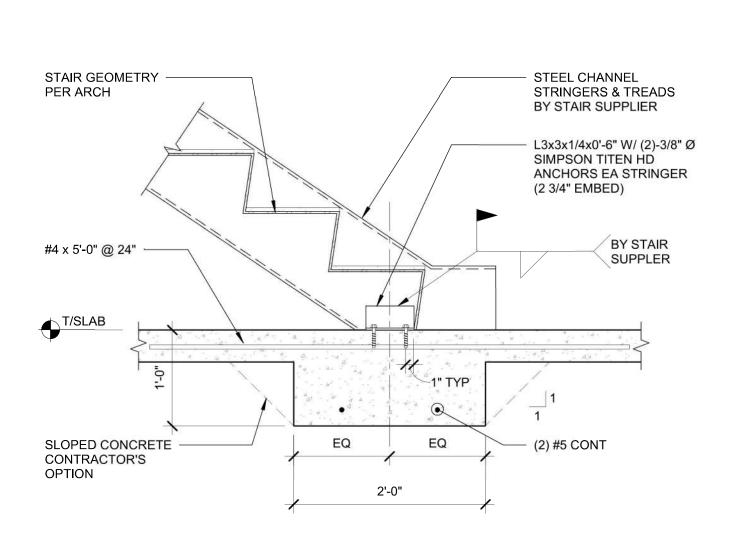
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S301


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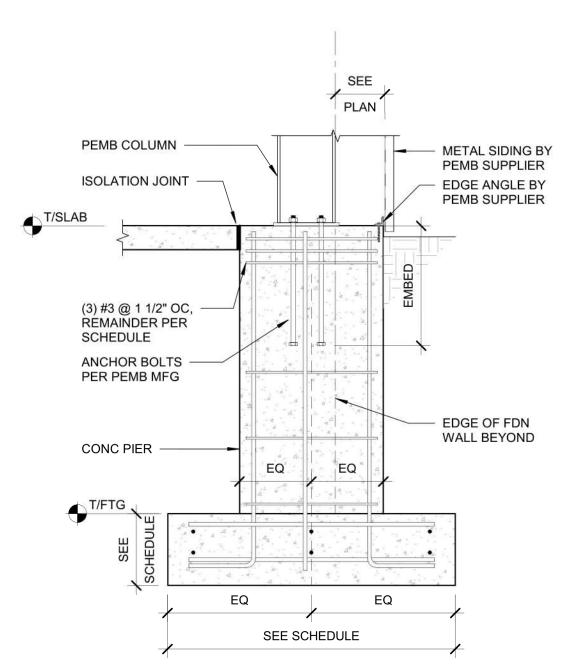










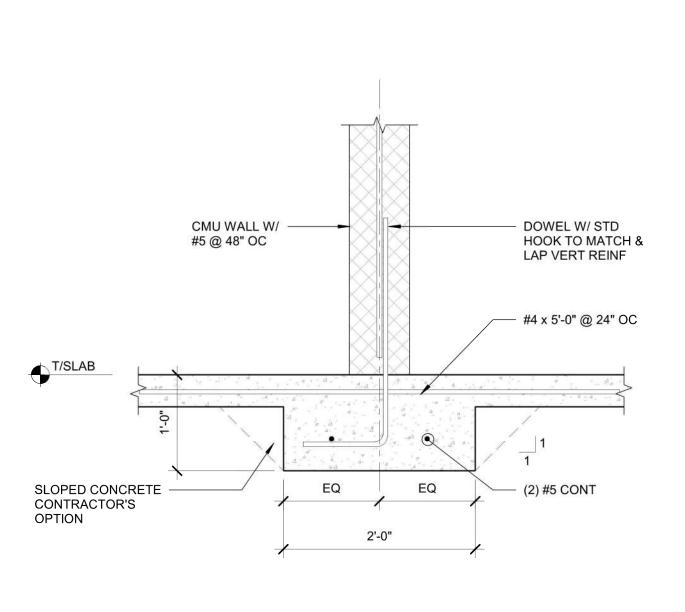

STEEL COLUMN, NUT, WASHER AND BASE PLATE

BY PEMB SUPPLIER

ANCHOR ROD


SIZE BY PEMB SUPPLIER **HEX NUT**

CONCRETE


FOOTING, PIER, OR WALL


⊕T/CONC



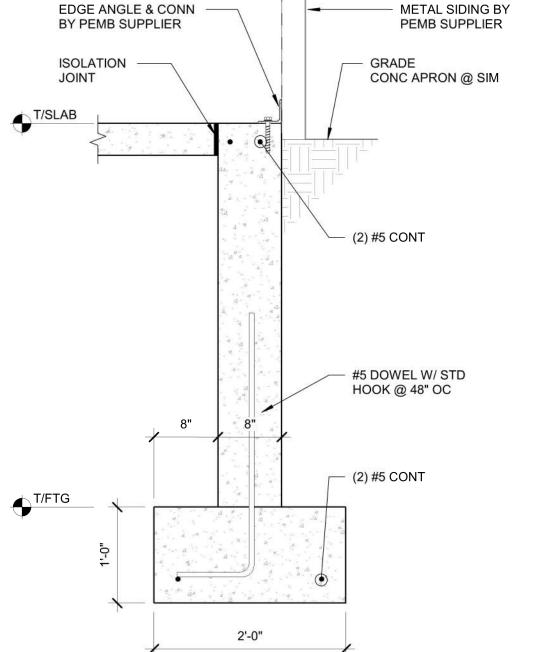

TYPICAL BOLLARD

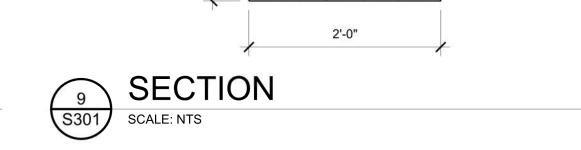

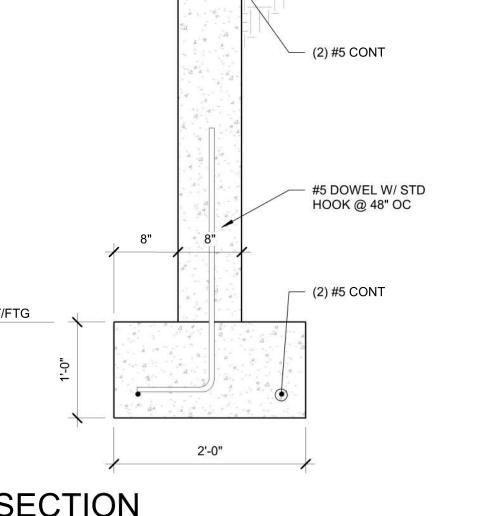

SCALE: NTS


SECTION


SITE PAVING


CONCRETE FOOTING

SUBGRADE SOIL

SEE CIVIL

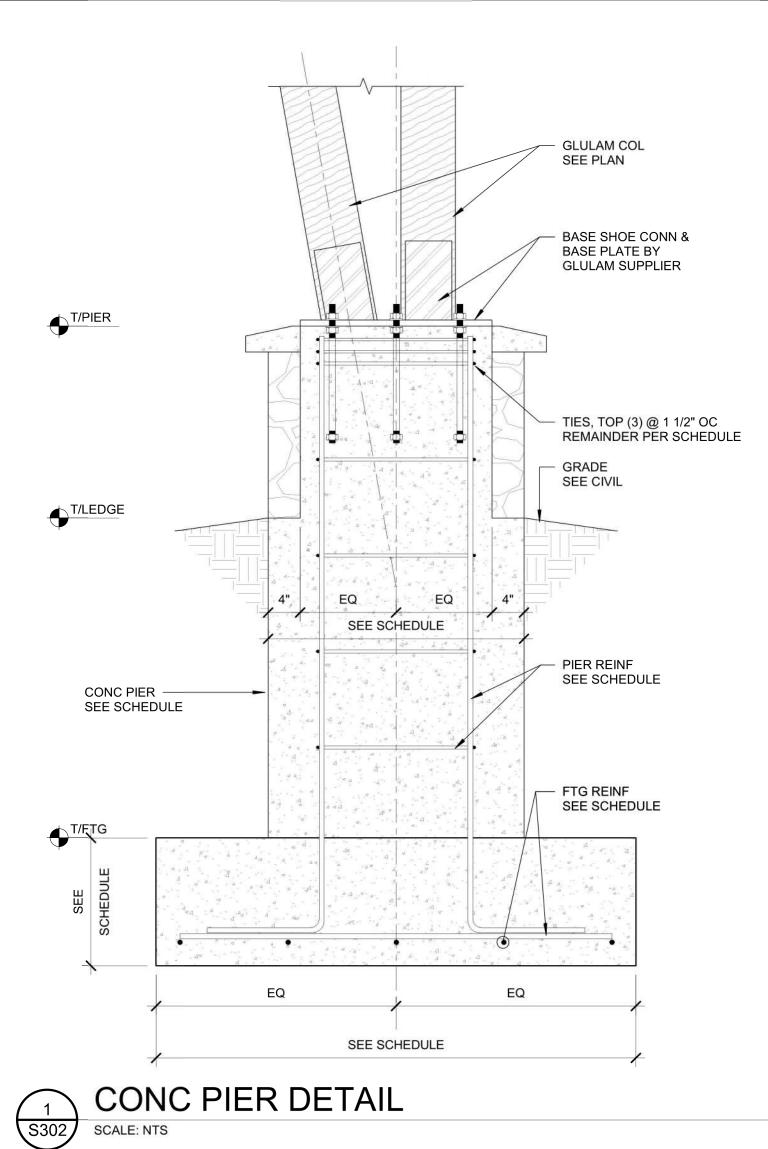


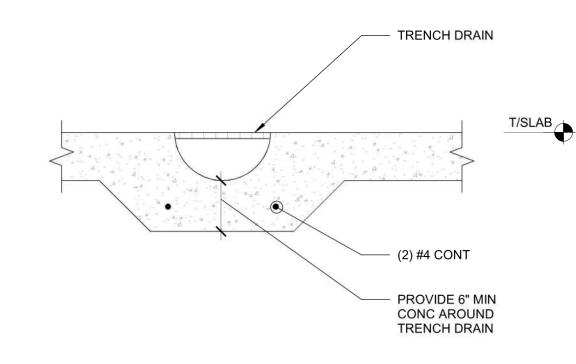

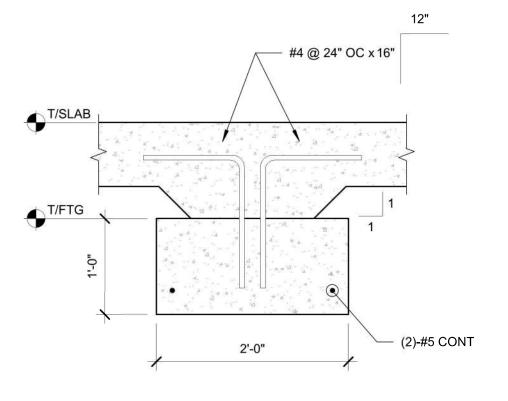

SECTION


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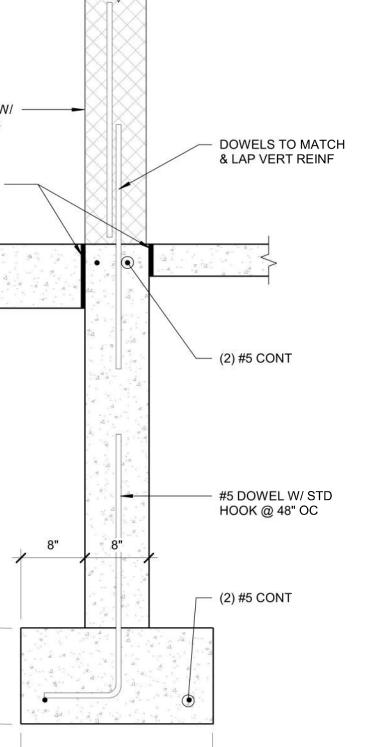


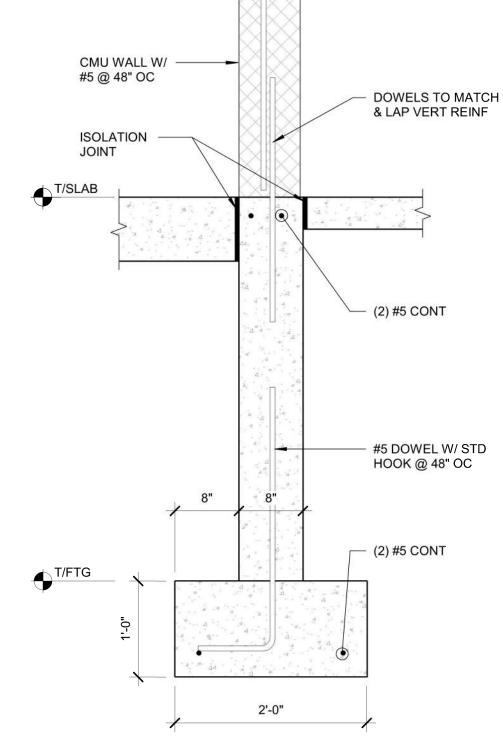







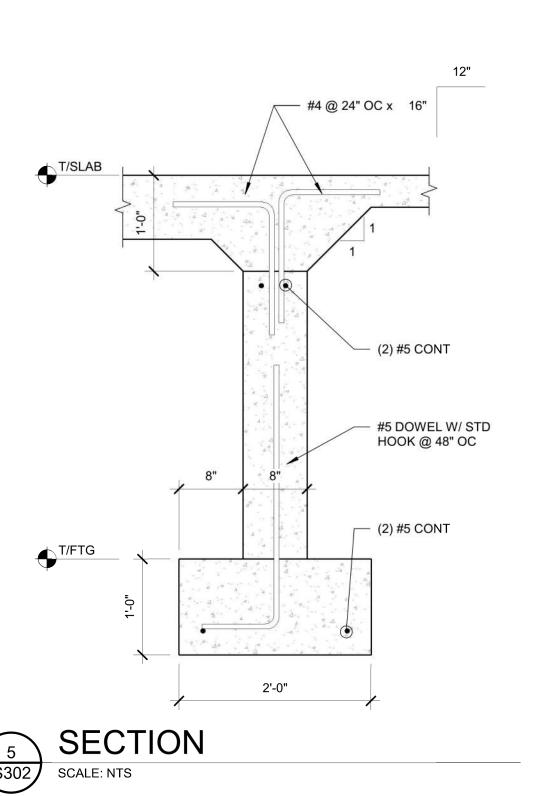

DESCRIPTION NO. DATE

PERMISSION OF THE ARCHITECT.

BLAKEMORE

ARCHITECTS

400 N. First Street Rockford, IL 61107

T: 815-227-0023 E: brian@blakemore-architects.com Web: blakemore-architects.com

New Building

for

Forest Preserves of

Winnebago County

Meridian Rd.,

Winnebago County, Illinois

DIMENSIONS AND CONDITIONS AT THE SITE PRIOR TO SUBMITTING A BID. THE CONTRACTOR SHALL COORDINATE ALL DRAWINGS WITH ACTUAL FIELD CONDITIONS PRIOR TO PROCEEDING WITH THE WORK AND NOTIFY THE ARCHITECT OF ANY DISCREPANCIES. THIS DRAWING IS THE PROPERTY OF BLAKEMORE ARCHITECTS AND MAY NOT BE REPRODUCED WITHOUT THE PRIOR WRITTEN

1) 05-08-2025 Initial Layout 2) 08-07-2025 Schematic Design 08-27-2025 Design Development 10-17-2025 Final Owner Review Set 10-27-2025 Issued for Bids / Permit

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2025-09

Sheet Title

CONCRETE SECTIONS & DETAILS


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S302


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PROFESSIONAL DESIGN FIRM REGISTRATION # 184-003342


N70 W5185 Columbia Road Cedarburg, WI 53012 | 262.236.9372 C4E Project #: 25114 IL DESIGN FIRM 184-006824




PRECAST ON CMU

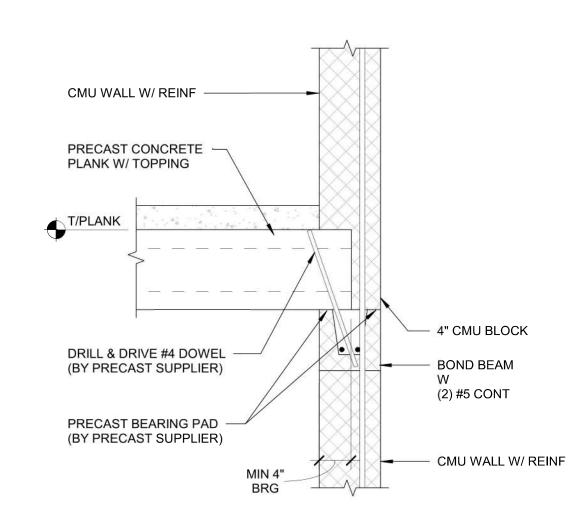

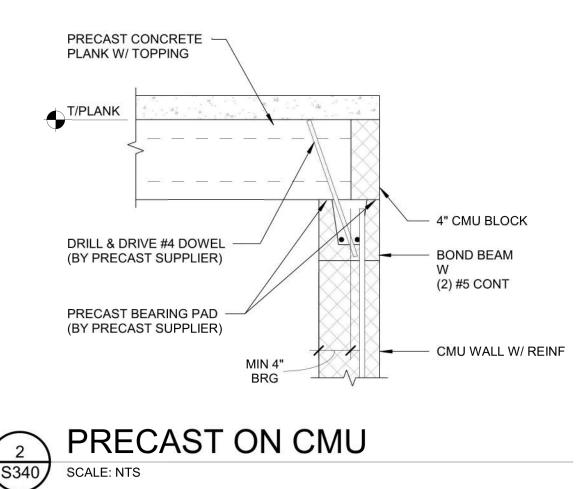2 S340

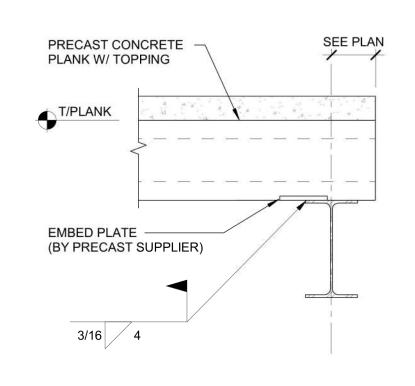

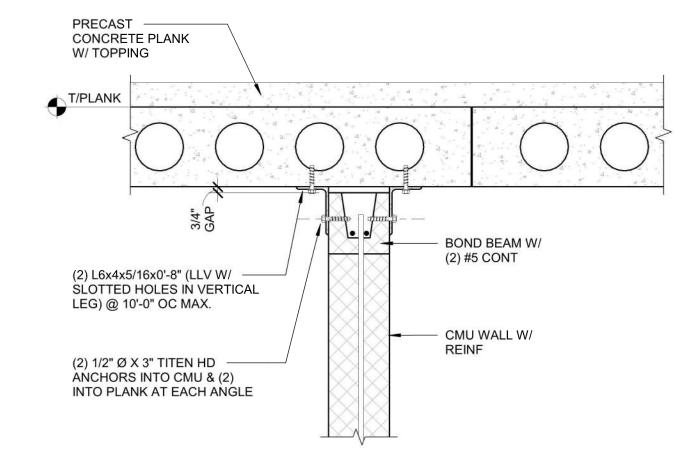







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New Building

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1" = 1'-0"

Sheet Title

Scale

PRECAST SECTIONS & **DETAILS**


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Sheet No.


2025-09






TYPICAL MASONRY REINFORCING LAP LENGTHS

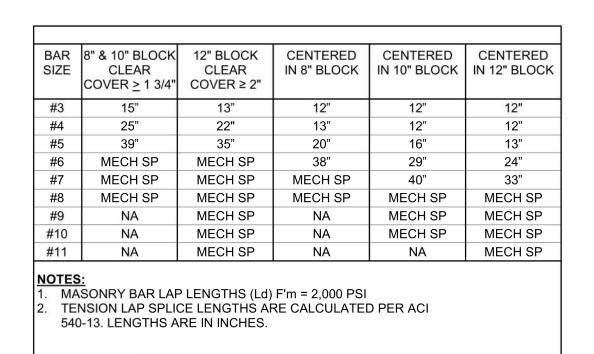S400 SCALE: NTS

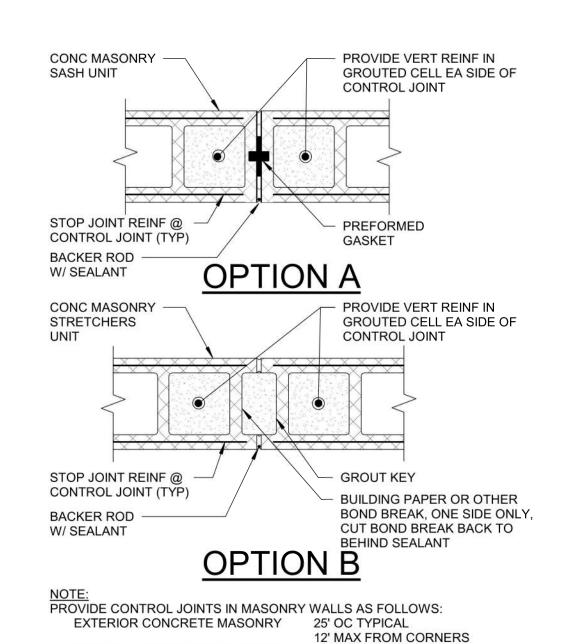




INTERIOR CONCRETE MASONRY

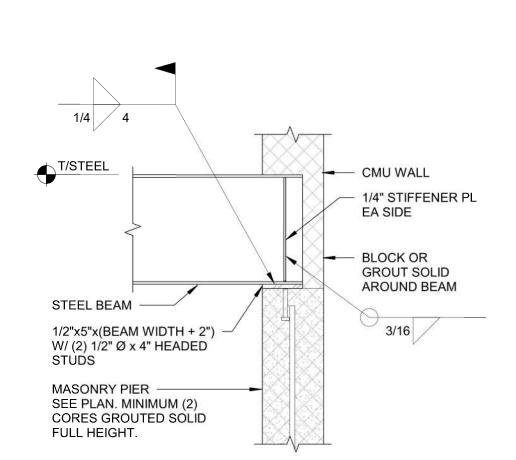

25' OC TYPICAL

12' MAX FROM CORNERS

STEEL BEAM BEARING DETAIL 8 S400 SCALE: NTS

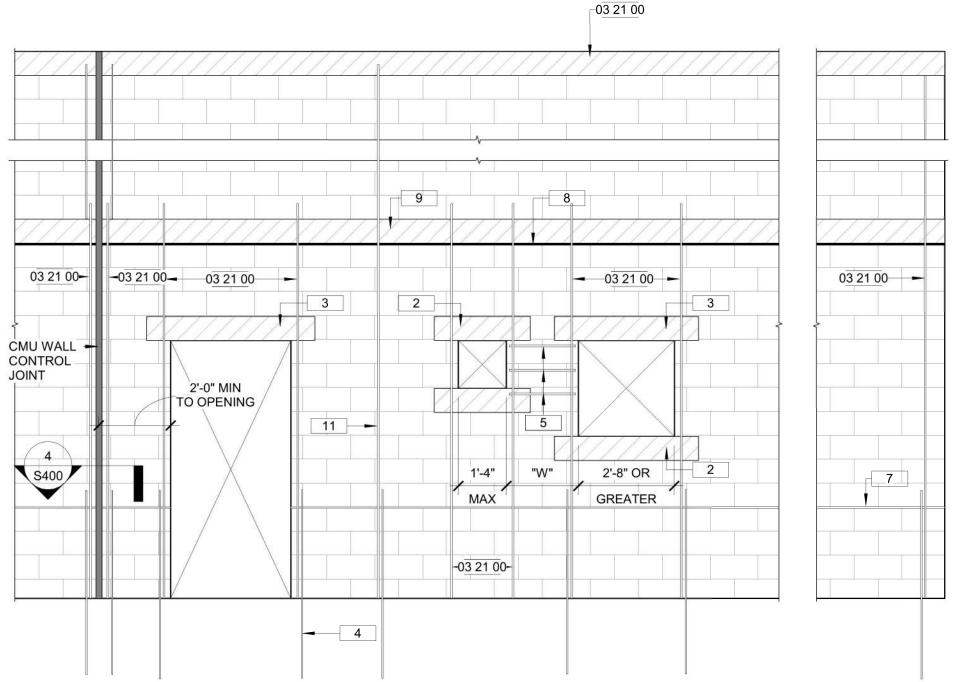

FULLY BONDED

INTERSECTION

CMU WALL

TYP CMU WALL REINFORCEMENT

LAP LENGTH

CMU WALL INTERSECTION

1/2" Ø x 4" HEADED STUD ANCHORS @ 32" OC AT OPENINGS

LARGER THAN 6'-0"

WASHER OVER LSL

FLANGE OF LINTEL

HOLES IN BOTT

STEEL LINTEL

B/STEEL SEE ARCH

BOTTOM PL

3/8"x7"x0'-7" PL W/ (2) 5/8" Ø

NUTS EA END IN STD

SOLID BELOW BEARING

GROUT (2) CELLS

LINTEL SCHEDULE

x 4" A36 THREADED ROD W/

CMU WALL

IN GROUTED CELL AT INTERSECTION

CORNER BAR SIZE &

SPACING TO MATCH


GROUT CELLS SOLID

AT REINFORCING

REINFORCING

BOND BEAM HORIZONTAL

JAMB REINFORCEMENT PER LINTEL SCHEDULE OR LINTEL DETAILS. MIN (1) #5 EA JAMB 2. 8" BOND BEAM W/ (1) #5 CONT 3. LINTEL, SEE SCHEDULE . DOWELS TO MATCH & LAP VERTICAL REINFORCEMENT. WHEN "W" IS LESS THAN 2'-0" AT 8" CMU WALL AND 3'-0" AT 12" CMU WALL ADD 1/4" CLOSED TIE SETS AT 8" OC. REINFORCE VERT CELLS AT END OF WALL AND ADJACENT TO CONTROL HORIZ JOINT REINFORCEMENT, SEE GENERAL NOTES. 8. ROOF OR FLOOR LINE BEYOND. 9. 8" BOND BEAM W/ (2) #4 CONT AT ROOF OR FLOOR LINE, UNO. 10. 8" BOND BEAM W/ (2) #4 CONT AT TOP OF WALL, UNO. 11. #5 @ 48" OC TYPICAL WALL REINFORCING, UNO,

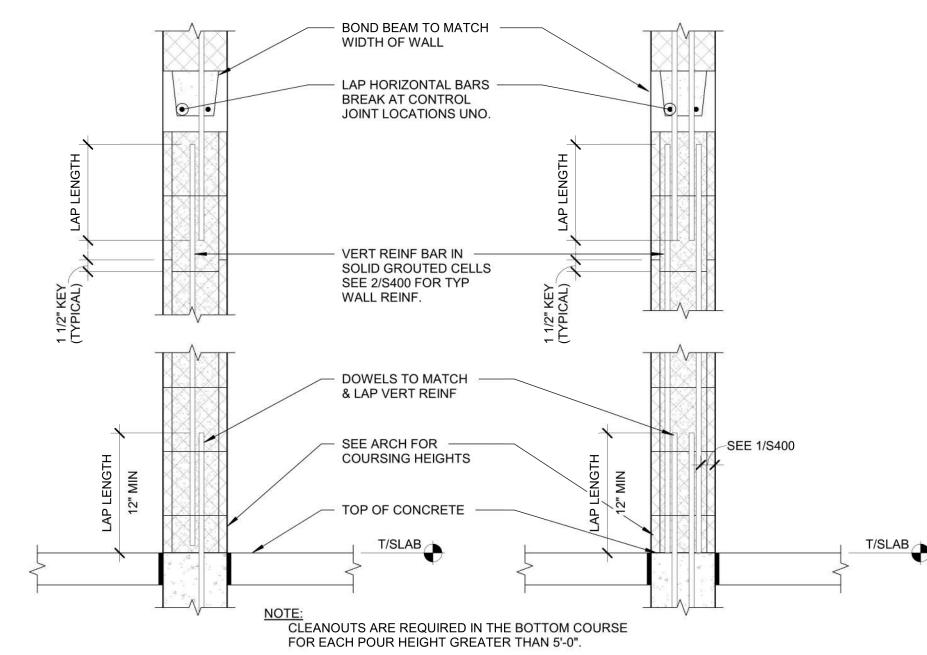

1 LAYER OF REINFORCING

2 LAYERS OF REINFORCING

TYPICAL REINFORCED CMU WALL

CONSTRUCTION DETAIL

3 S400

Forest Preserves of

Meridian Rd.,

Winnebago County, Illinois

Winnebago County

New Building

for

BLAKEMORE

ARCHITECTS

400 N. First Street Rockford, IL 61107

E: brian@blakemore-architects.com

blakemore-architects.com

815-227-0023

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REINF IN **GROUTED CELL** MATCH WALL JAMB REINF SEE SCHEDULE - EDGE OF **OPENING GROUT END CELL** SOLID CMU WALL




FULLY BONDED CMU WALL (3) VERTICAL REINF — IN GROUTED CELL AT INTERSECTION MATCH WALL REINF CORNER BAR SIZE & SPACING TO MATCH BOND BEAM HORIZONTAL REINFORCING **GROUT CELLS SOLID** AT REINFORCING — CMU WALL

LAP LENGTH




CMU WALL CORNER

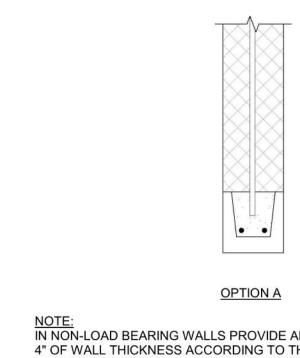


NOTE: IN NON-LOAD BEARING WALLS PROVIDE AND INSTALL ON LINTEL FOR EACH 4" OF WALL THICKNESS ACCORDING TO THE FOLLOWING: BEARING @ EA END 8" W/ (1) #4 8" W/ (1) #4 8" W/ (2) #4 8" W/ (2) #4 8" W/ (2) #4 8" W/ (2) #4

NON-LOAD BEARING LINTEL

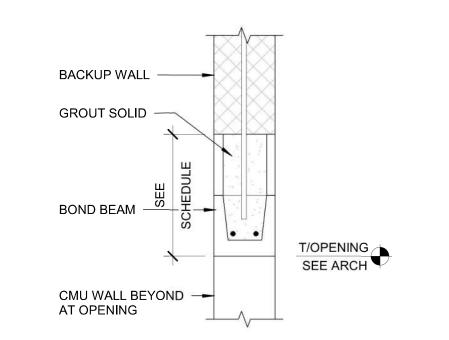



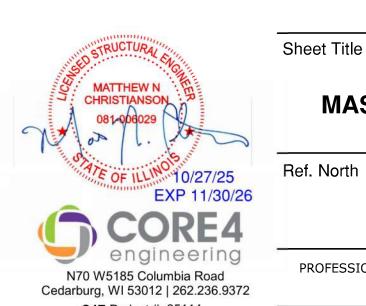

IL DESIGN FIRM 184-006824

MASONRY SECTIONS & DETAILS

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S400

BA Project No.

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Ref. North Sheet No.

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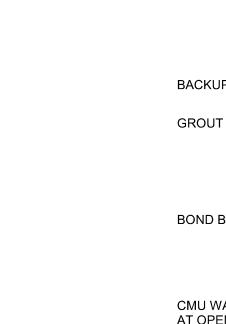
STEEL LINTEL BEARING DETAIL

1/4" STIFFENER PL


3/16


EA SIDE AT 16" DEEP

LINTELS & GREATER



A S400 SCALE: NTS

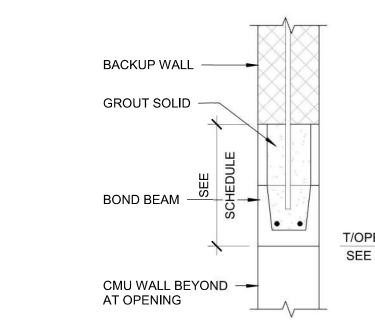


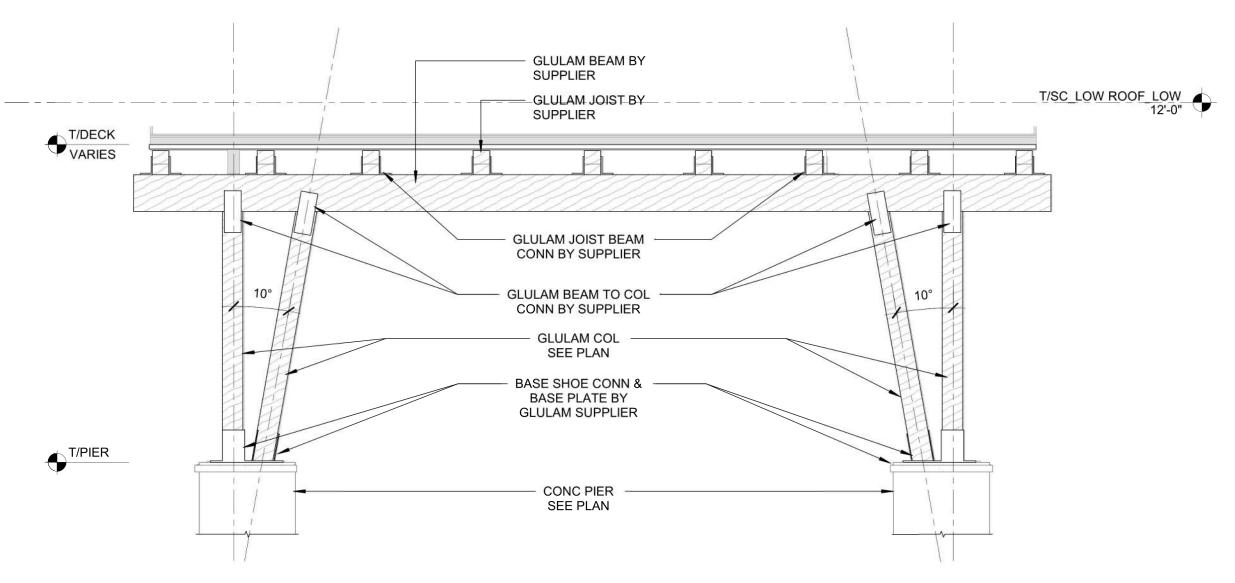


(1 S600)

ELEVATION VIEW


SCALE: 3/8" = 1'-0"

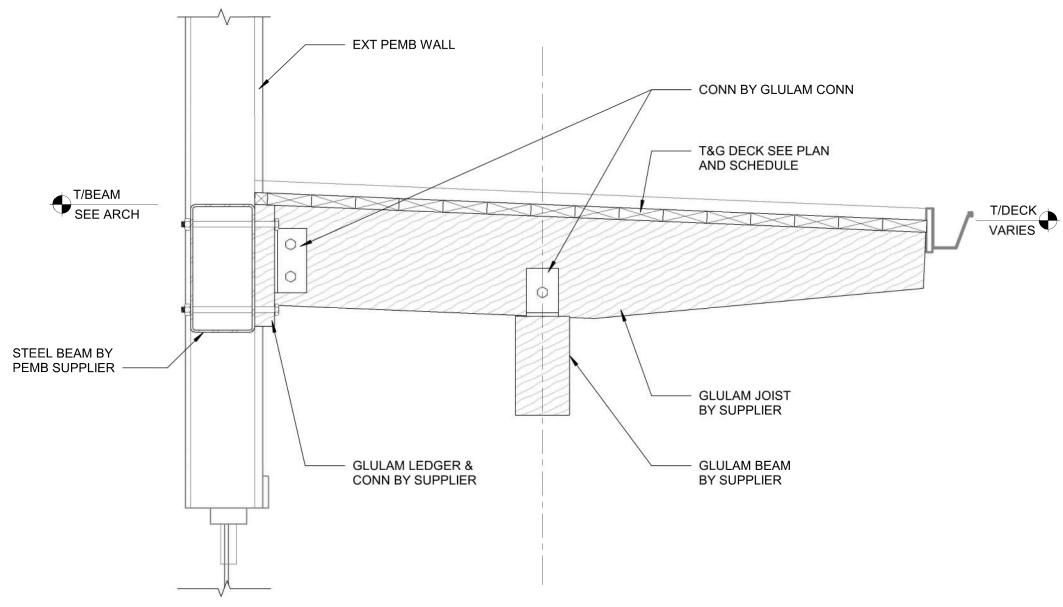




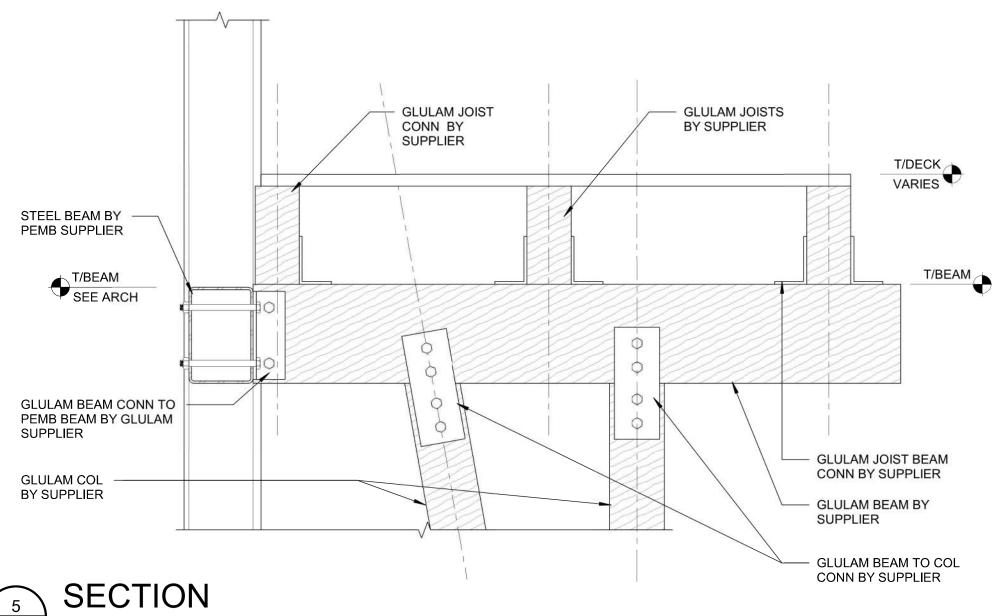




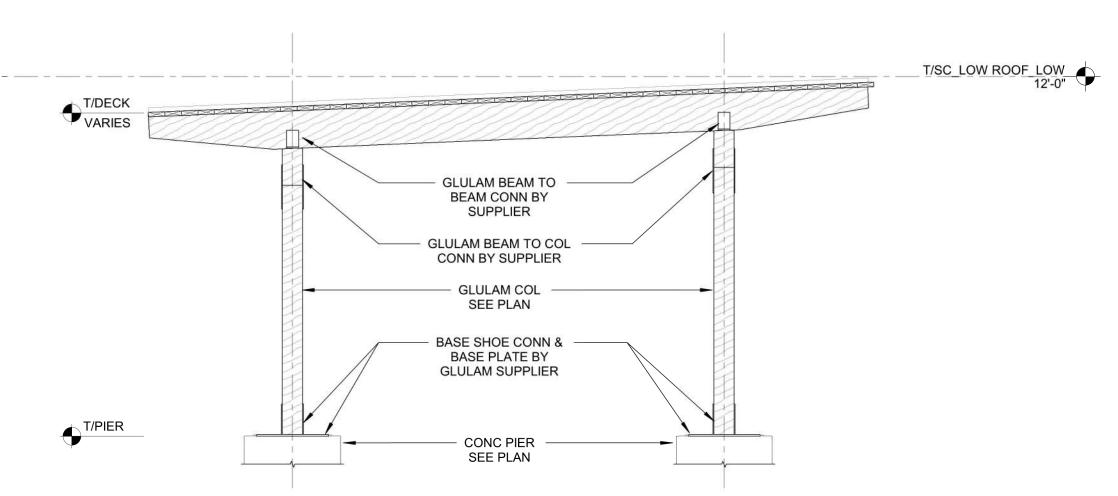



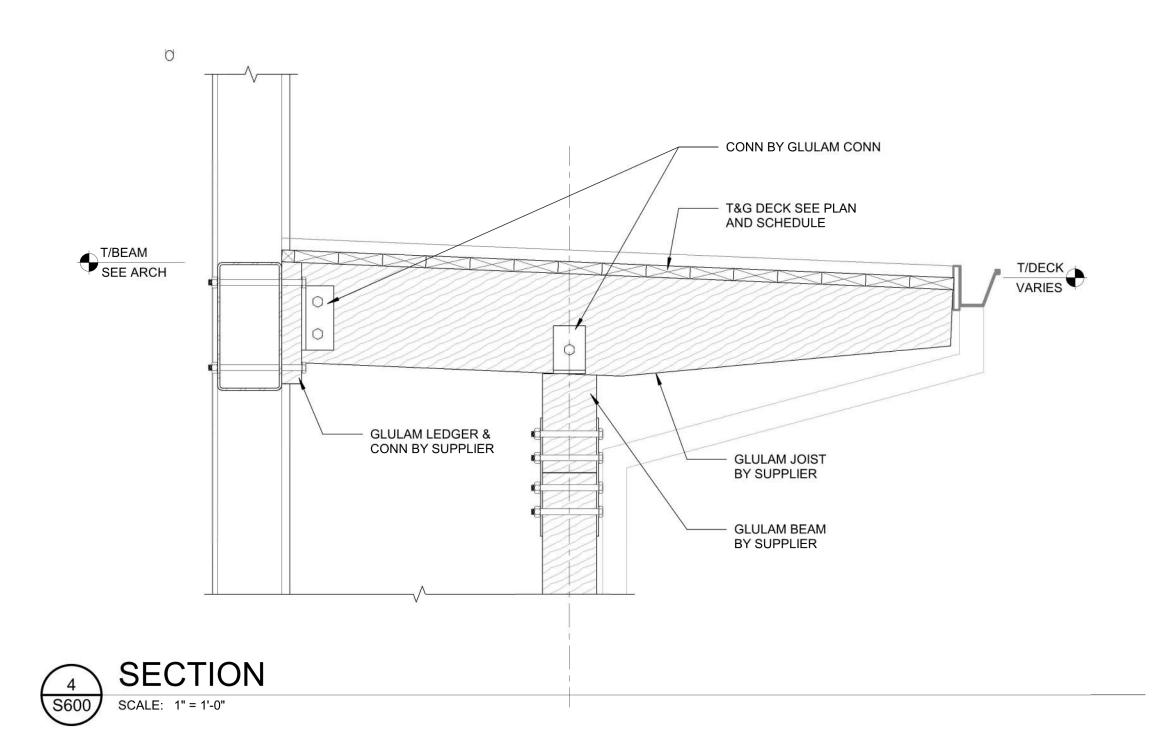

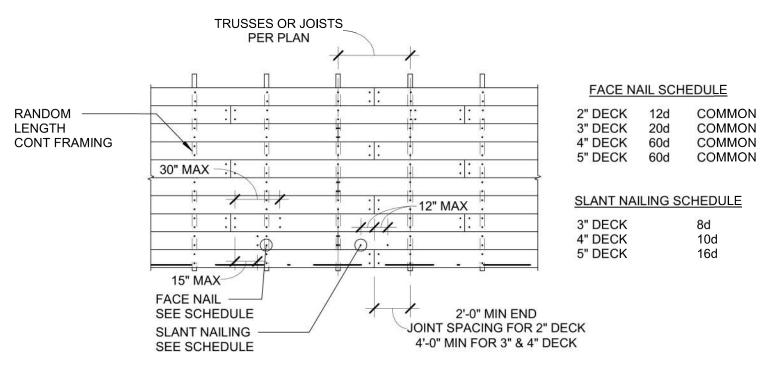

ARCHITECT/GC OPTION:
PROVIDE 1/2" OSB/PLYWOOD ON TOP OF DECK W/ 6d NAILS @ 10" OC ALL PANEL EDGES & 12" OC PANEL INTERIOR





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OF ILLIN 10/27/25 EXP 11/30/26

engineering

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WOOD SECTIONS, DETAILS, & ELEVATIONS

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Sheet No.

2025-09

S600

