WINNEBAGO COUNTY PUBLIC SAFETY BUILDING - ASBESTOS ABATEMENT PROJECT



DRAWING INDEX

General

Cover Sheet: G - 0 Project Information: G - 1

Flooring Materials Assessment

Basement Floor: ASB - 02
First Floor: ASB - 03
Second Floor: ASB - 04
Third Floor: ASB - 05
Fourth Floor: ASB - 06

Asbestos Containing Materials:

Basement Floor: ASB - 07
First Floor: ASB - 08
Second Floor: ASB - 09
Third Floor: ASB - 10
Fourth Floor: ASB - 11
Roof: ASB - 12



Brownfield Environmental Engineering Resources, LLC

645 Third Street - Suite 250 Beloit, Wisconsin 53511 Phone: 608-856-5434 www.brownfieldusa.com

Sheet No.

G - 0

Client:

WINNEBAGO COUNTY

Project Location:

420 W. STATE STREET ROCKFORD, IL 61101

Description:

COVER PAGE

K	e١	/IS	OK	ns

Number	Date	Rev. By

Drawn By:

BB, JB, GJ

| Date:

AUGUST 5, 2024

Project Number: 279-001

GENERAL NOTES:

The Contractor shall follow all applicable IEPA, IDPH, EPA, and OSHA rules and regulations. The Contractor shall secure the work areas with barriers and/or lock doors with sufficient signage to isolate the work area in order to prevent access by unauthorized personnel.

The owner will be responsible for removing all movable objects from rooms or locations where abatement is scheduled.

Exterior work area preparation shall be limited to the creation of a "regulated" area using signs and barrier tape and placing critical barriers over openings into the area. Upon completion of removal activities, the work area(s) shall be HEPA vacuumed and wet wiped to remove any residual materials that may exist.

The contractor shall be responsible for investigating all areas adjacent to the abatement work areas during tear down activities. If any debris of any kind is identified in any area adjacent to the abatement work area, the Contractor shall be responsible for the cleanup of that debris utilizing HEPA-vacuuming and wet methods.

PROJECT NOTES:

- 1. Water and electricity are available on each floor. It is the responsibility of the contractor to make electrical connections to existing facilities and coordinate with the owner.
- 2. Elevator Access/Weight Limit Specifics:
 - •Elevators 8 and 9 weight limit 2500.
 - Floors: Basement, 1st, 2nd, 3rd and 4th
 - •Elevator 10 weight limit 3500.
 - Floors: Basement, 1st and 2nd
 - •Elevator 11 weight limit 3500.
 - Floors: 1st floor rear access, 3rd and 4th
 - •Elevator 12 weight limit 3500. Prisoner elevator with dividing wall.
 - Floors: 1st ,2nd ,3rd and 4th
- 3. Locations of dumpsters and staging areas to be coordinated with the owner.
- 4. The drywall and joint compound systems have been sampled and tested and determined that as a "composite system" are less than 1% asbestos and can be considered a non-regulated asbestos containing material. The drywall joint compound as a stand-alone material contains more than 1% asbestos and should be treated as a regulated asbestos containing material.
- 5. Roofing materials have not been sampled or tested for asbestos.
- 6. Asbestos testing reports are available upon request.

ABATEMENT NOTES:

- The "First Mobilization" scope of work as noted in the project Bid Form is to include the removal of all asbestos and non-asbestos floor coverings, and asbestos containing mastic as noted on the plans. Asbestos containing mastic removal in the first mobilization may be completed by chemical removal or grinding methods.
- 2. The "Second Mobilization" scope of work is to be performed after the demolition of existing non-loadbearing walls has been completed and is to include the removal/abatement of any floor tile under the walls, existing floor leveling materials, and a final grind of all flooring surfaces to remove floor tile residue and leveling compound.
- 3. Floor grinding is to be completed by wet methods in a full negative air containment by licensed abatement workers. All ground material is to be disposed of as asbestos containing waste. Floors should be ground to a smooth finish free of major gouges and inconsistencies.
- 4. The location and extent of floor leveling materials is unknown and is not referenced on the plans. The contractor should assume leveling materials are present and are to be removed as part of the base bid scope of work.
- 5. Abatement of asbestos containing floor tile and mastic in the elevators is included with the first mobilization scope of work on the 4th floor. Mastic in the elevators can be abated with chemical methods and no grinding will be required.
- 6. All ACBM may be temporarily stored at the work area until completion of the abatement project. Temporarily stored ACBM shall meet the waste storage requirements of NESHAP regulations at 40 CFR 61, Subpart M. At the conclusion of the abatement project, all temporarily stored ACBM shall be removed from the work area and transported to a regulated landfill location approved for disposal of asbestos-containing waste.
- 7. The owner will provide air clearance monitoring as referenced in IL Administrative Code, Title 77, Section 855.220, d).



Brownfield Environmental Engineering Resources, LLC 645 Third Street - Suite 250

Beloit, Wisconsin 53511 Phone: 608-856-5434 www.brownfieldusa.com

Sheet No.

G - 1

Client:

WINNEBAGO COUNTY

Project Location:

420 W. STATE STREET ROCKFORD, IL 61101

Description:

PROJECT NOTES

Revisions

Number	Date	Rev. By
Drouge Br		

Drawn By:


BB, JB, GJ

Date:

AUGUST 5, 2024


Project Number:

279-001

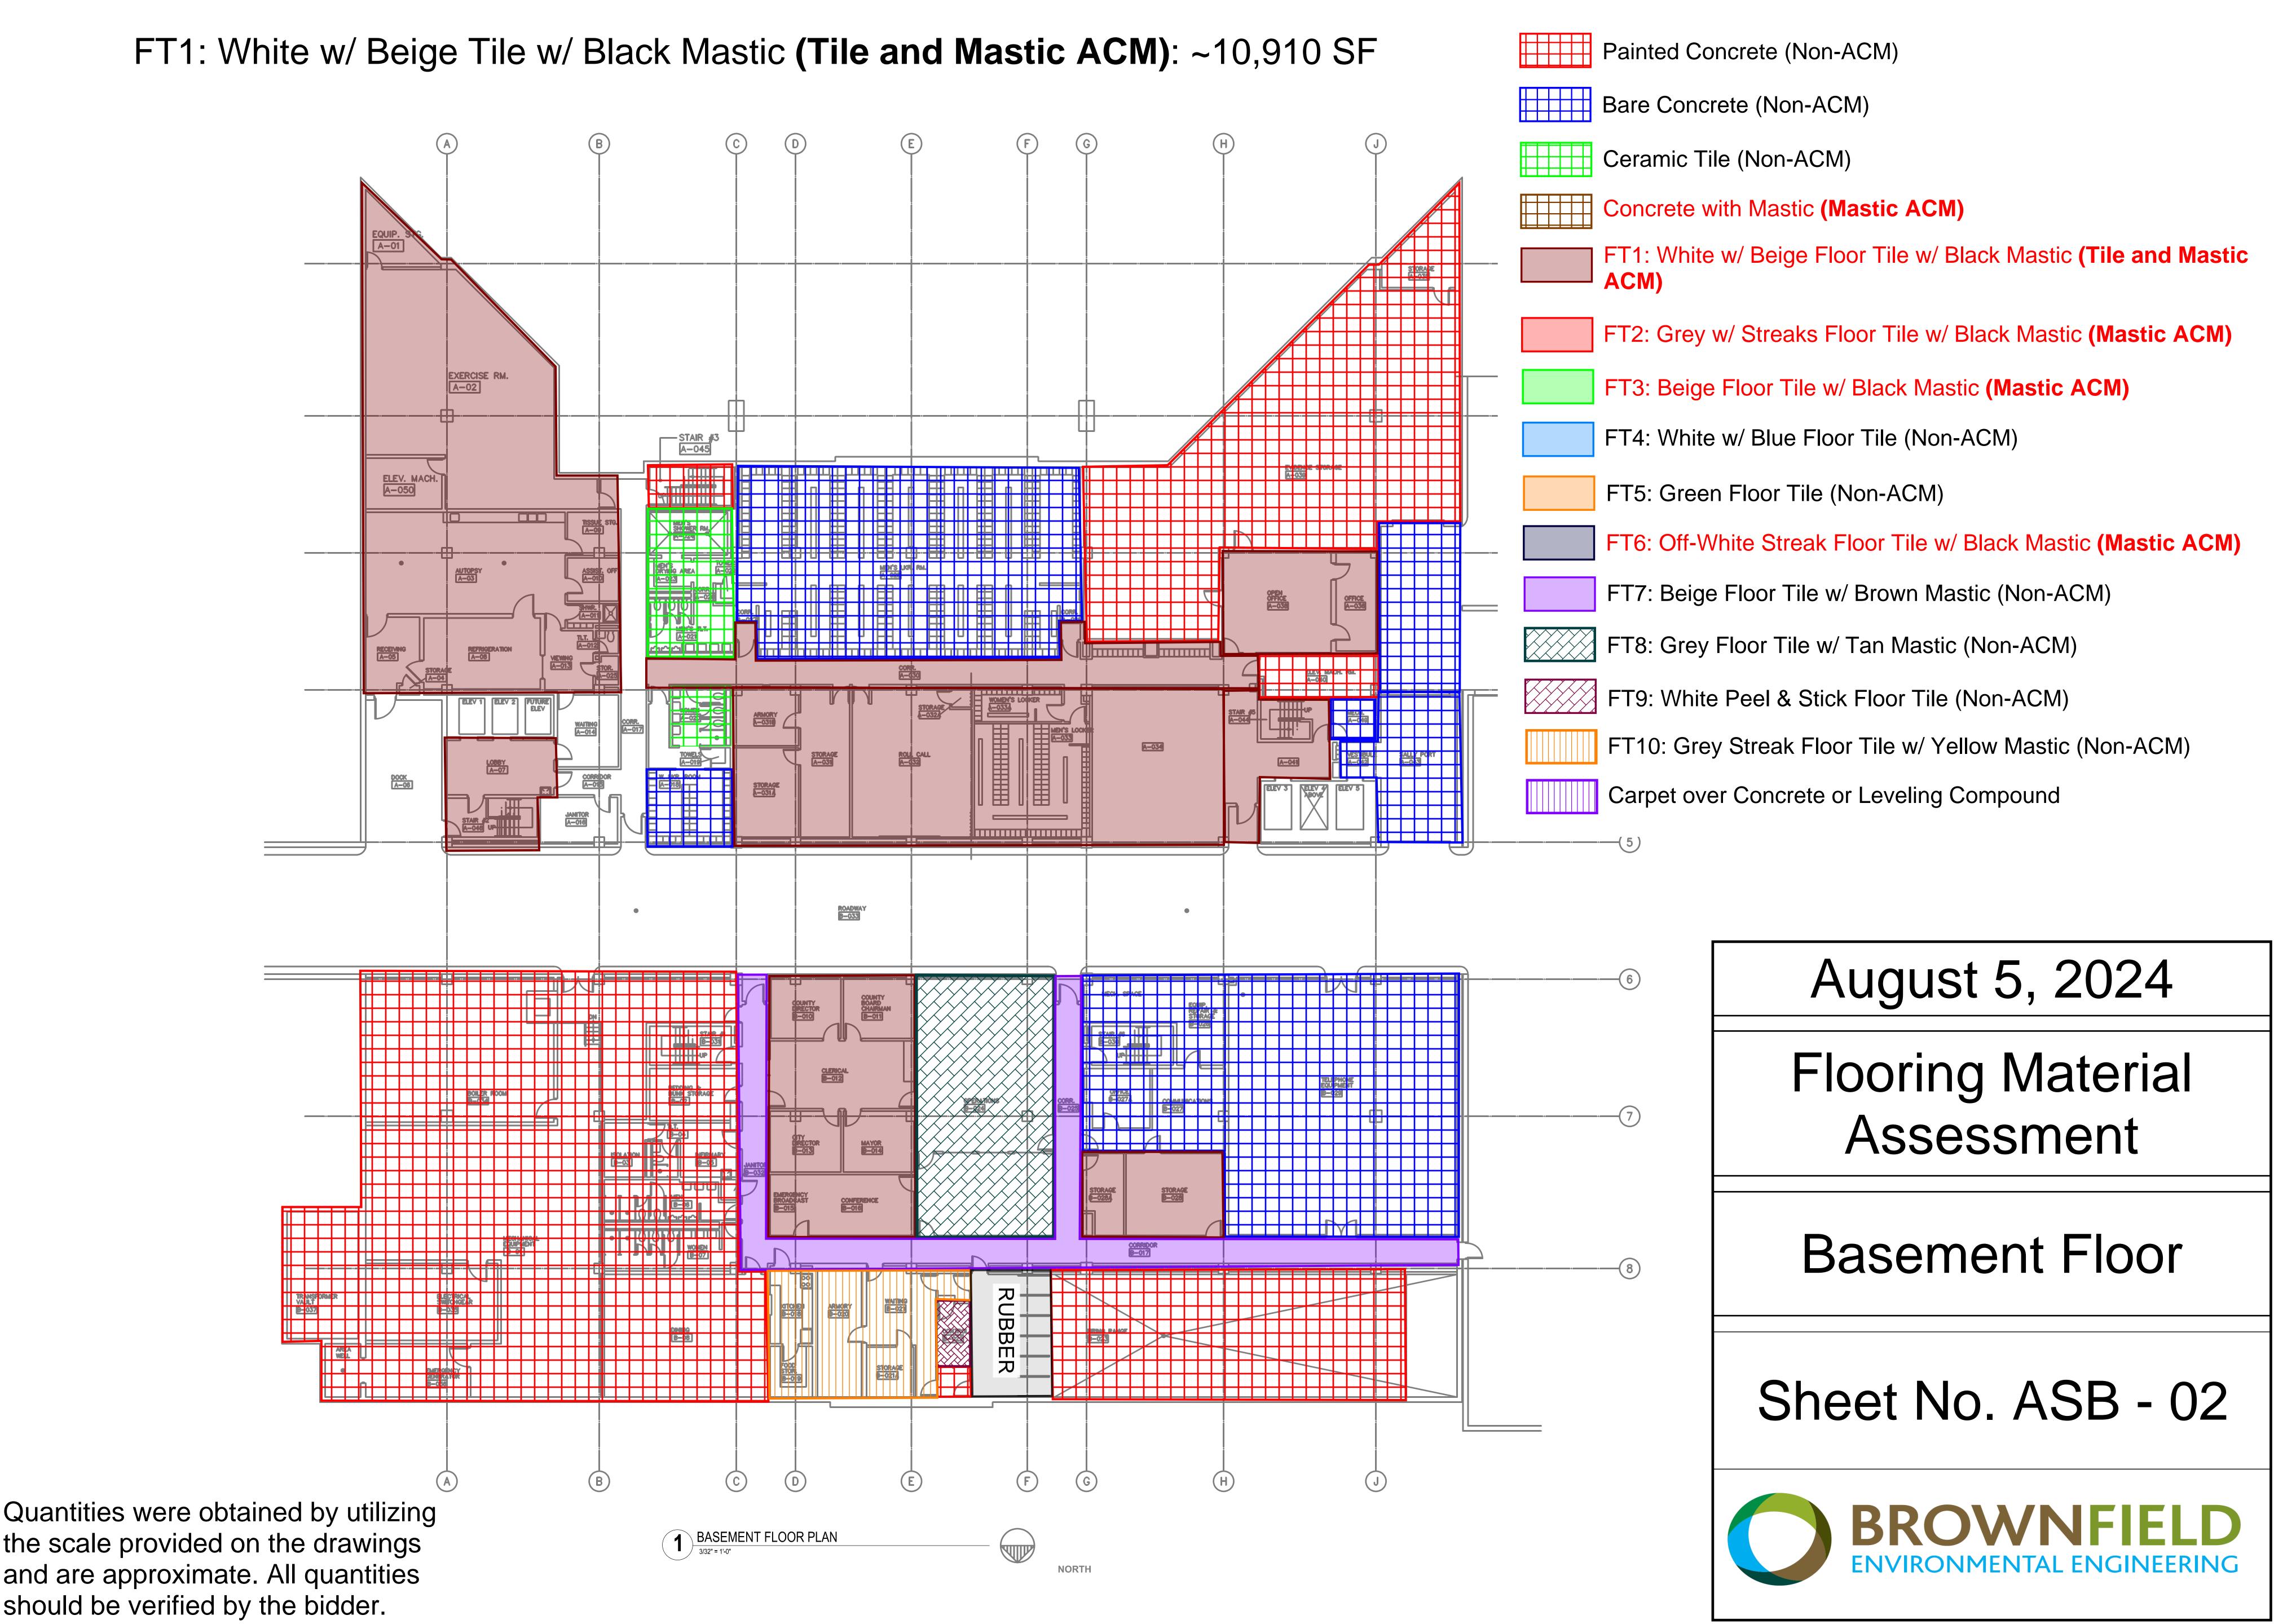

Painted Concrete (Non-ACM) FT1: White w/ Beige Tile w/ Black Mastic (Tile and Mastic ACM): ~8,515 SF Bare Concrete (Non-ACM) Carpet over Concrete w/ Black Mastic (Mastic ACM): ~900 SF Ceramic Tile (Non-ACM) Concrete with Mastic (Mastic ACM) FT1: White w/ Beige Floor Tile w/ Black Mastic (Tile and Mastic FT2: Grey w/ Streaks Floor Tile w/ Black Mastic (Mastic ACM) FT3: Beige Floor Tile w/ Black Mastic (Mastic ACM) FT4: White w/ Blue Floor Tile (Non-ACM) CR MEYSIS FT5: Green Floor Tile (Non-ACM) FT6: Off-White Streak Floor Tile w/ Black Mastic (Mastic ACM) FT7: Beige Floor Tile w/ Brown Mastic (Non-ACM) FIREARM TESTING FT8: Grey Floor Tile w/ Tan Mastic (Non-ACM) BRICK PATTERN MECHANICAL CHAS FT9: White Peel & Stick Floor Tile (Non-ACM) MECHANICAL CHA FT10: Grey Streak Floor Tile w/ Yellow Mastic (Non-ACM) Carpet over Concrete or Leveling Compound BLACK = MASTIC BRICK PATTERN August 5, 2024 Flooring Material Assessment First Floor BRICK PATTERN Sheet No. ASB - 03 Quantities were obtained by utilizing 1 FIRST FLOOR PLAN
3/32" = 1'-0"

the scale provided on the drawings and are approximate. All quantities should be verified by the bidder.

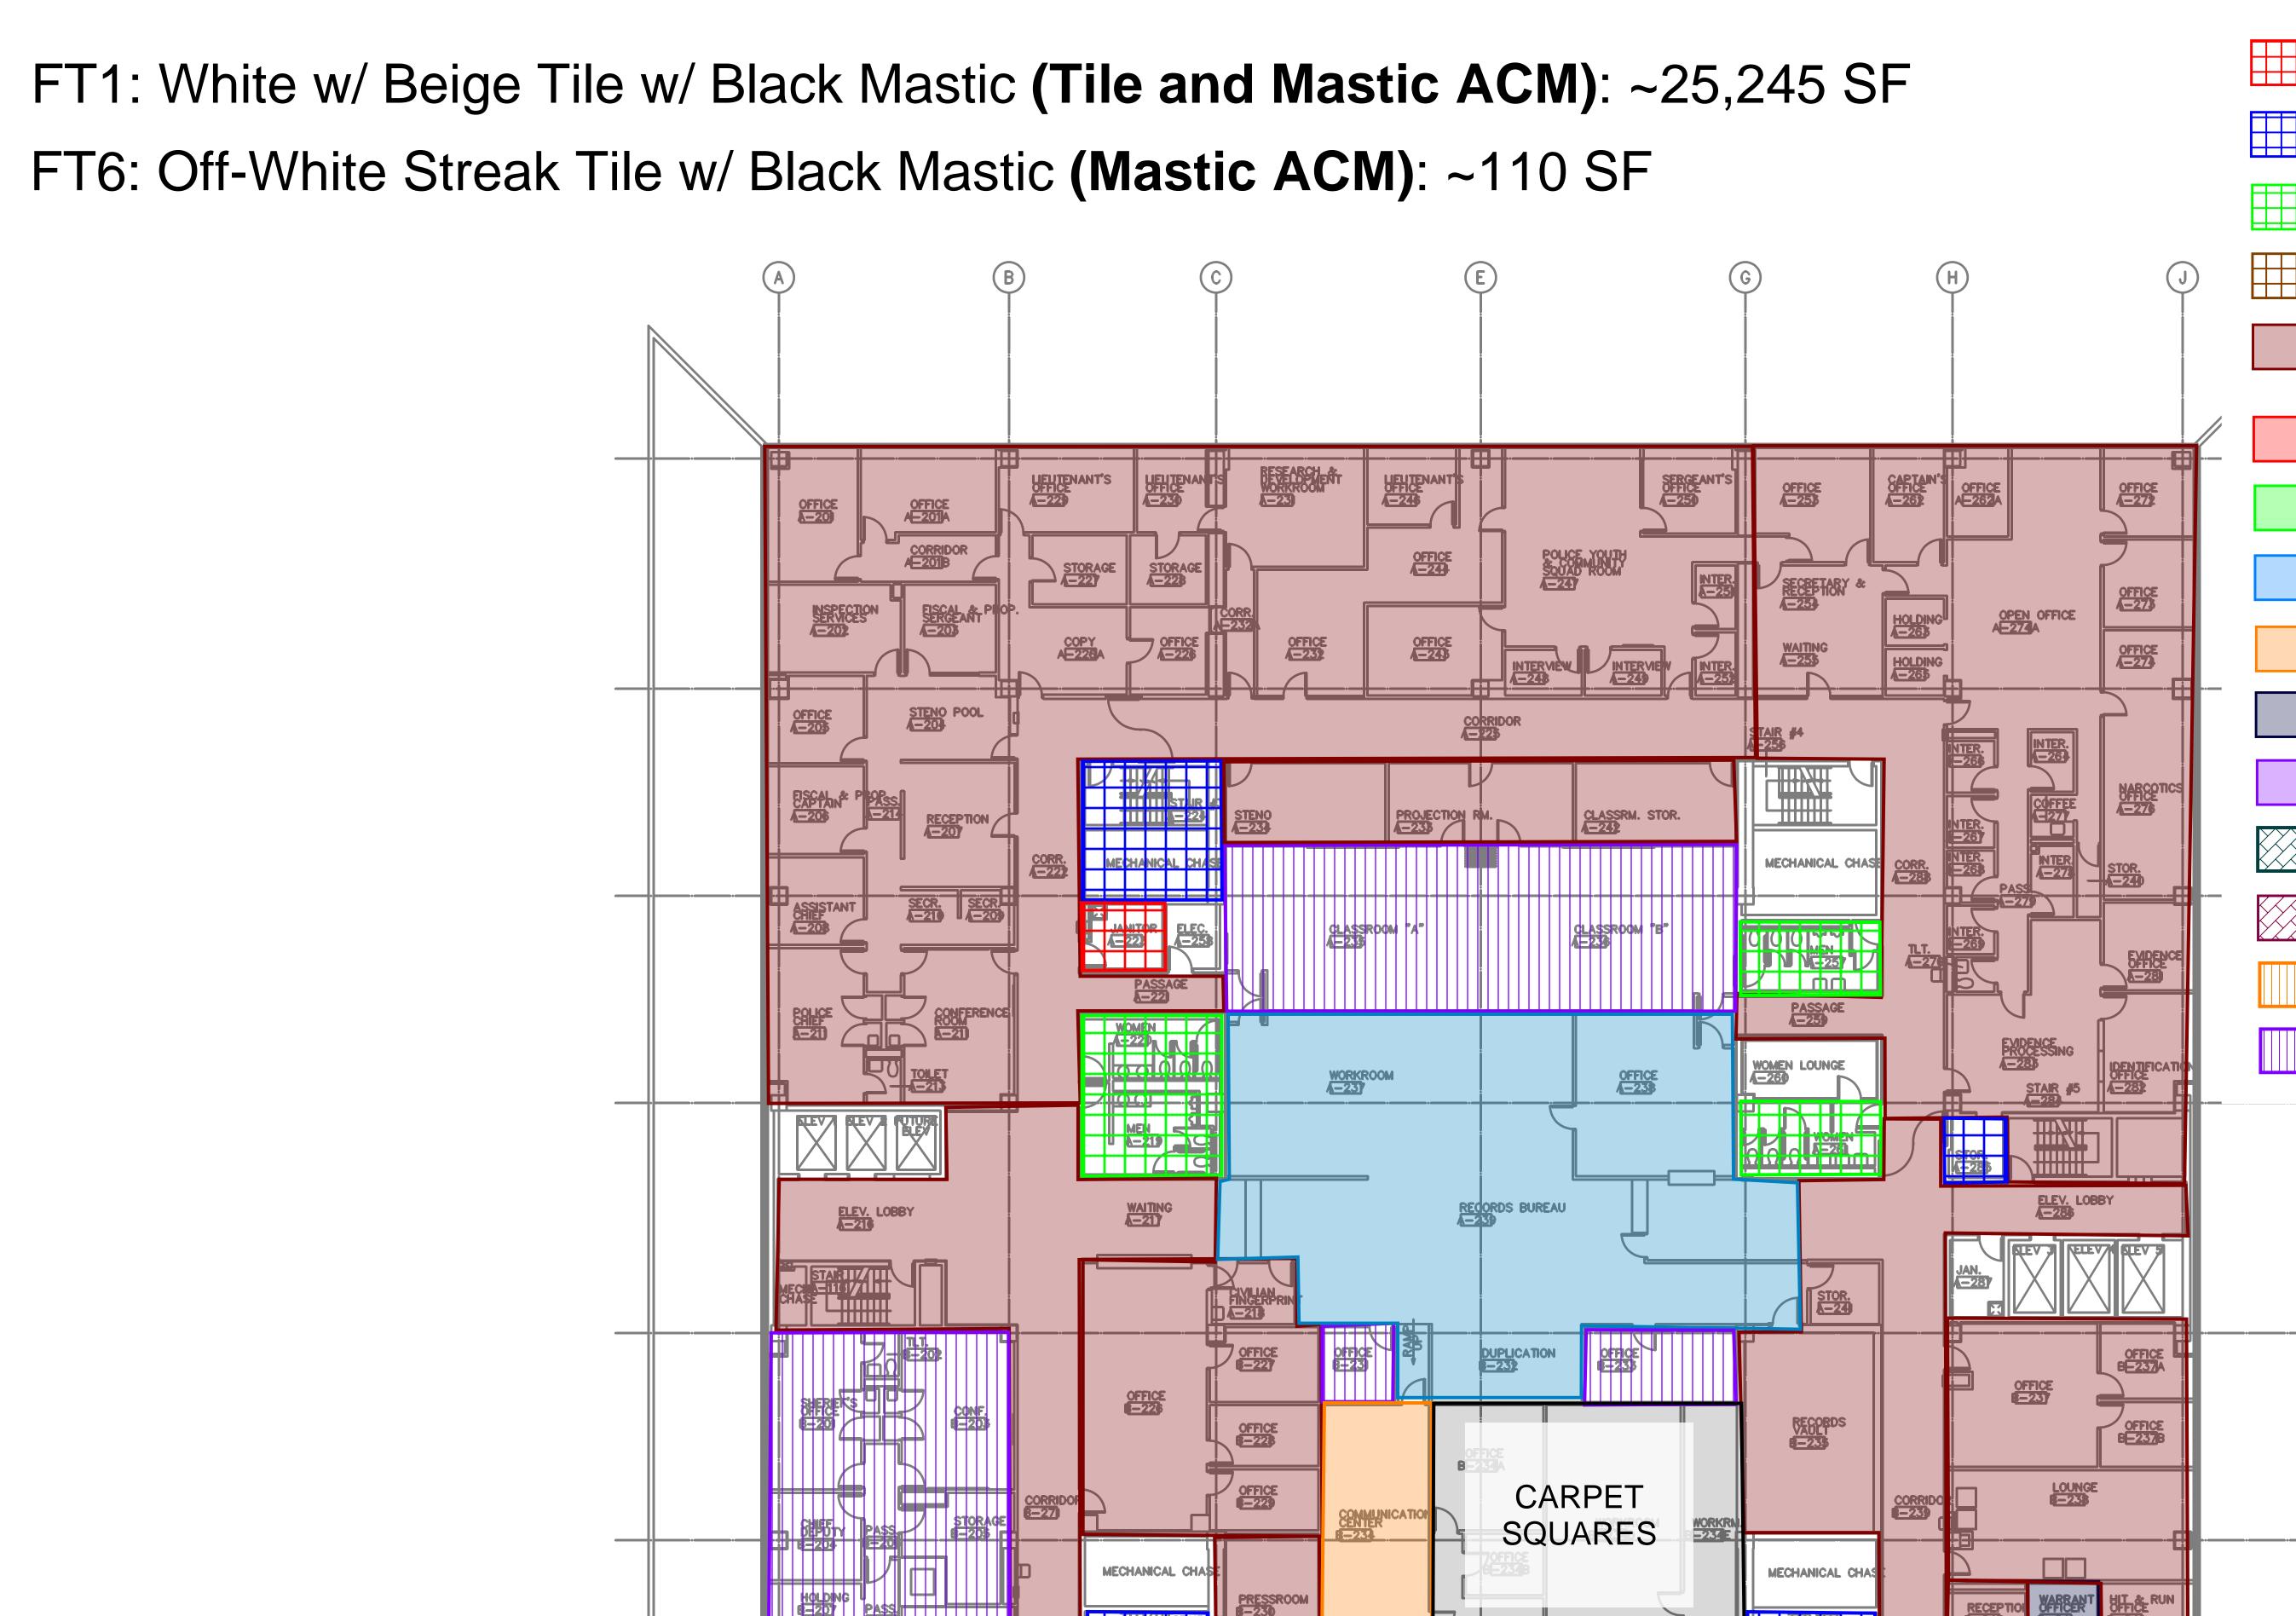

Painted Concrete (Non-ACM)

Bare Concrete (Non-ACM)

Ceramic Tile (Non-ACM)

Concrete with Mastic (Mastic ACM)

FT1: White w/ Beige Floor Tile w/ Black Mastic (Tile and Mastic ACM)

FT3: Beige Floor Tile w/ Black Mastic (Mastic ACM)

FT4: White w/ Blue Floor Tile (Non-ACM)

FT5: Green Floor Tile (Non-ACM)

FT6: Off-White Streak Floor Tile w/ Black Mastic (Mastic ACM)

FT2: Grey w/ Streaks Floor Tile w/ Black Mastic (Mastic ACM)

FT7: Beige Floor Tile w/ Brown Mastic (Non-ACM)

FT8: Grey Floor Tile w/ Tan Mastic (Non-ACM)

FT9: White Peel & Stick Floor Tile (Non-ACM)

SQUAD ROOM!C

FT10: Grey Streak Floor Tile w/ Yellow Mastic (Non-ACM)

Carpet over Concrete or Leveling Compound

August 5, 2024


Flooring Material Assessment

Second Floor


Sheet No. ASB - 04




Quantities were obtained by utilizing the scale provided on the drawings and are approximate. All quantities should be verified by the bidder.

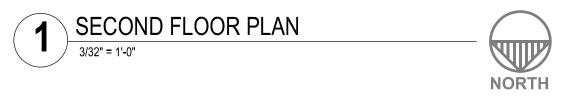

SERGEANT'S OFFICE 1-266

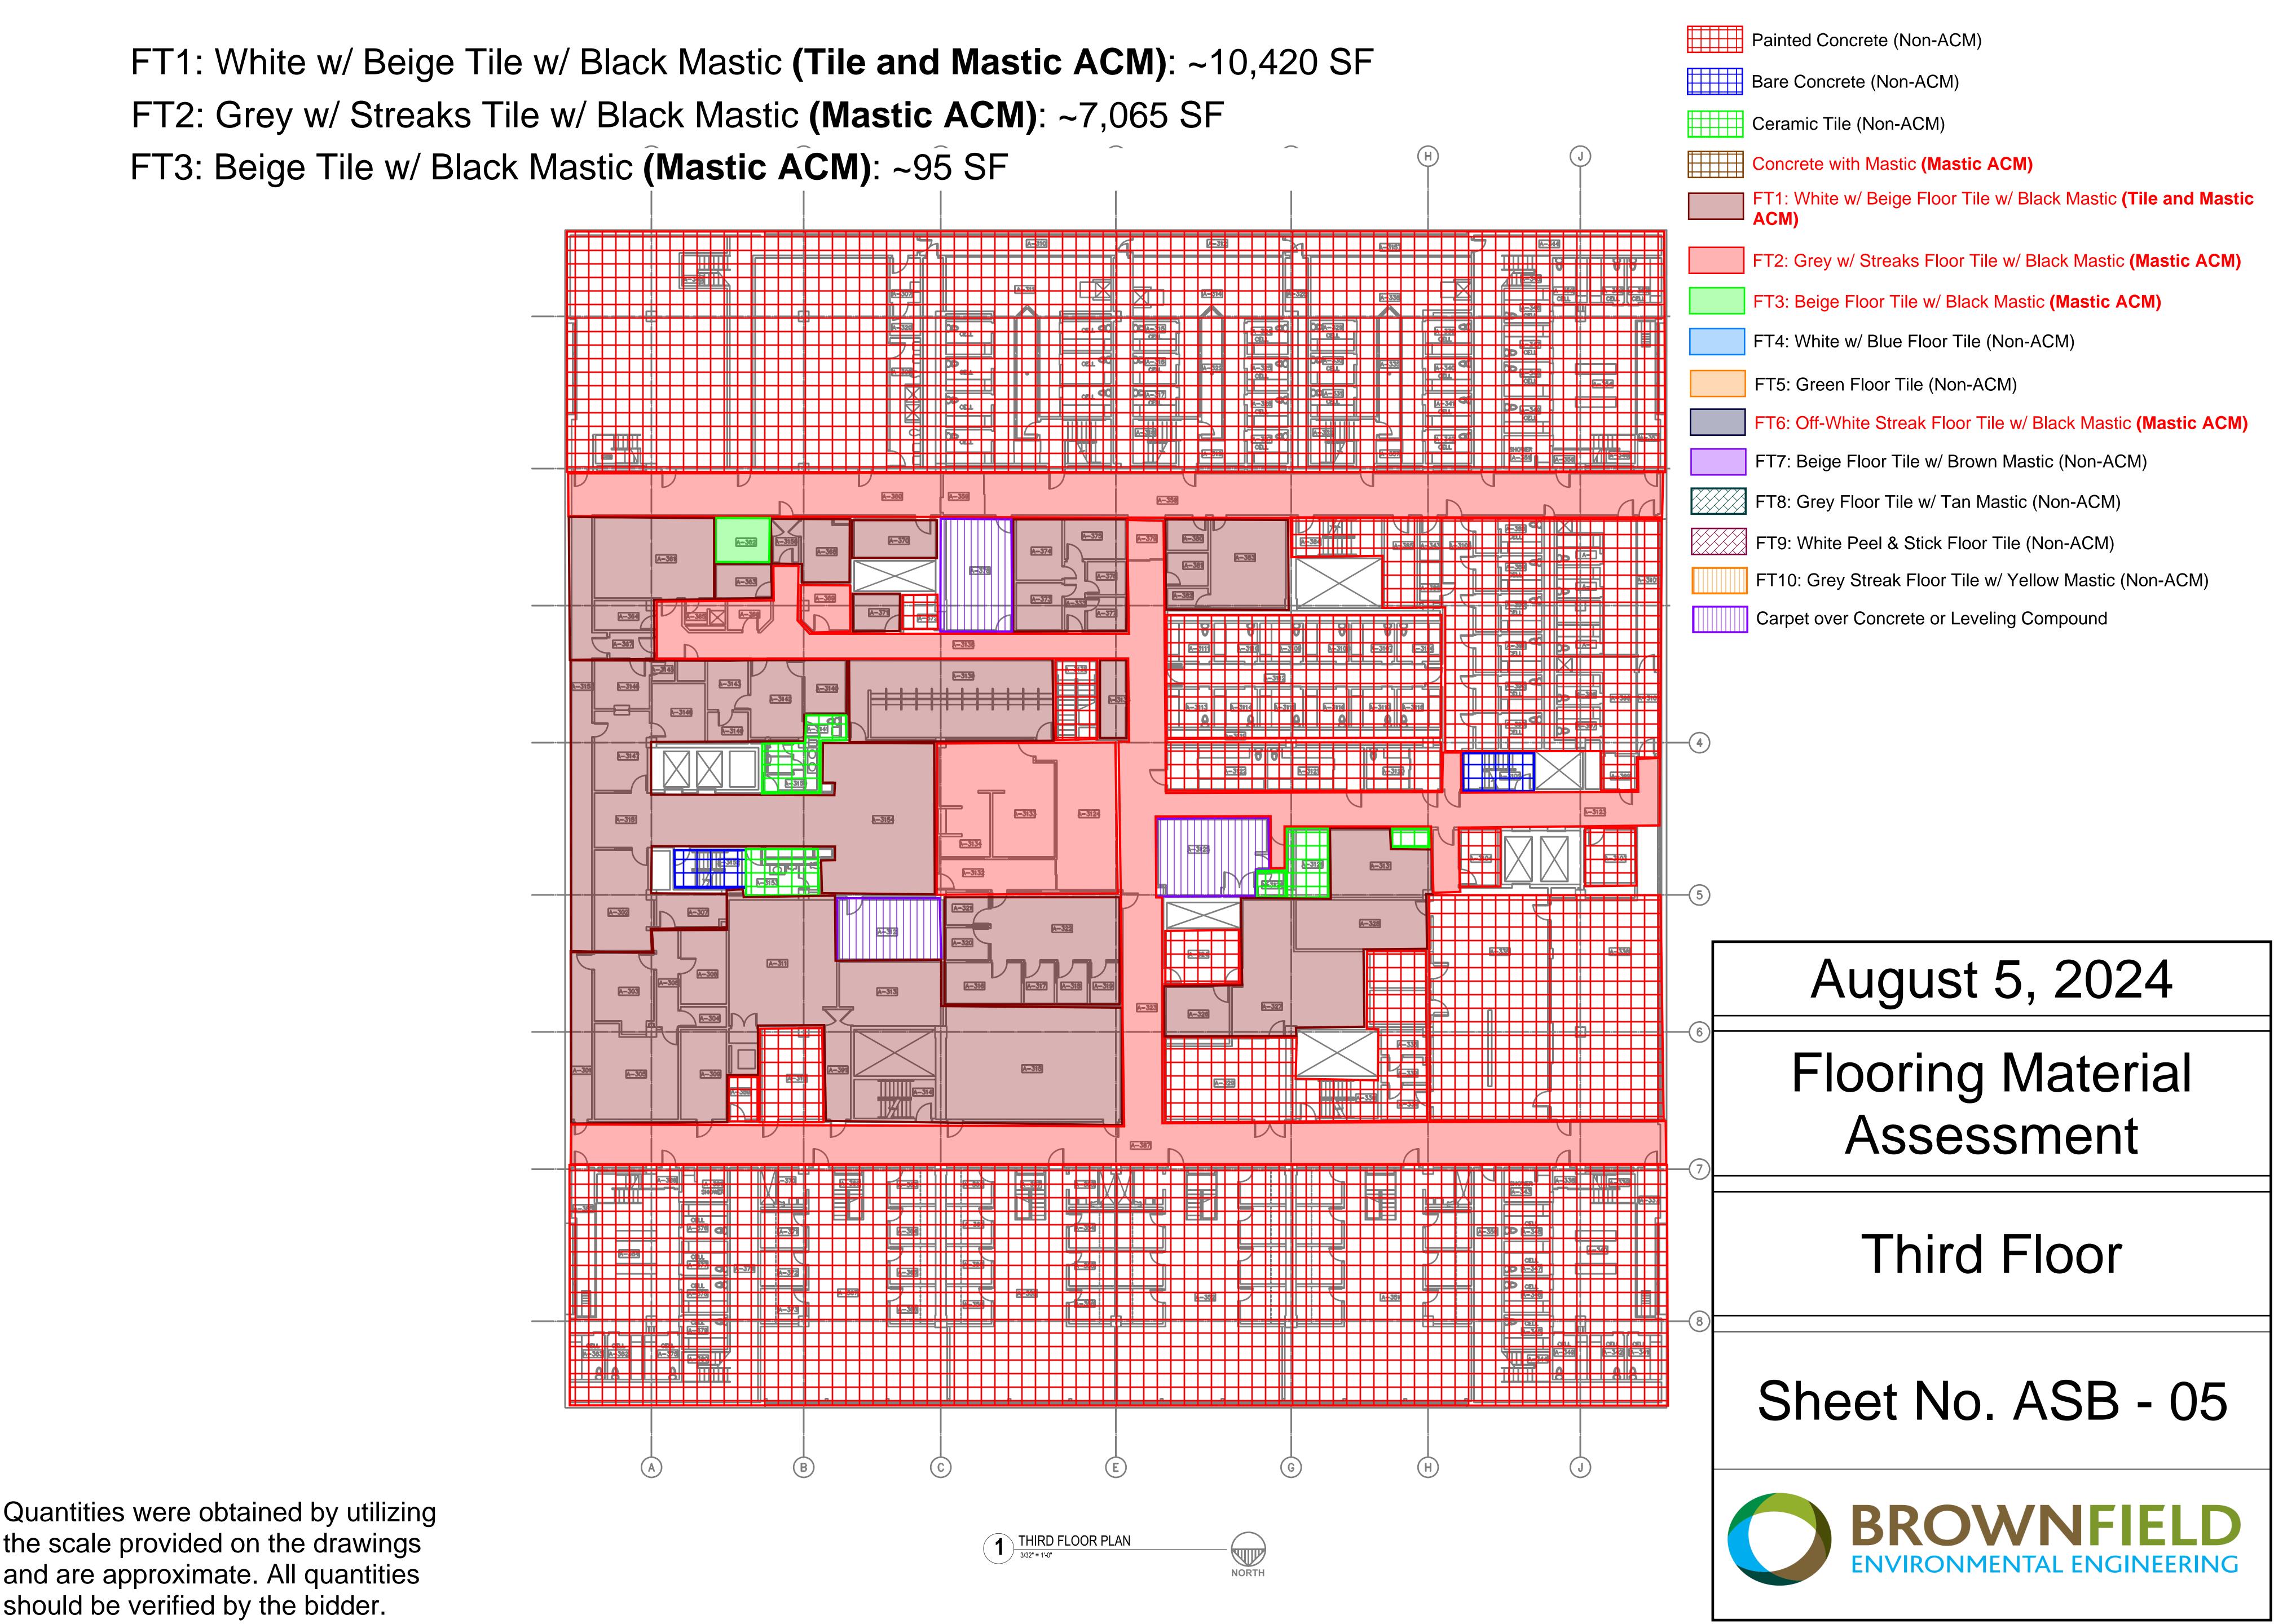

Concrete w/ Mastic (Mastic ACM): ~5,270 SF

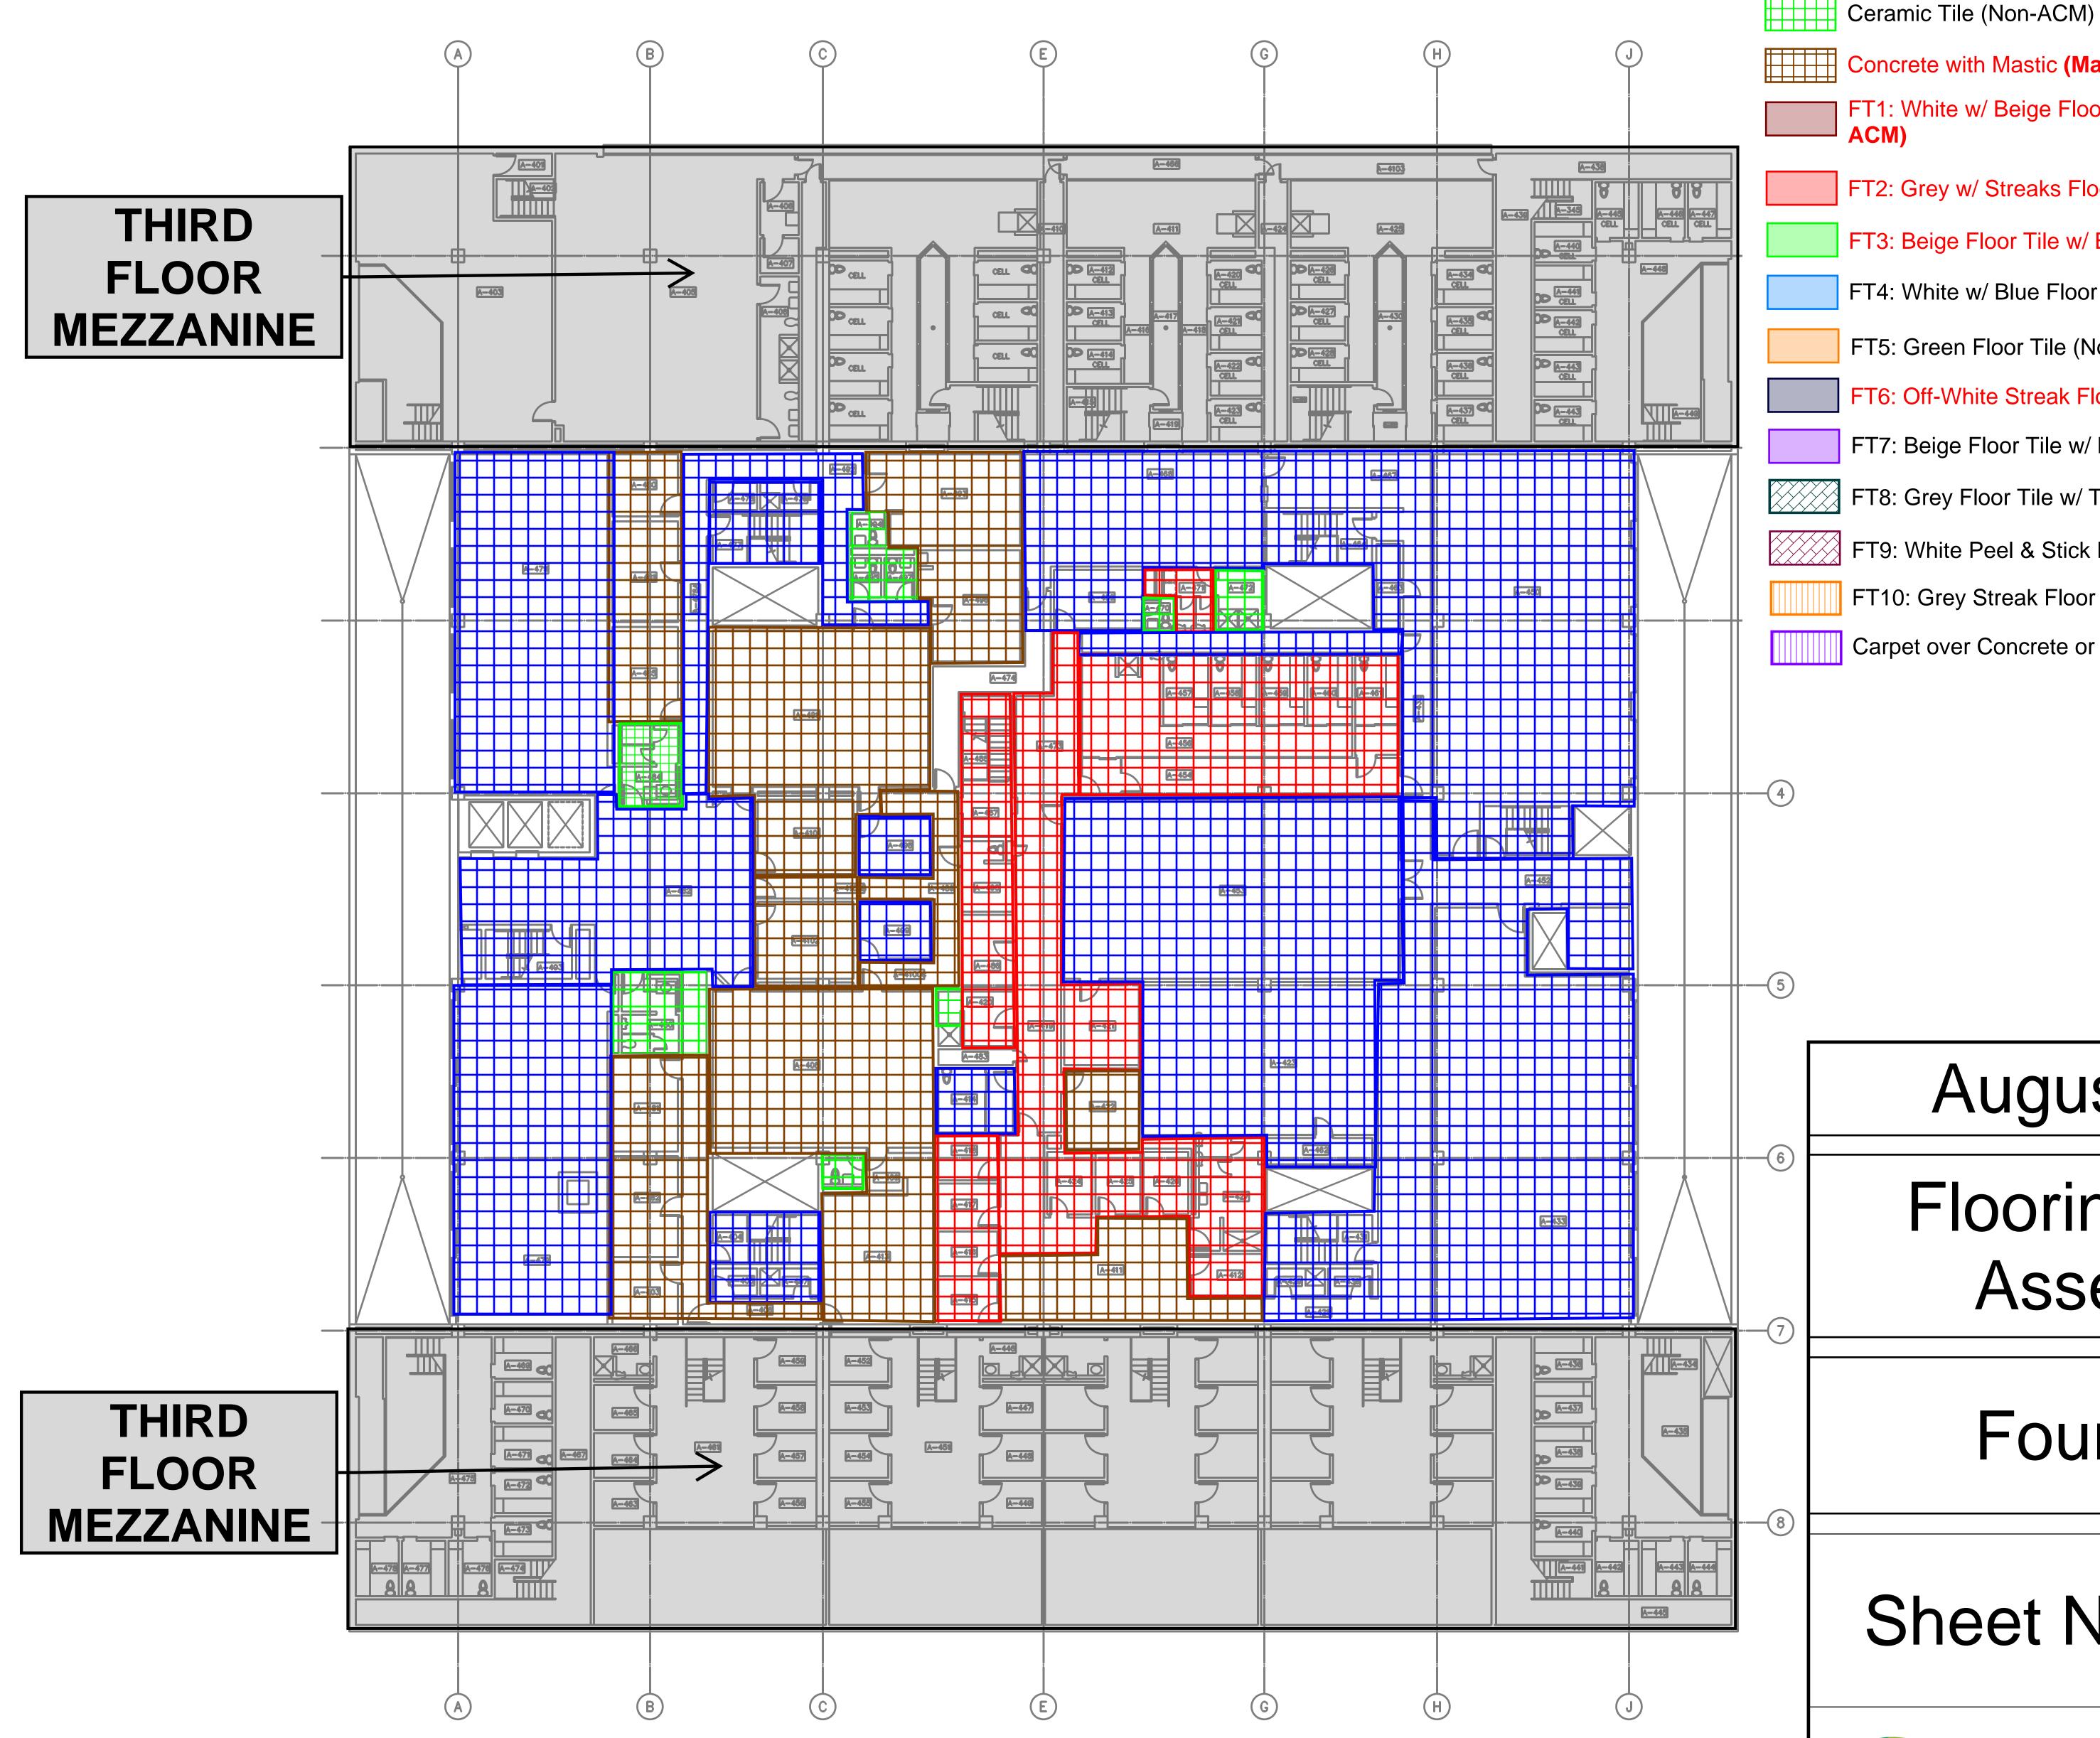

1 FOURTH FLOOR PLAN
3/32" = 1'-0"

August 5, 2024

Painted Concrete (Non-ACM)

Concrete with Mastic (Mastic ACM)

FT1: White w/ Beige Floor Tile w/ Black Mastic (Tile and Mastic

FT2: Grey w/ Streaks Floor Tile w/ Black Mastic (Mastic ACM)

FT6: Off-White Streak Floor Tile w/ Black Mastic (Mastic ACM)

FT10: Grey Streak Floor Tile w/ Yellow Mastic (Non-ACM)

FT3: Beige Floor Tile w/ Black Mastic (Mastic ACM)

FT7: Beige Floor Tile w/ Brown Mastic (Non-ACM)

FT8: Grey Floor Tile w/ Tan Mastic (Non-ACM)

FT9: White Peel & Stick Floor Tile (Non-ACM)

Carpet over Concrete or Leveling Compound

FT4: White w/ Blue Floor Tile (Non-ACM)

FT5: Green Floor Tile (Non-ACM)

Bare Concrete (Non-ACM)


ACM)


Flooring Material Assessment

Fourth Floor

Sheet No. ASB - 06




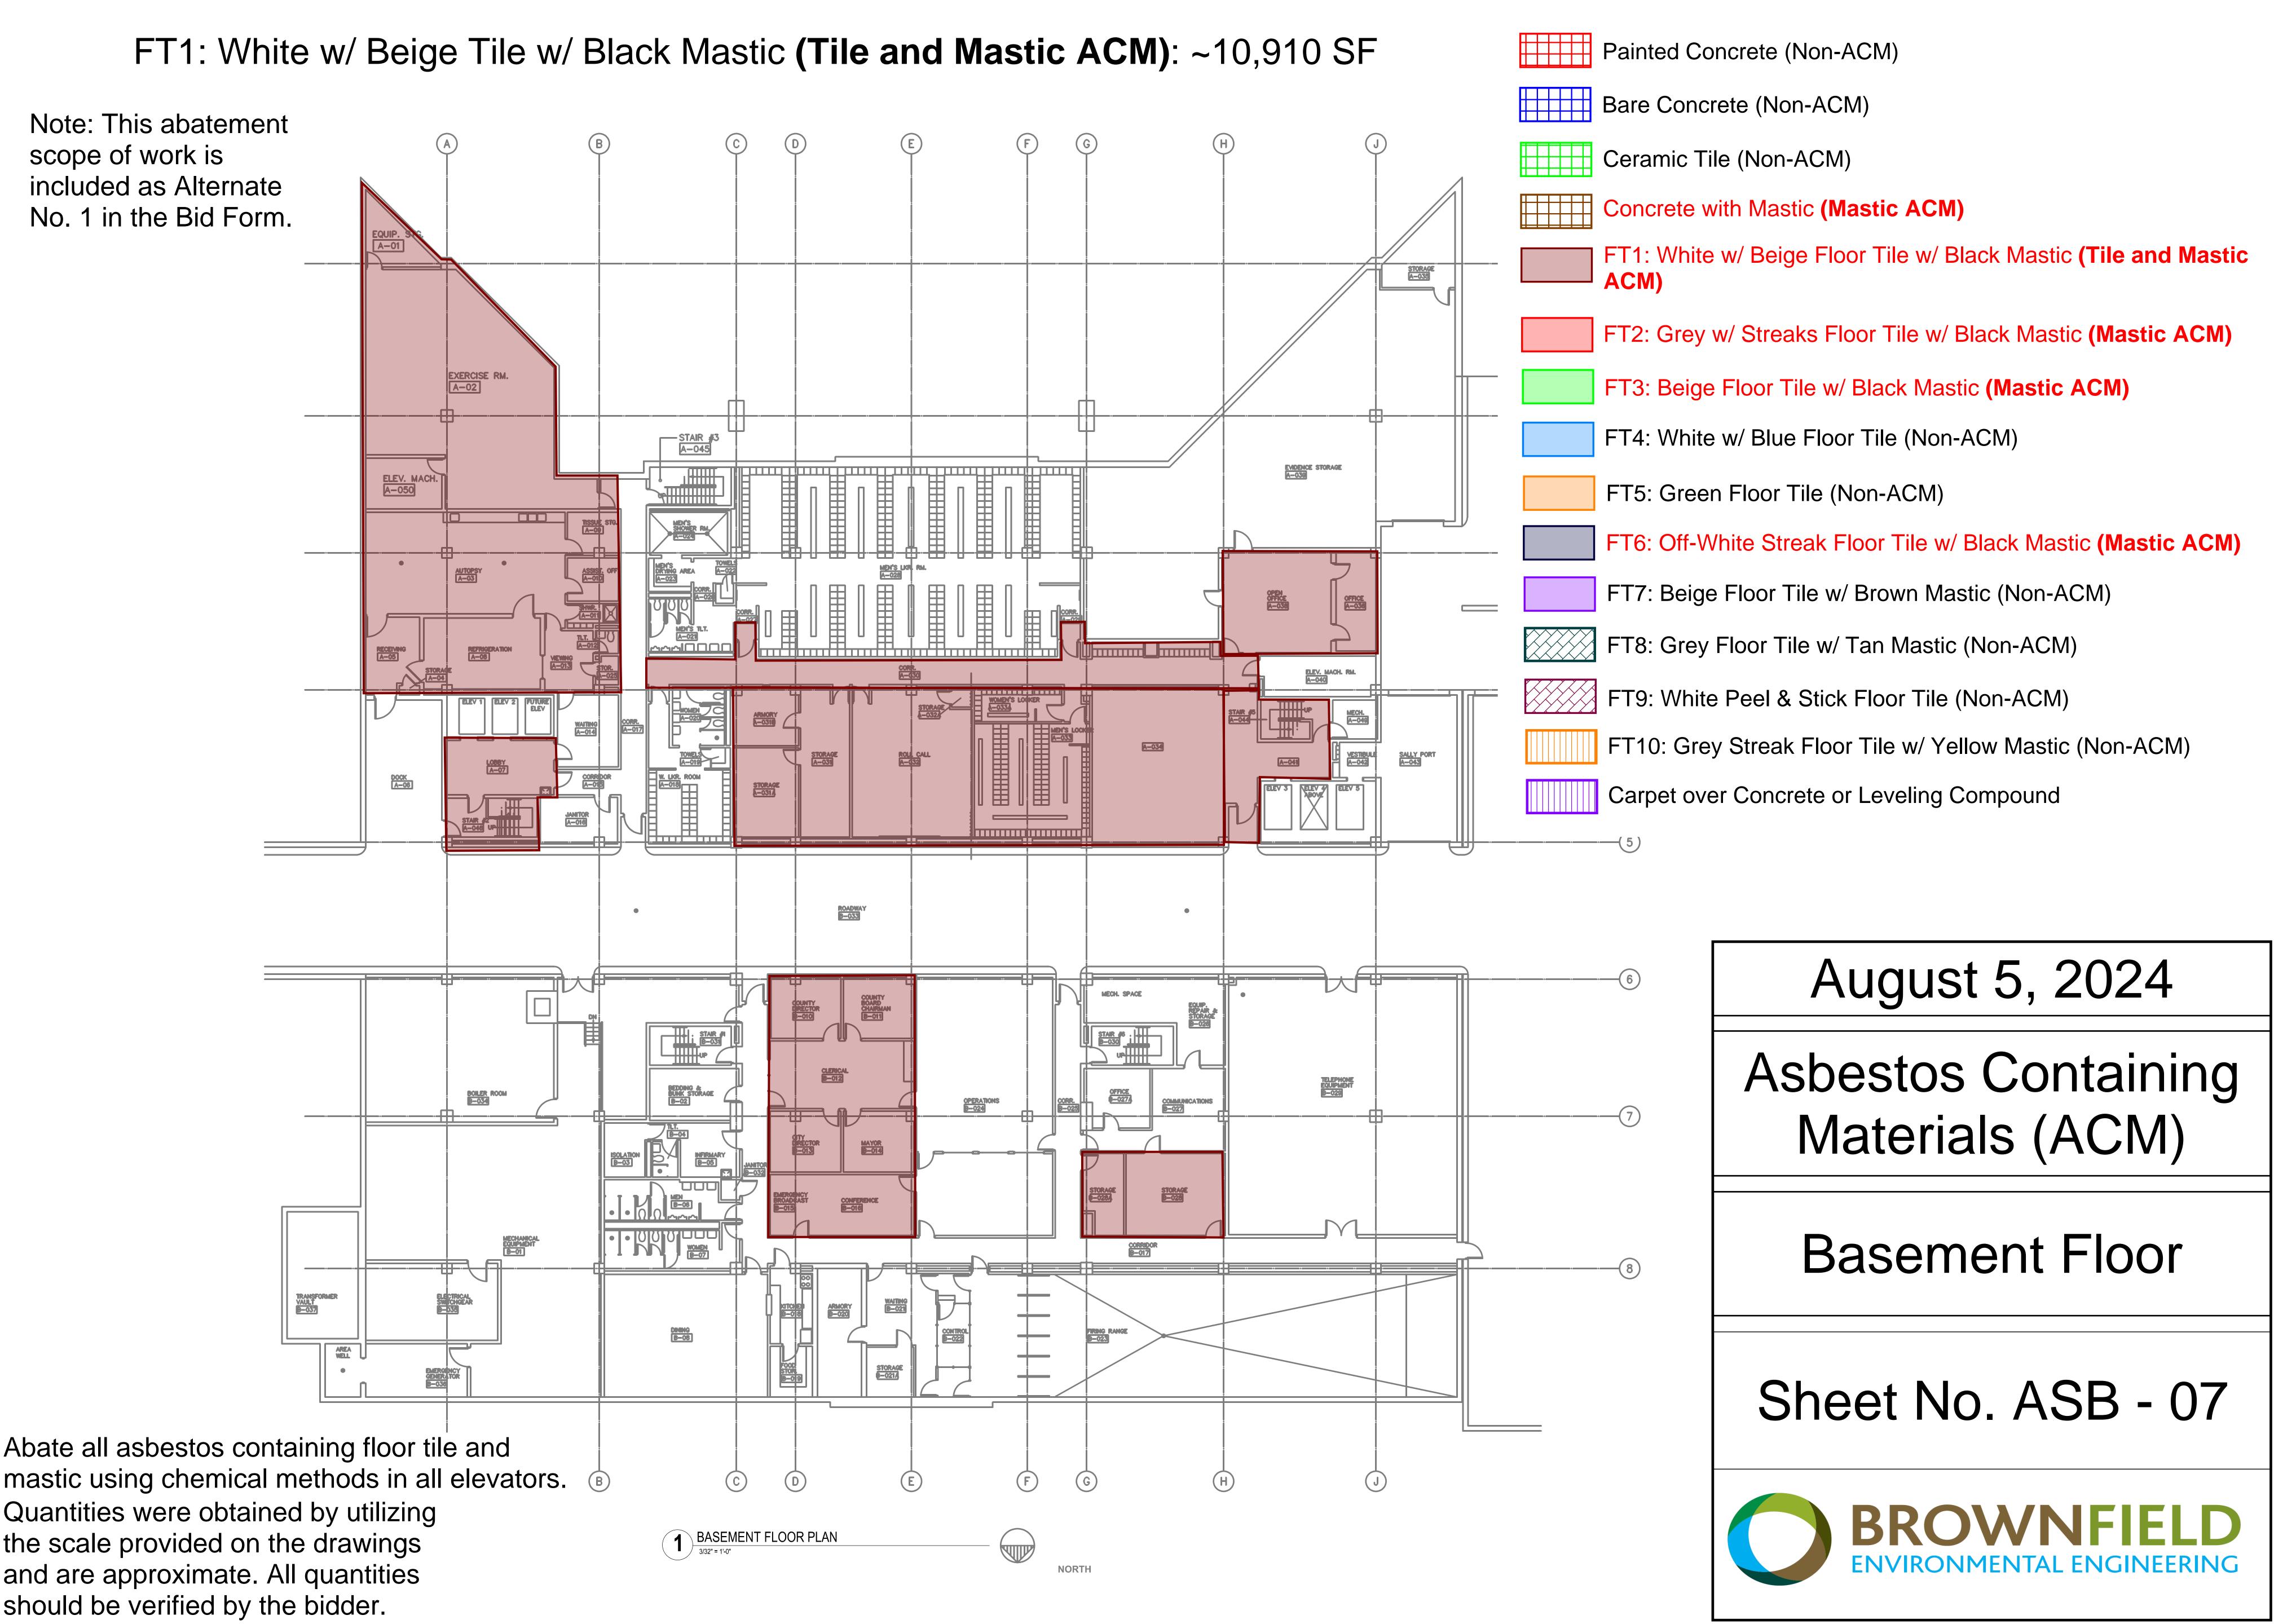

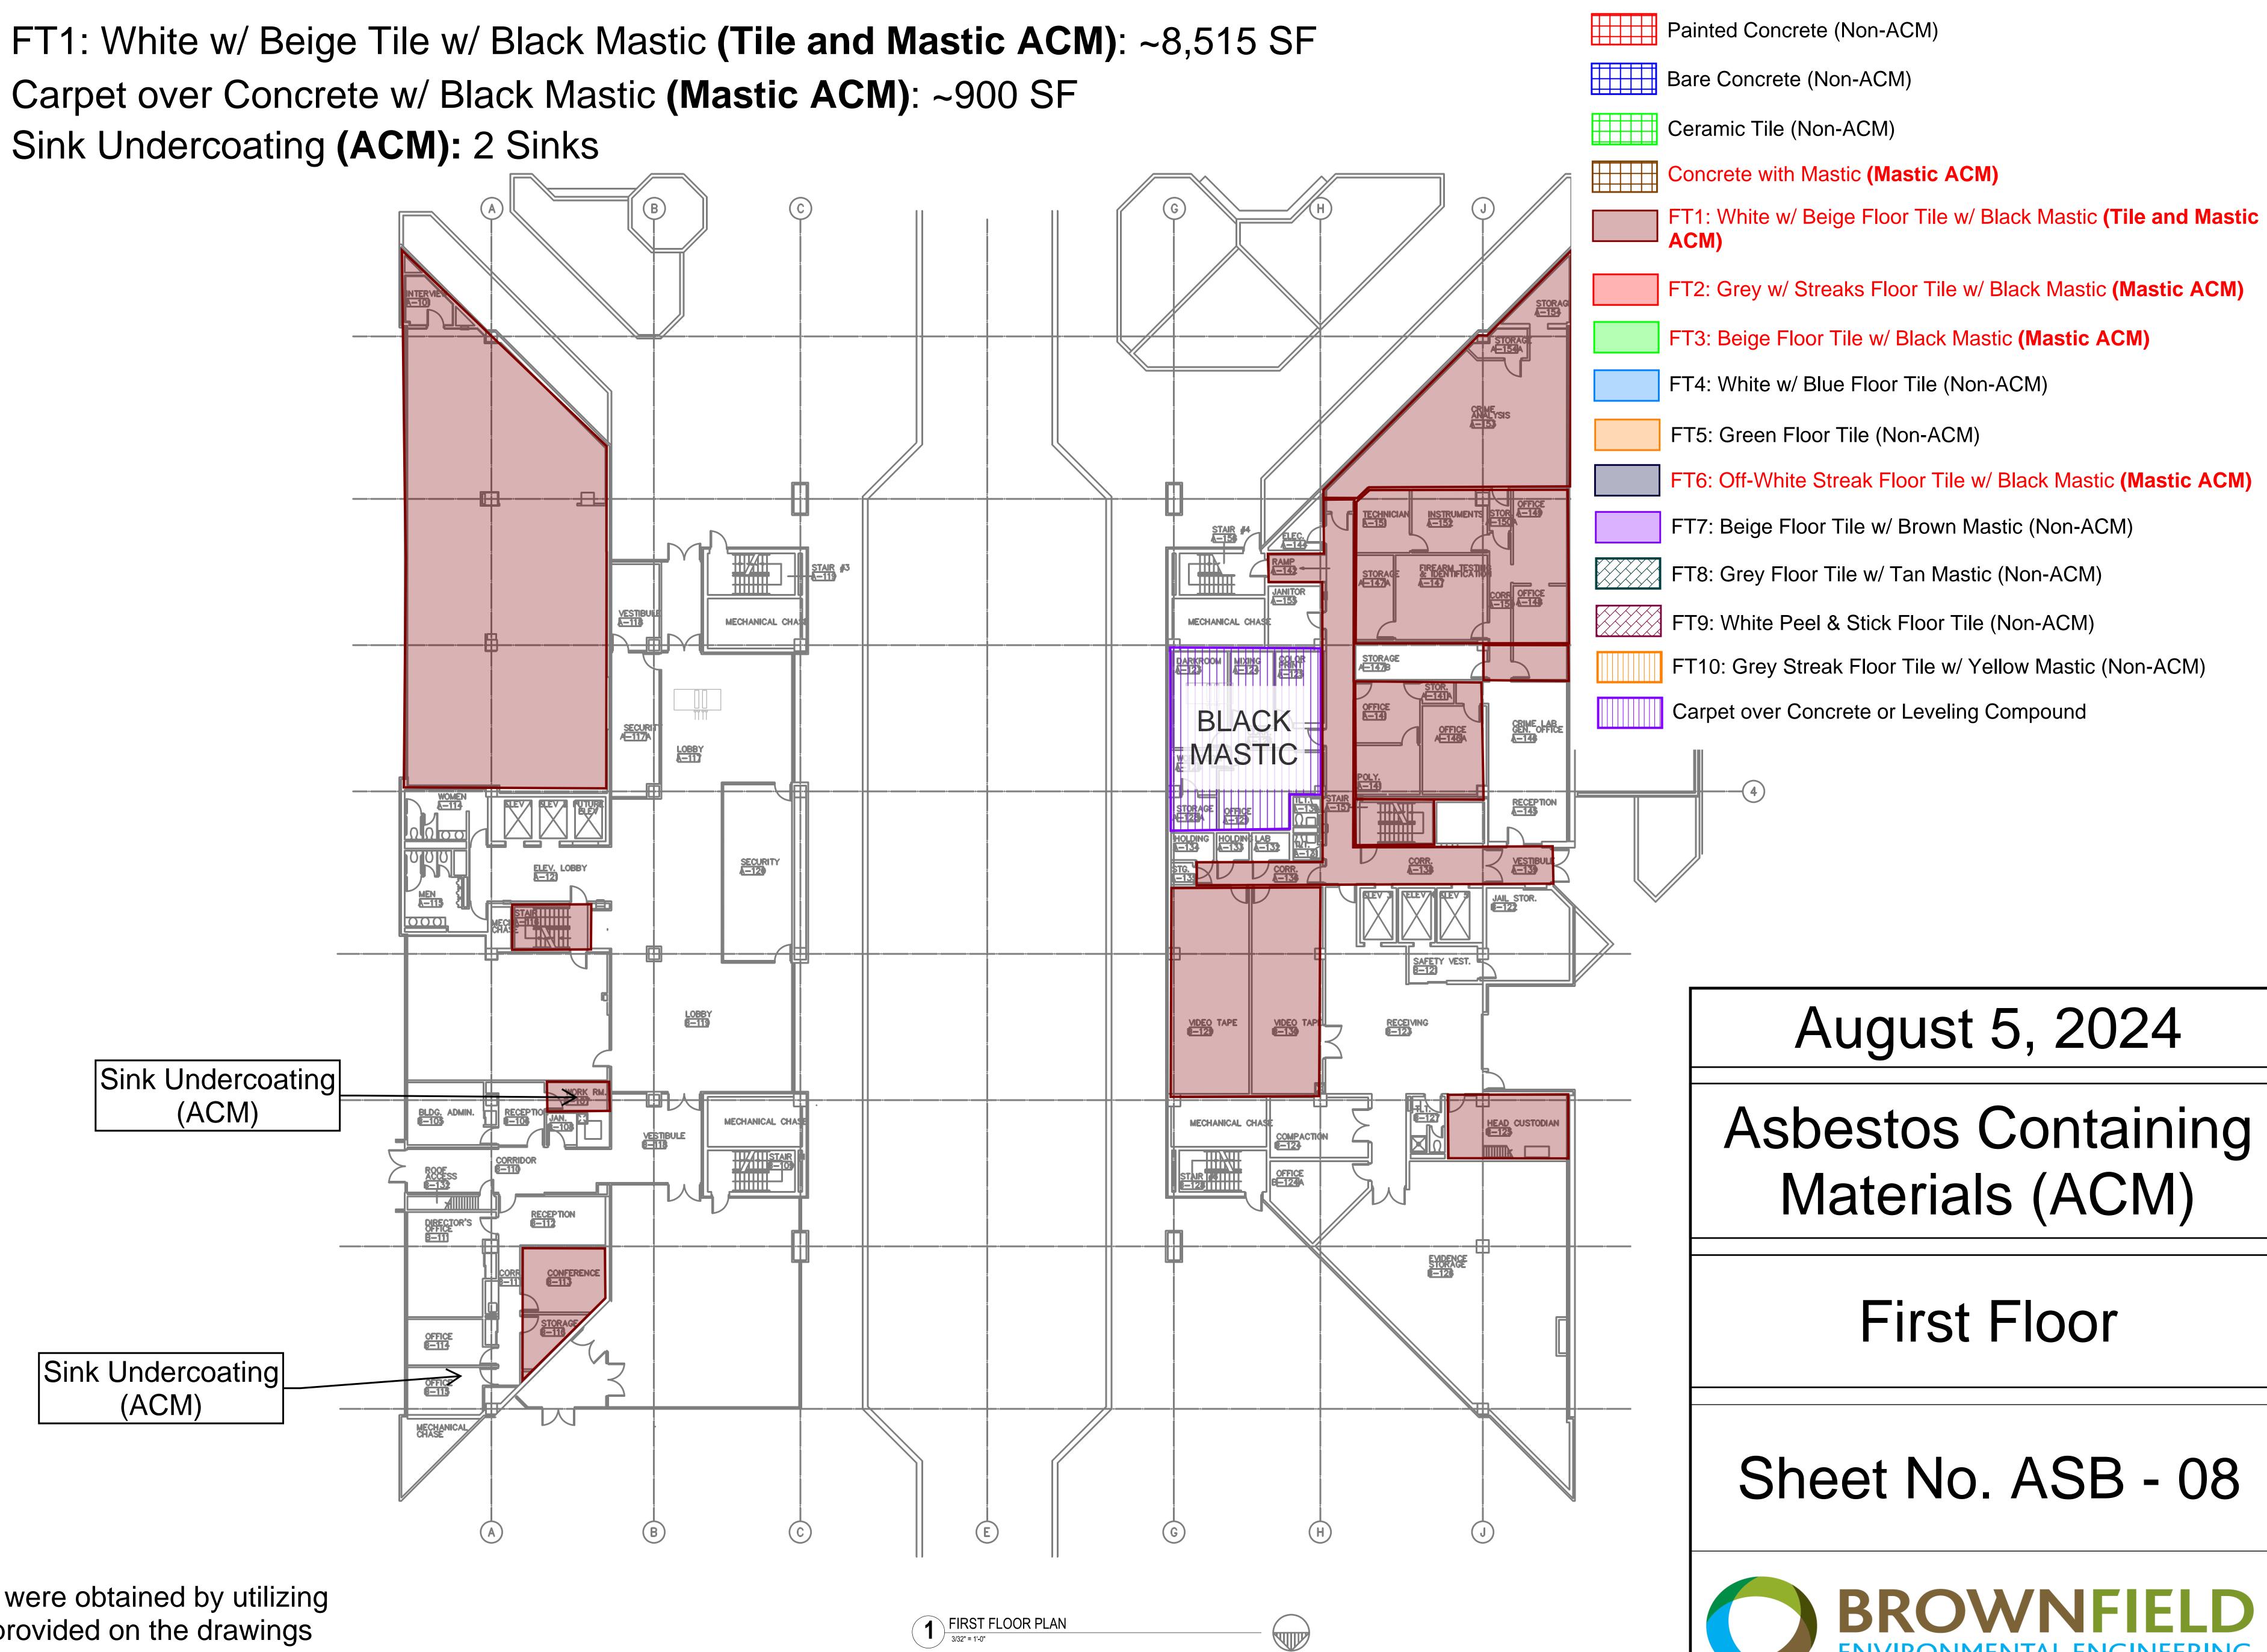


Quantities were obtained by utilizing the scale provided on the drawings and are approximate. All quantities should be verified by the bidder.



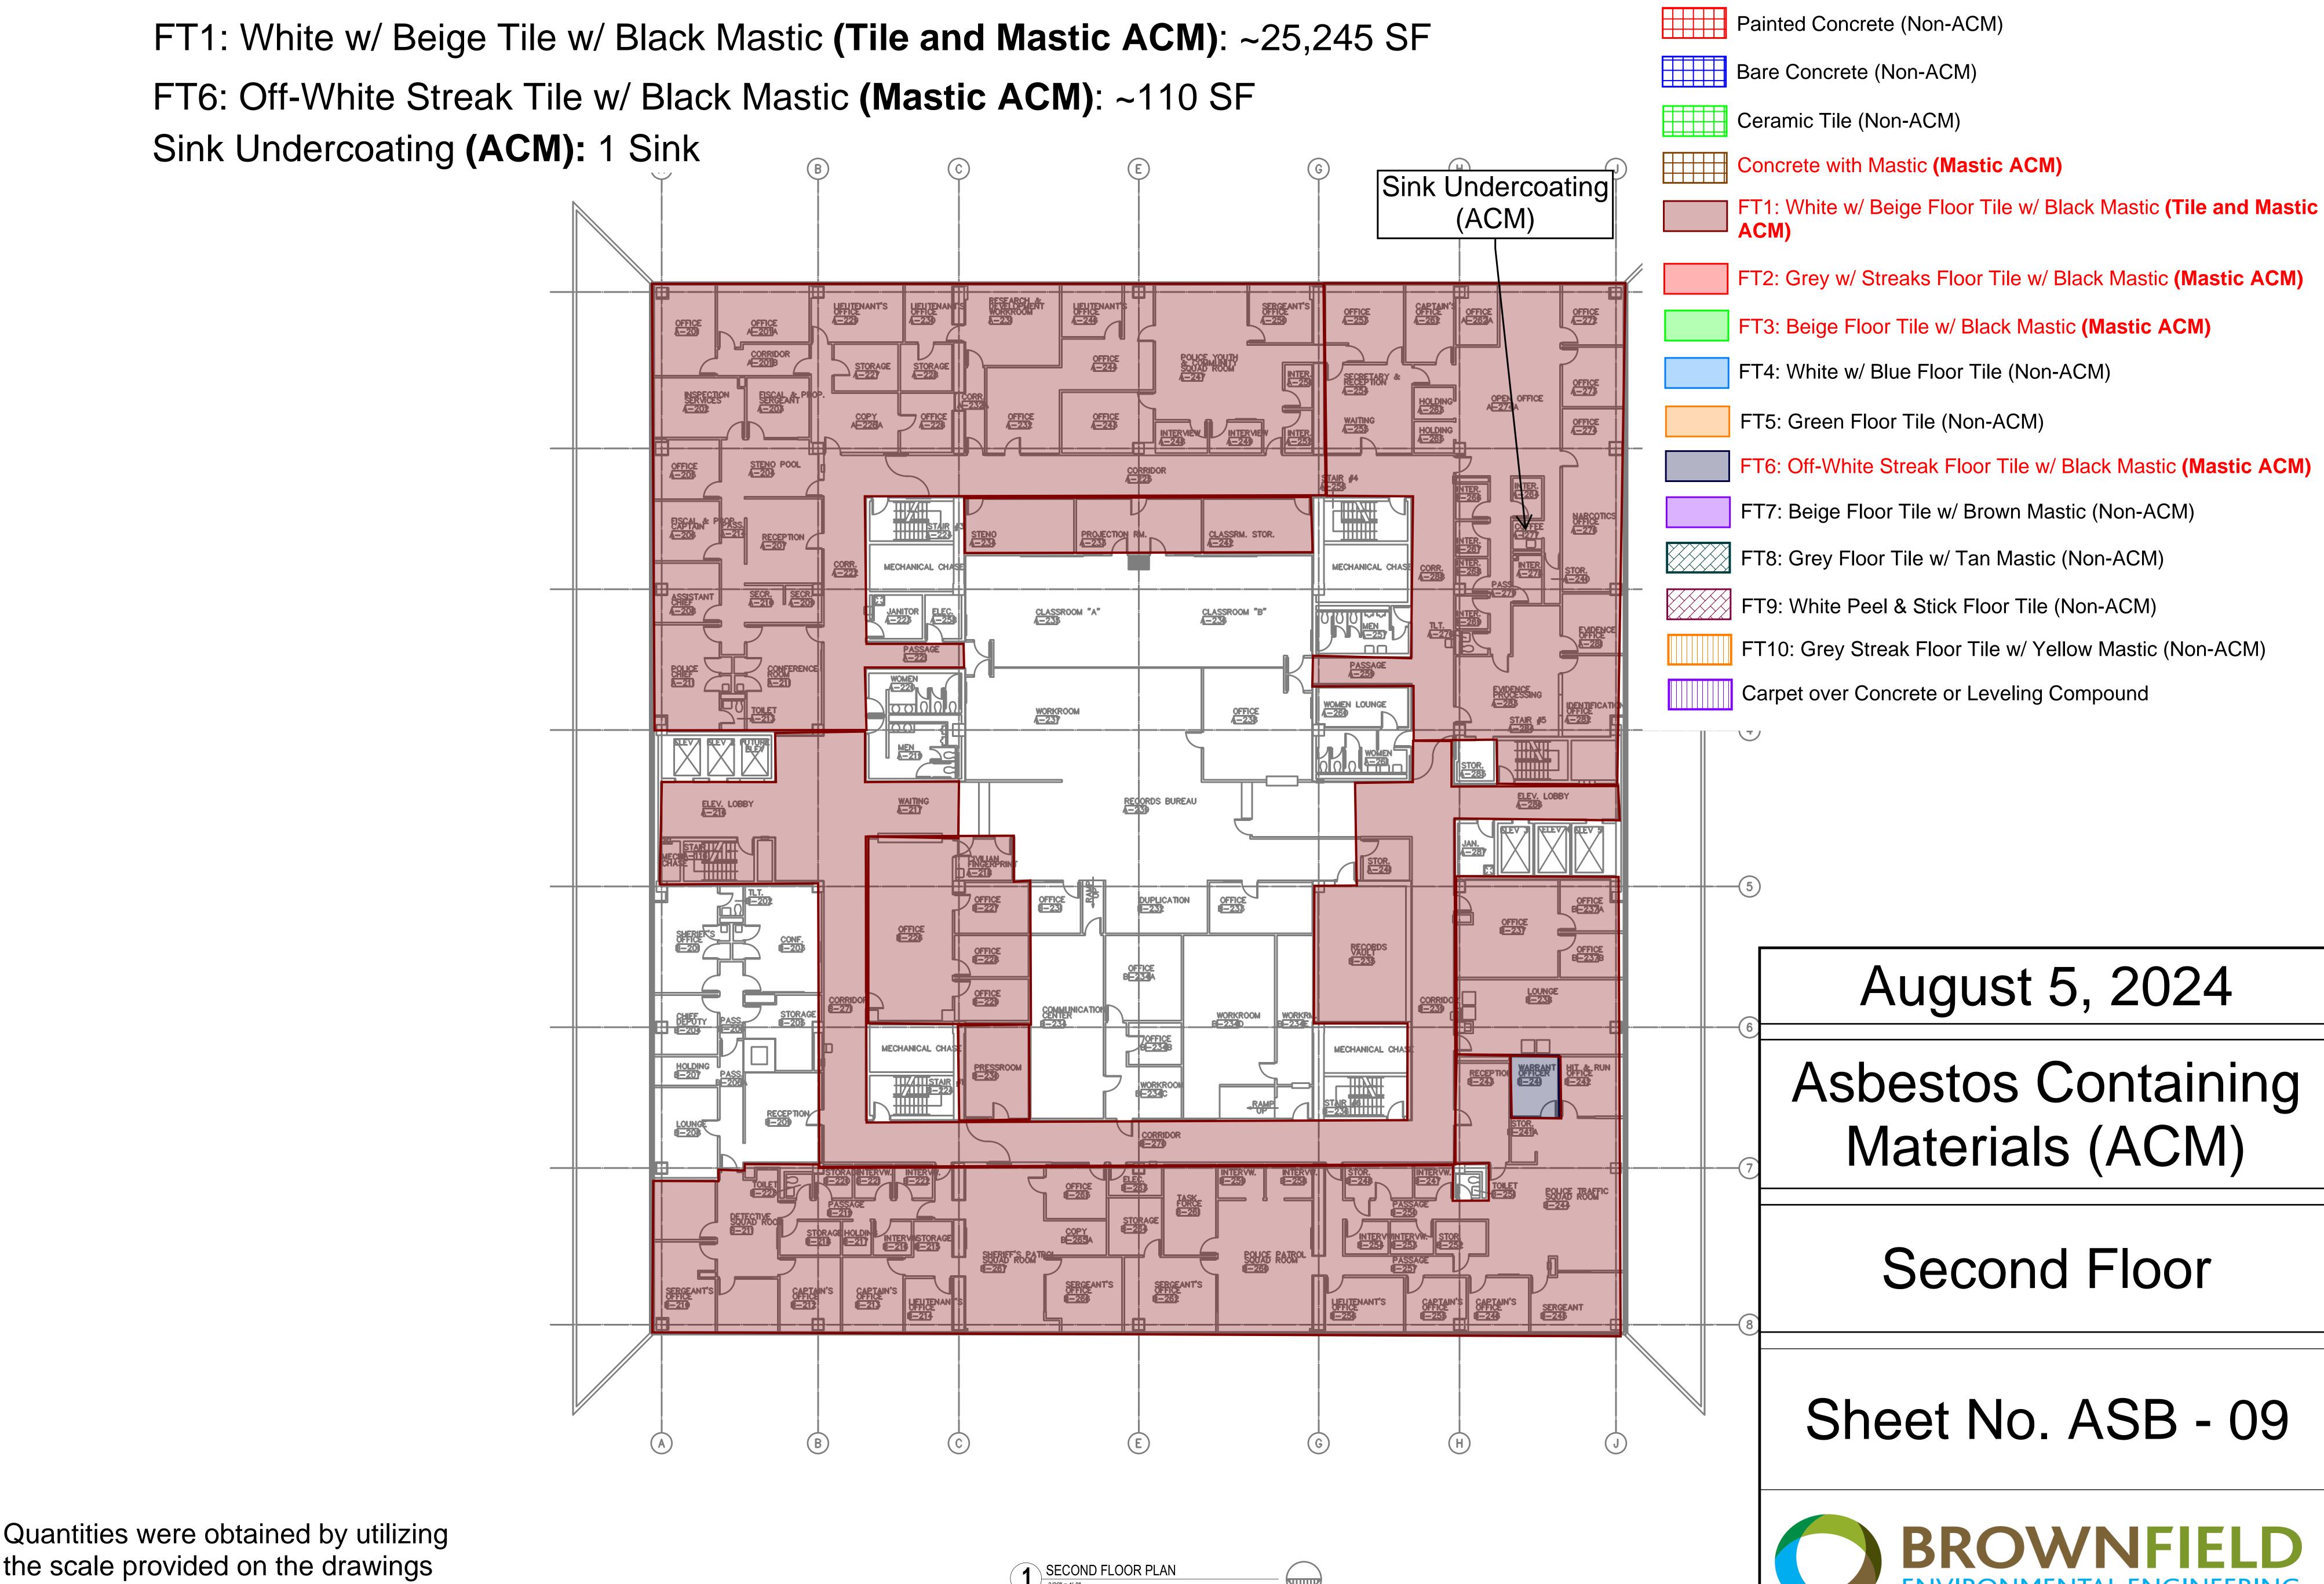

the scale provided on the drawings and are approximate. All quantities should be verified by the bidder.



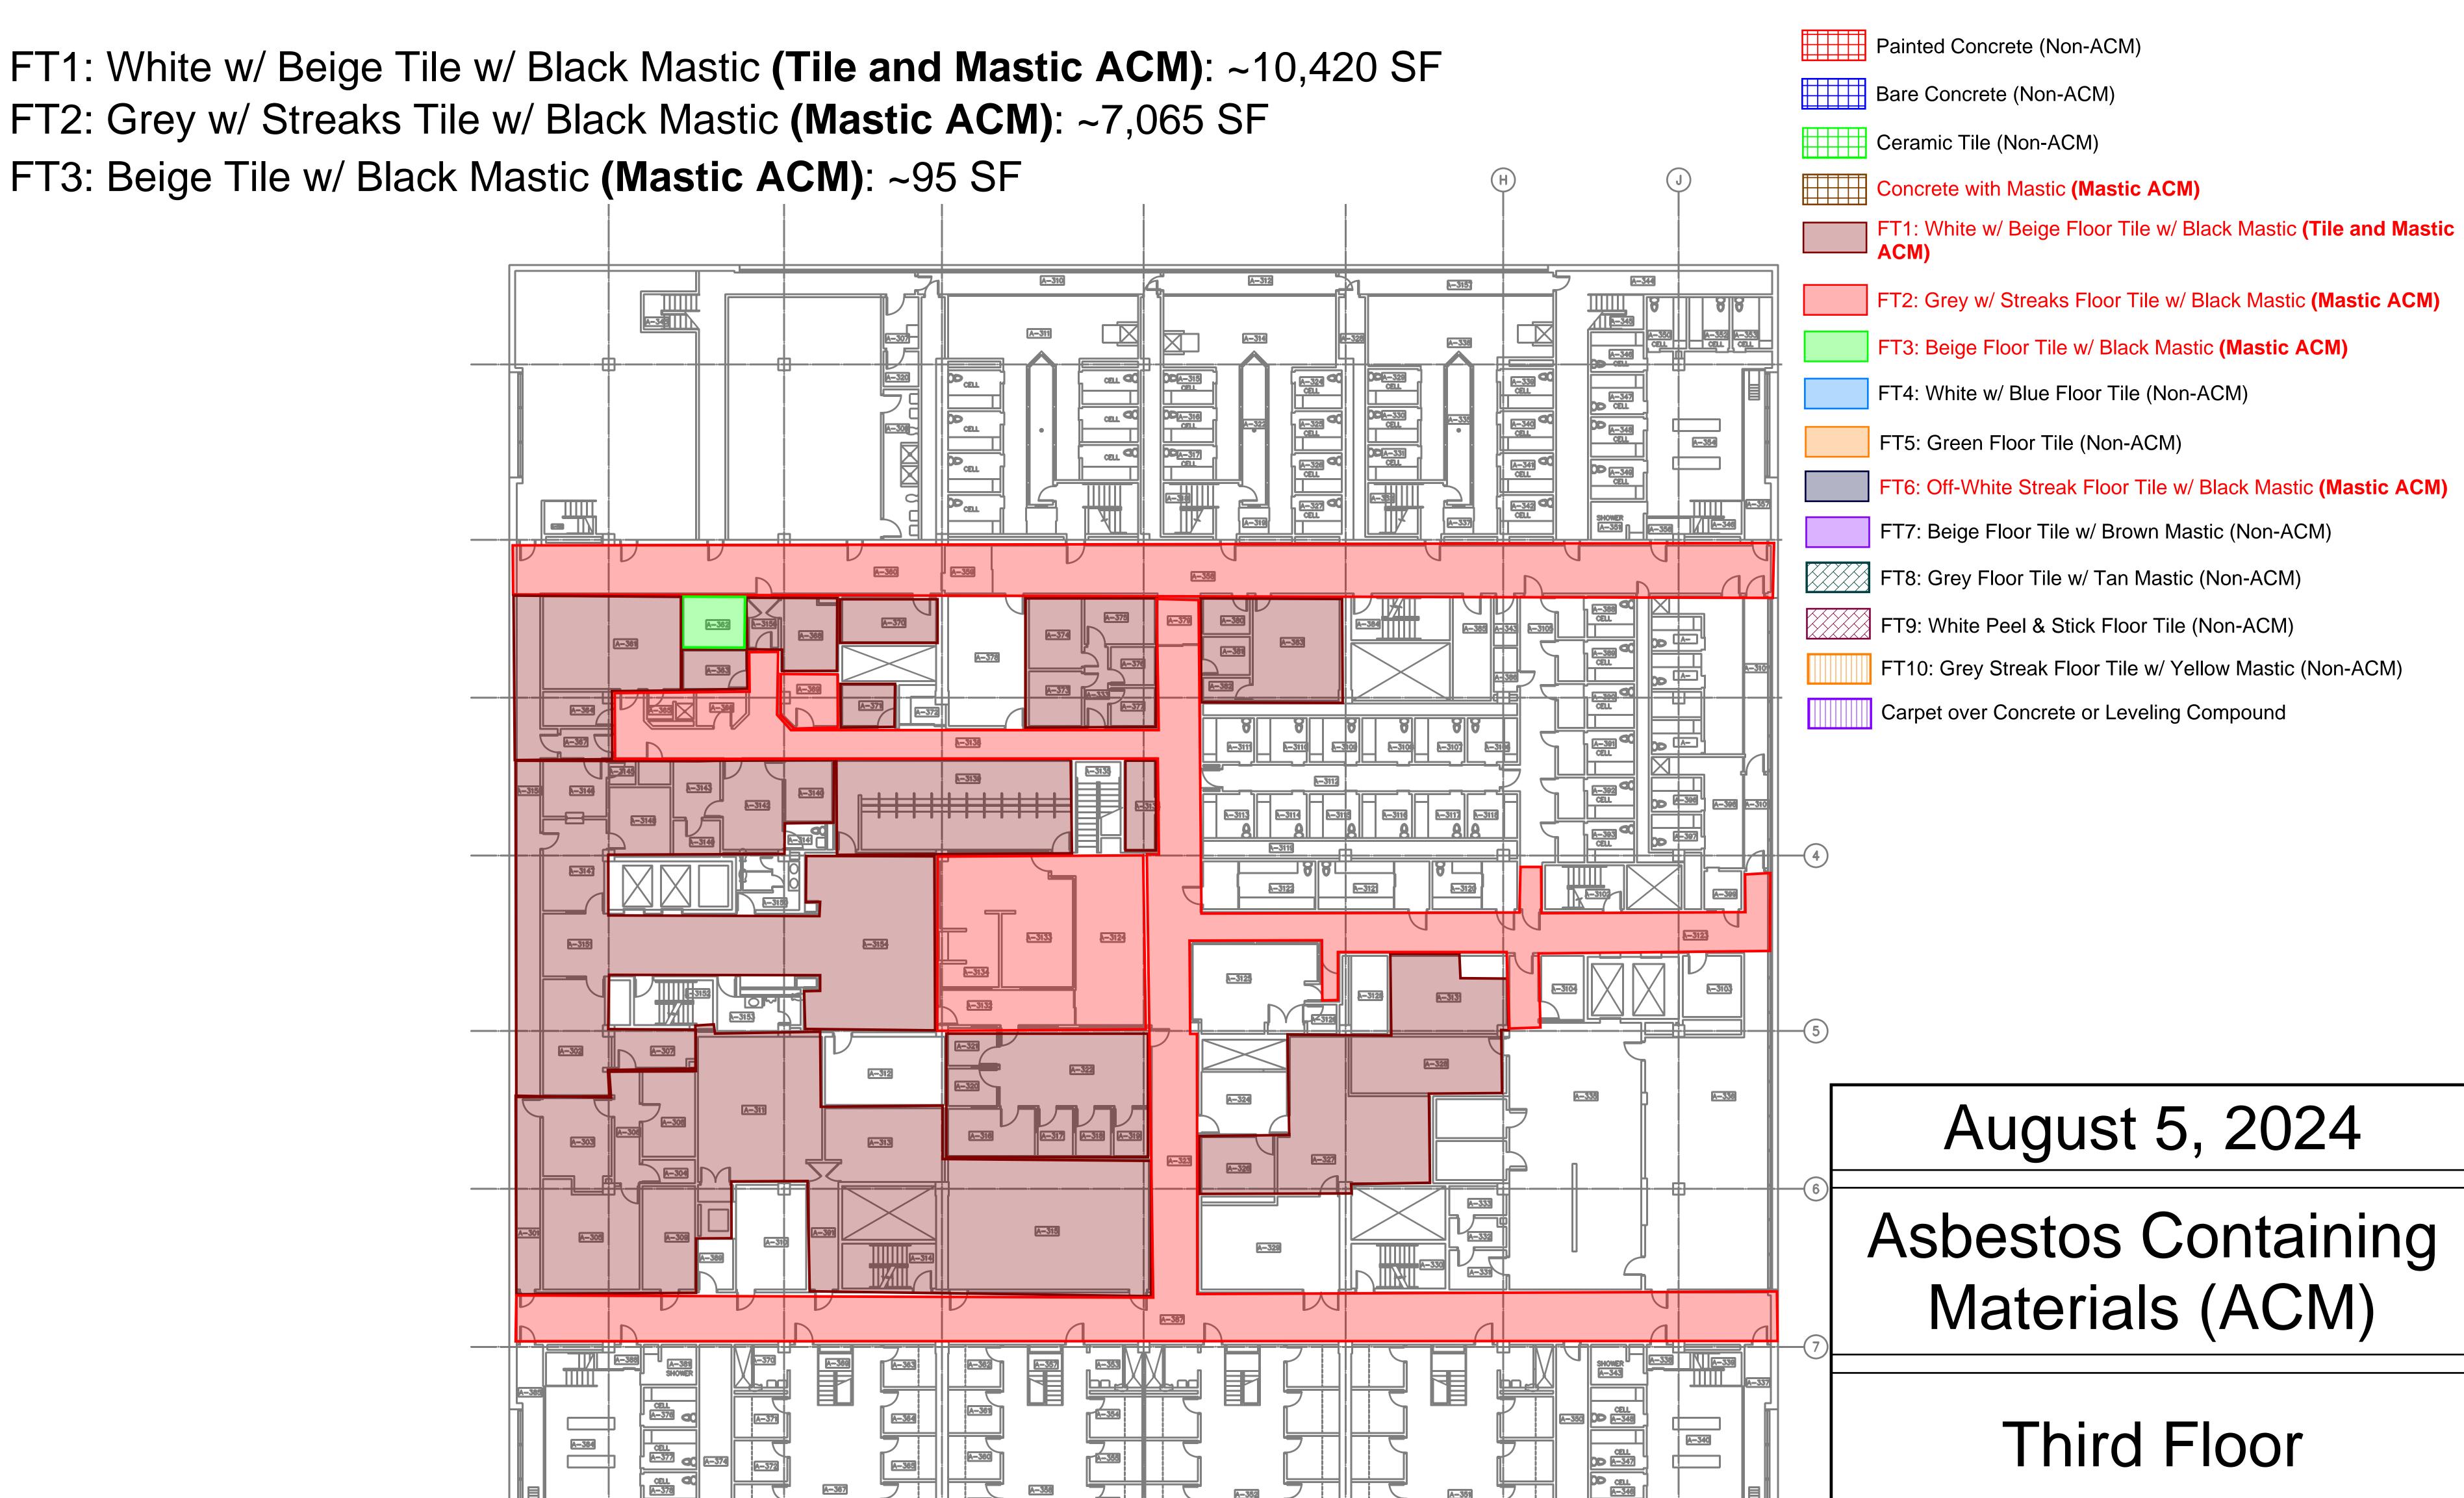


Quantities were obtained by utilizing the scale provided on the drawings and are approximate. All quantities should be verified by the bidder.

CELL CELL A-379

A-383 A-382

A-383 A-382

A-383 A-382

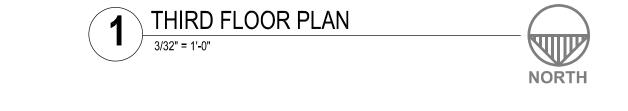



Asbestos Containing Materials (ACM)

Sheet No. ASB - 10

CELL A-348 CELL A-348 A-388 A-






the scale provided on the drawings and are approximate. All quantities should be verified by the bidder.



NO ABATEMENT

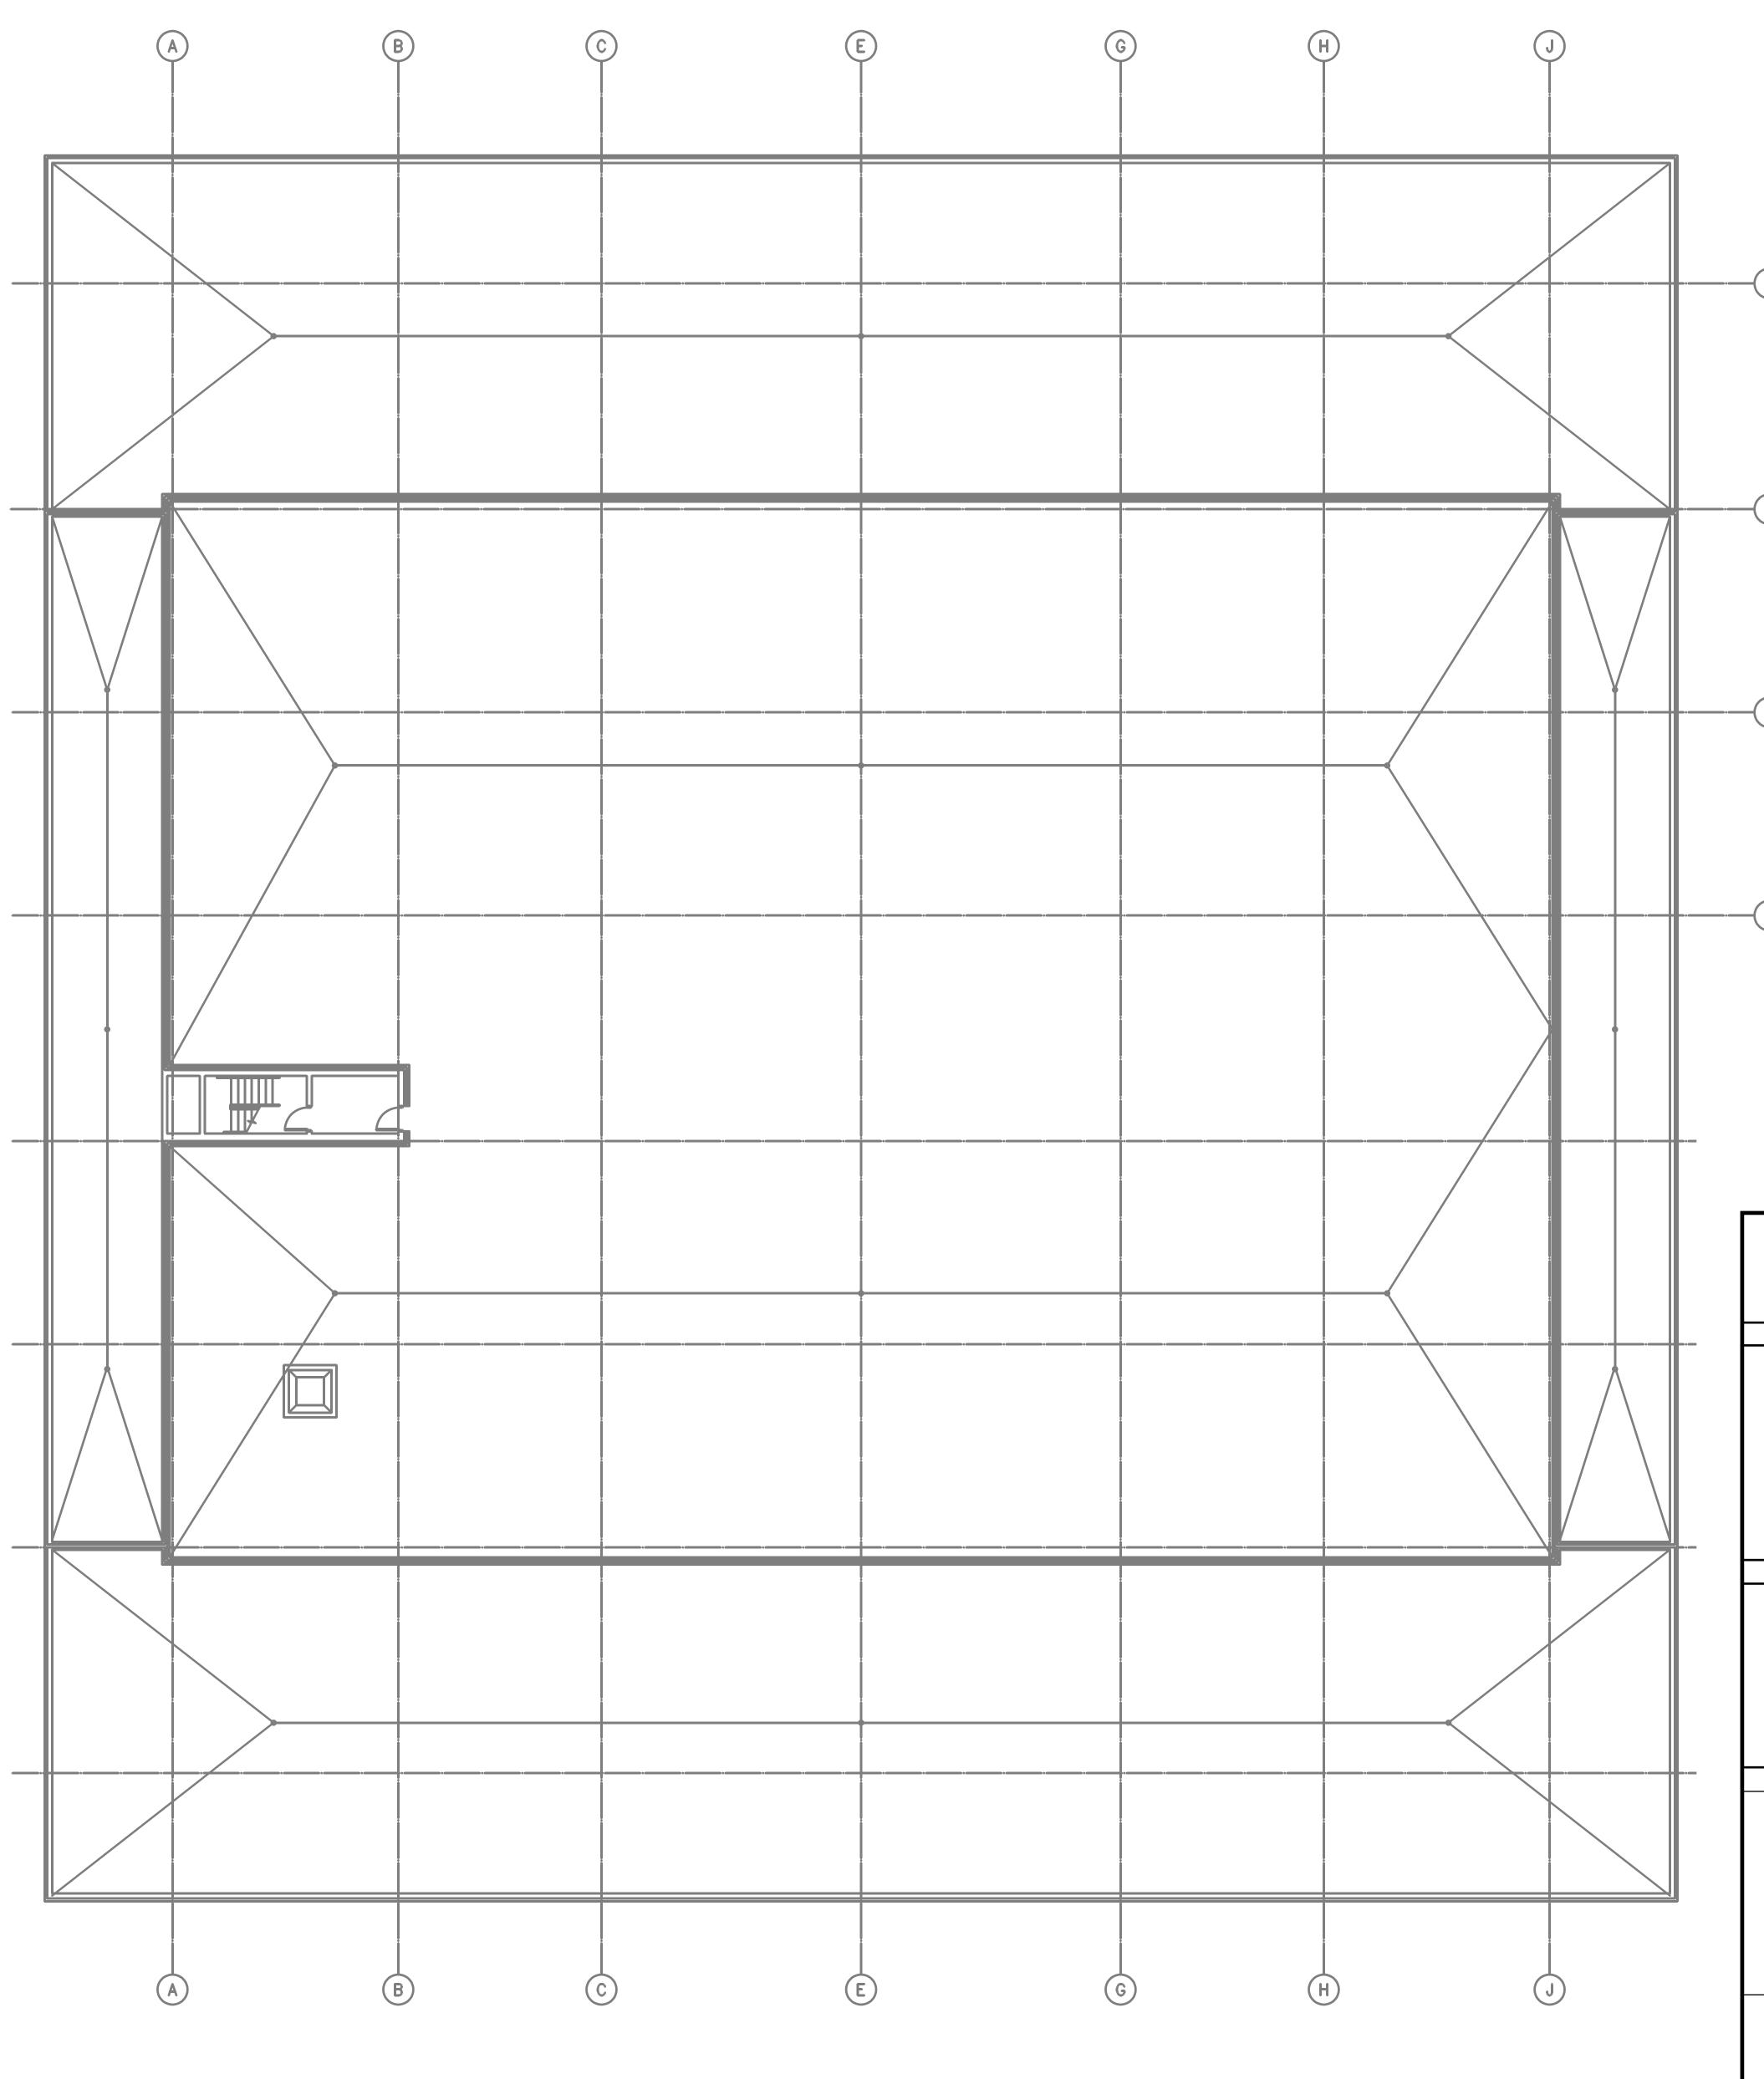

August 5, 2024

Asbestos Containing Materials (ACM)

Roof

Sheet No. ASB - 12



Quantities were obtained by utilizing the scale provided on the drawings and are approximate. All quantities should be verified by the bidder.

