


# ACCESS AND ACCESSIBILITY UPGRADES FOR: VETERANS MEMORIAL HALL

WINNEBAGO COUNTY

BID # 21B-2217

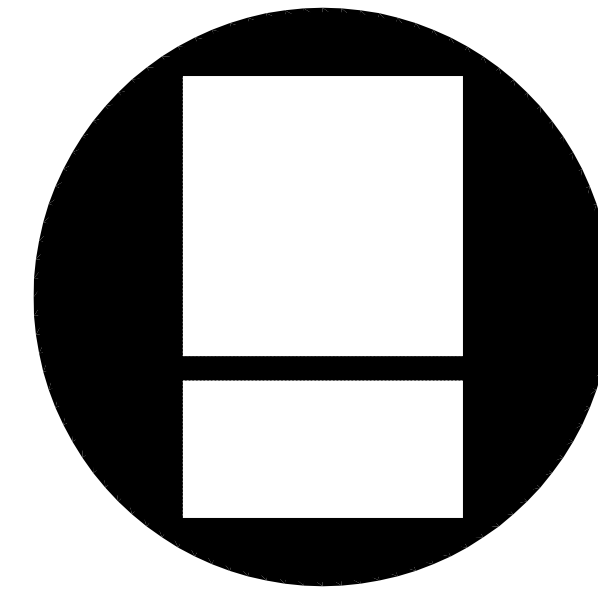


**Larson & Darby Group**  
Architecture Engineering Interiors  
4949 Harrison Avenue Suite 100 Rockford, Illinois


ISSUED FOR: PLAN REVIEW

JUNE 18, 2021

## PROJECT LOCATION MAP

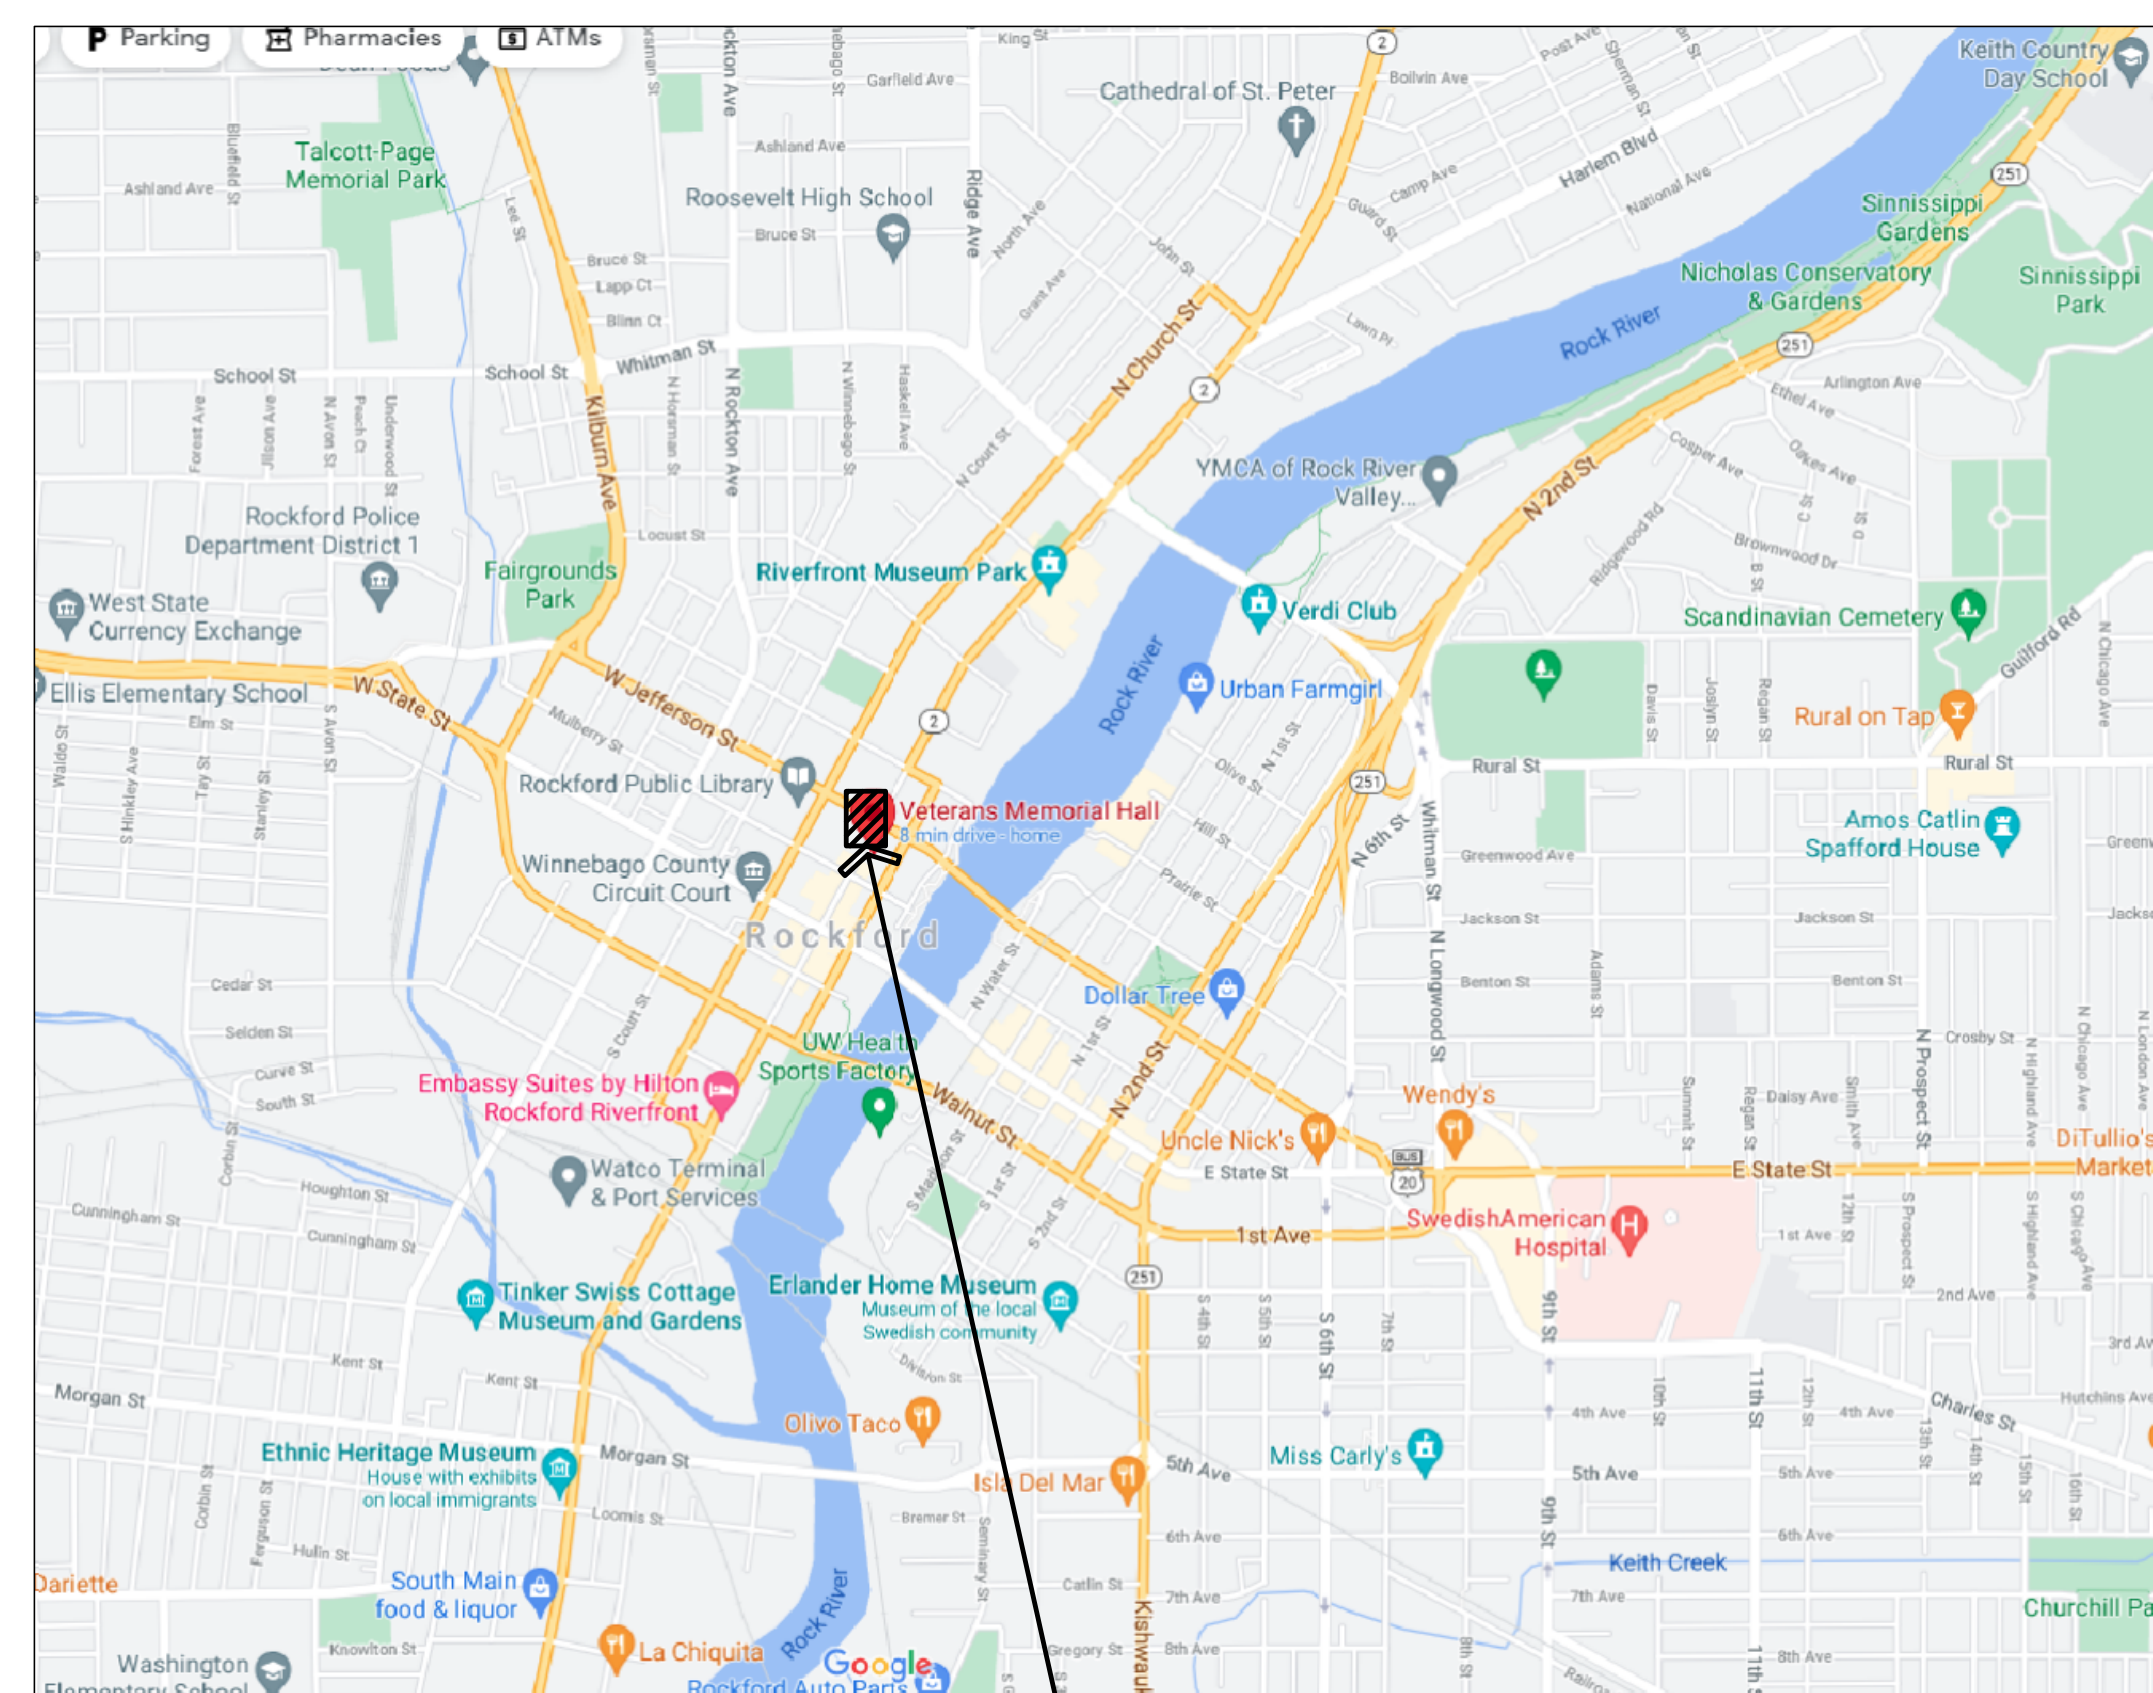

PROJECT LOCATION  
211 N. MAIN STREET, ROCKFORD, ILLINOIS

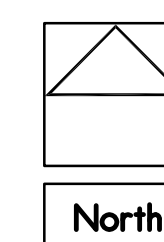

## SHEET INDEX

NO.	DESCRIPTION
TL1	PROJECT COVER SHEET & LOCATION MAP (THIS SHEET)
	CIVIL / LANDSCAPE
C01	REMOVAL PLAN
C02	LAYOUT AND LANDSCAPE PLAN
C03	GRADING AND DRAINAGE PLAN
C04	CONSTRUCTION DETAILS
	ARCHITECTURAL
A1.1	PLANS, SECTIONS AND ELEVATIONS
A1.2	SECTIONS AND DETAILS

## CODE COMPLIANCE NOTES

Building Code: 2015 ICC International Building Code (IBC) (with local amendments)  
 Other Codes: 2015 ICC International Mechanical Code (IMC)  
 2015 ICC International Fire Code (IFC)  
 2014 NFPA 70 National Electric Code (NEC)  
 2014 IDPH Illinois Plumbing Code (IPC) (with local amendments)  
 2018 ICC International Energy Conservation Code (IECC)  
 Accessibility Code: 2018 ADA Standards for Accessible Design  
 2010 ADA Standards for Accessible Design  
 Type of Project: Entrance Walkway Renovation  
 Use & Occupancy Class: Business-Group B

## GENERAL

### COMPLIANCE STATEMENT

COMPLIANCE STATEMENT - I HAVE PREPARED, OR CAUSED TO BE PREPARED UNDER MY DIRECT SUPERVISION, THE ATTACHED PLANS AND SPECIFICATIONS AND STATE THAT, TO THE BEST OF MY KNOWLEDGE AND BELIEF AND TO THE EXTENT OF MY CONTRACTUAL OBLIGATION, THEY ARE IN COMPLIANCE WITH THE ENVIRONMENTAL BARRIERS ACT (40 ICS 25) AND THE ILLINOIS ACCESSIBILITY CODE, (71 I.L. ADM. CODE 400). ADA HAS NEITHER A SUBMITTAL REVIEW, NOR AN INSPECTION PROCESS TO INTERPRET DISABILITY LAWS. AS PART OF THE CIVIL RIGHTS ACT AND NOT A CODE, ADA COMPLIANCE CAN NOT BE CERTIFIED TO. TO THE BEST OF MY ABILITY AND KNOWLEDGE, I HAVE INTERPRETED AND ATTEMPTED TO COMPLY WITH ALL ADA STANDARDS, 42 U.S.C. SECTION 1201 ET SEQ. THIS IS PERCEIVED COMPLIANCE, NOT CERTIFICATION.


### SEALS

Larson & Darby Group Design Firm Registration Number: 184-000280  
 Refer to Civil Sheets C01 through C04 for Professional Seal.




EXPIRES: 11-30-2022  
 JOSEPH P. WINKELMANN  
 LICENSED ARCHITECT

DATE: 06-18-2021

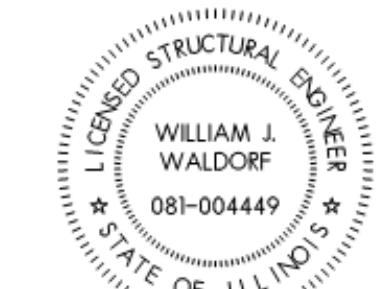


EXPIRES: 11-30-2022  
 WILLIAM J. WALDORF  
 STRUCTURAL ENGINEER

DATE: 06-18-2021

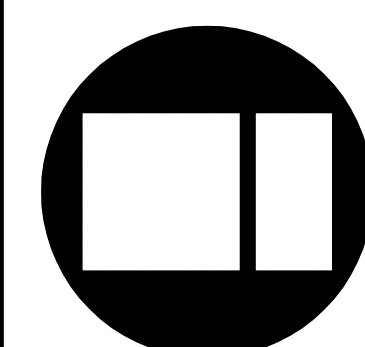




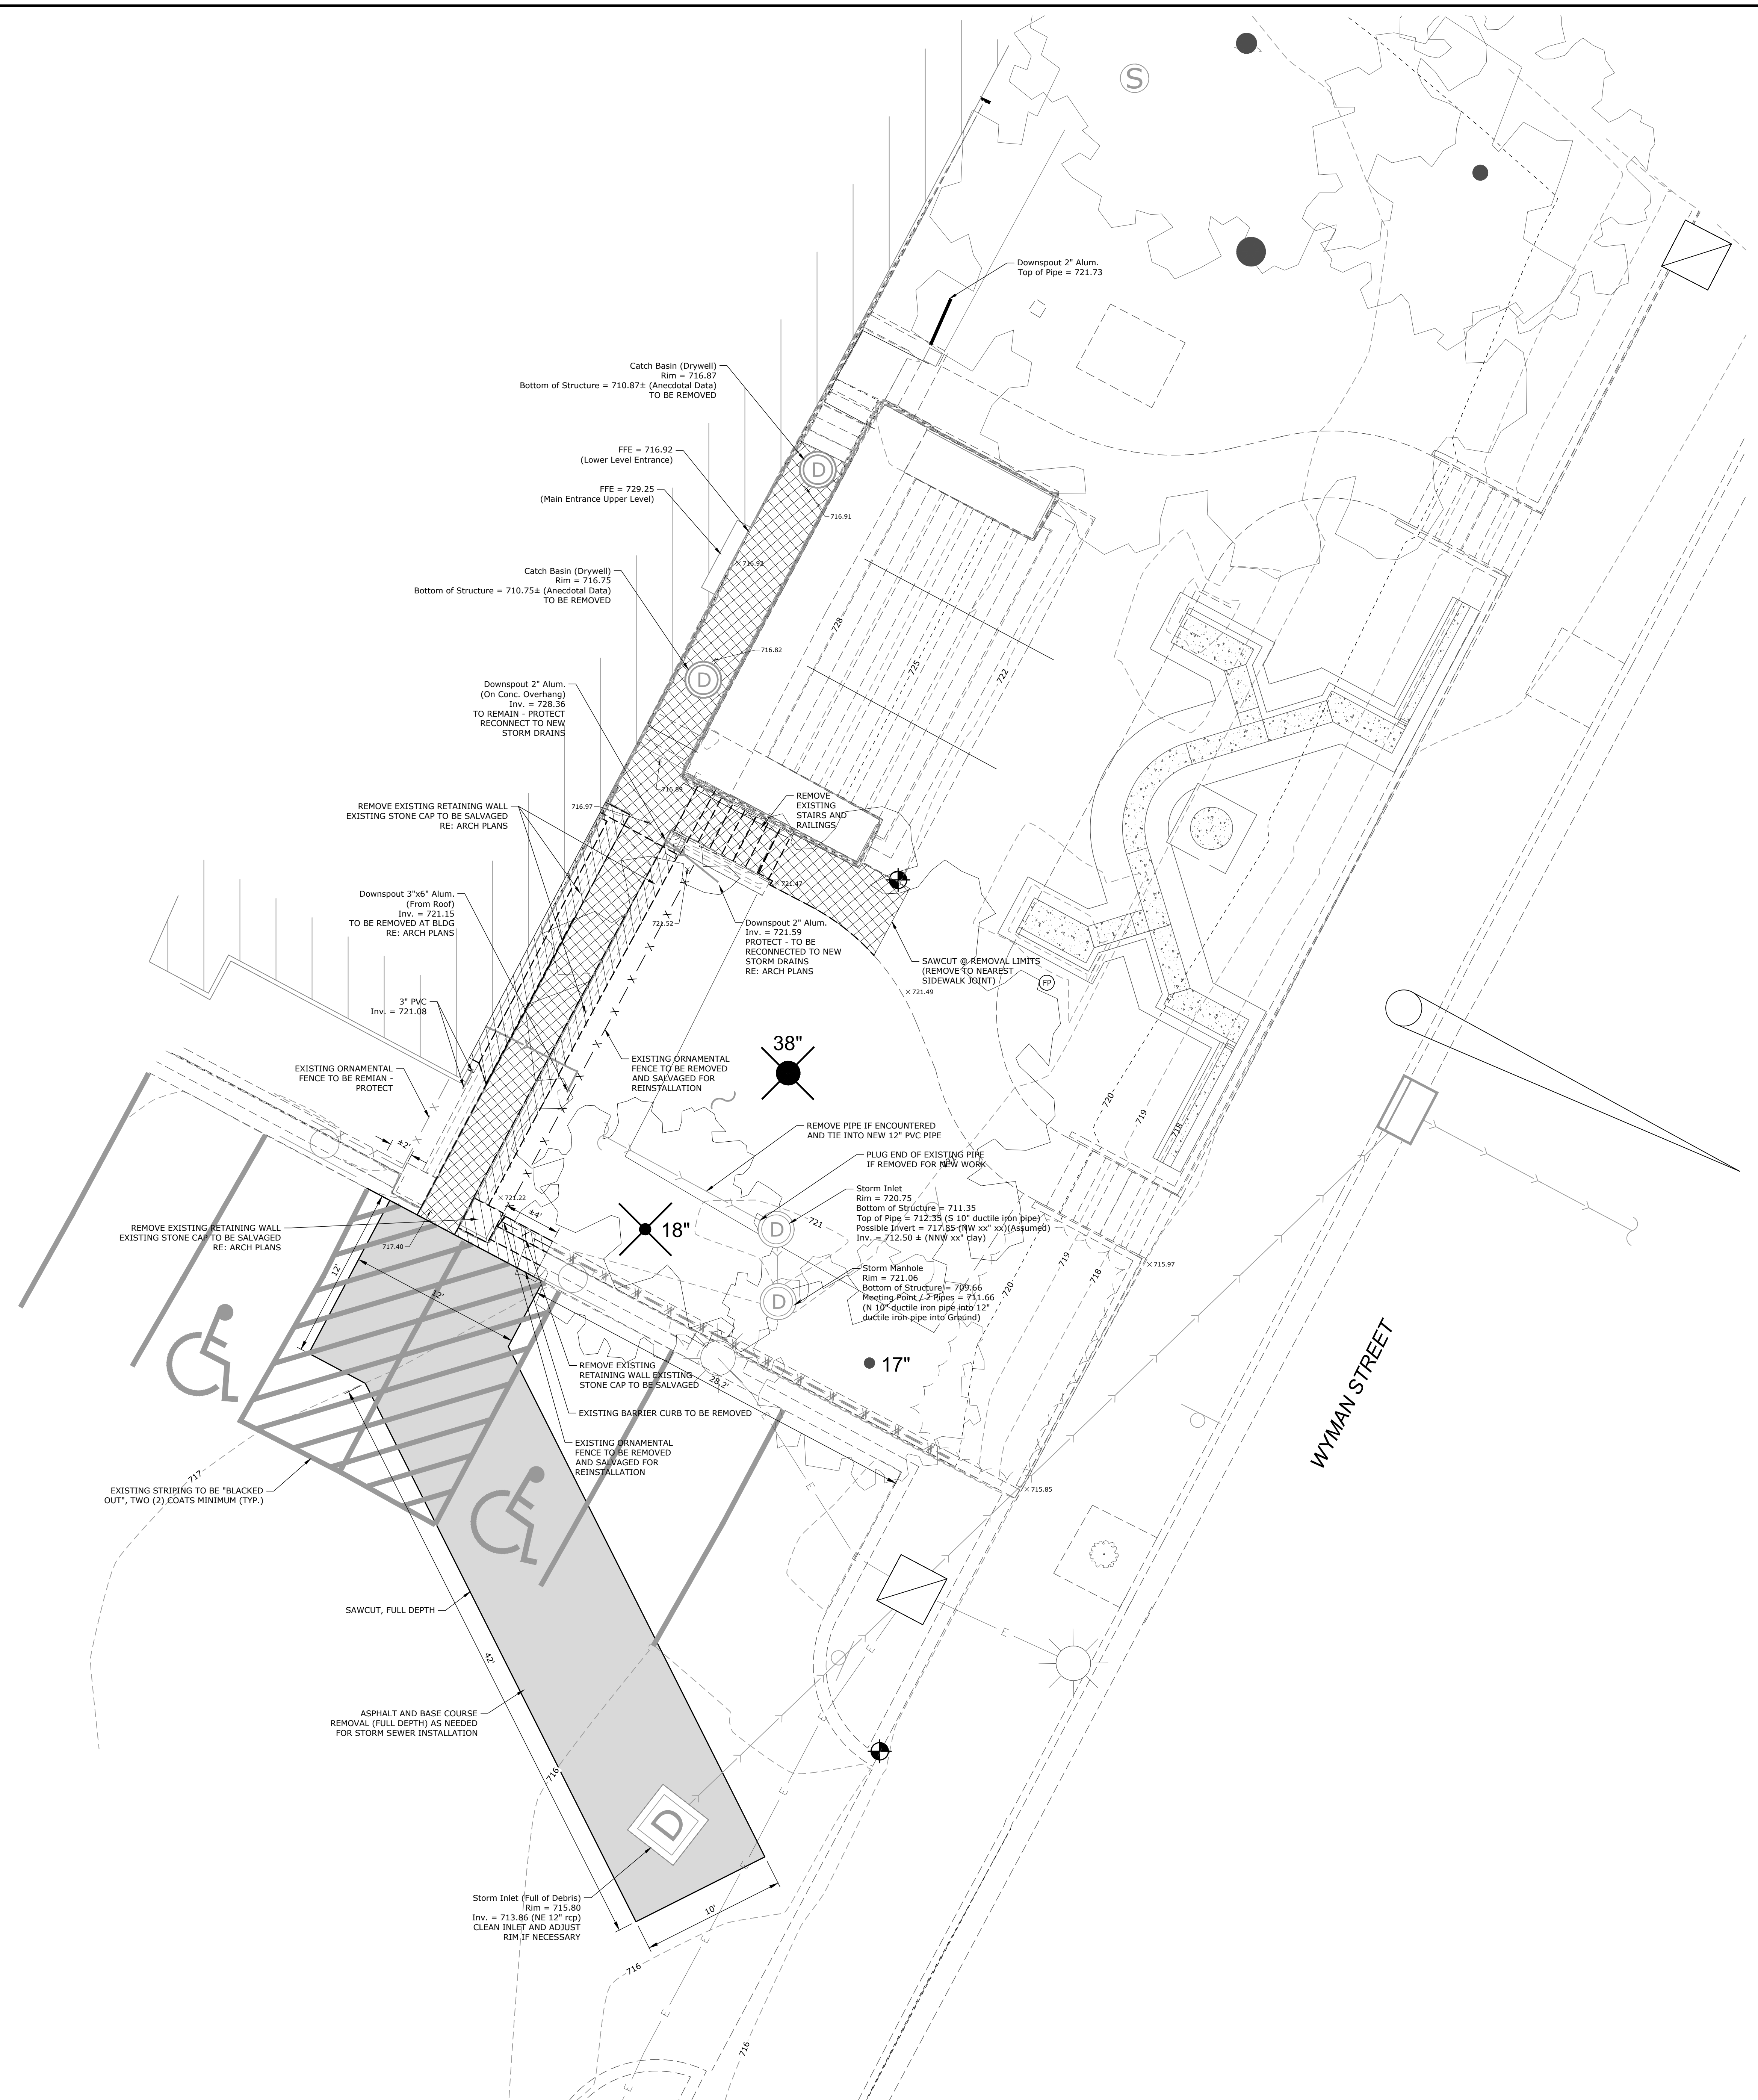

**LEGEND**

- PROPERTY LINE
- LOT LINE
- EXISTING RIGHT-OF-WAY
- EXISTING EASEMENT LINE
- EXISTING CURB AND GUTTER
- EXISTING CURB AND GUTTER TO BE REMOVED
- EXISTING STORM SEWER TO REMAIN
- EXISTING WATER TO REMAIN
- EXISTING OVERHEAD UTILITIES TO REMAIN
- EXISTING GAS MAIN TO REMAIN
- EXISTING FENCE TO REMAIN
- EXISTING FENCE TO BE REMOVED
- EXISTING CONTOUR LINE
- ▨ EXISTING PAVEMENT, CONCRETE SIDEWALKS OR STAIRS TO BE REMOVED
- ▨ EXISTING RETAINING WALL OR CURB TO BE REMOVED
- ▨ EXISTING ASPHALT TO BE REMOVED
- (TYP) "TYPICAL" FOR ALL SIMILAR ITEMS
- EXISTING WATER TO REMAIN
- EXISTING SIGN TO REMAIN
- EXISTING SIGN TO BE REMOVED
- EXISTING ELECTRIC METER TO REMAIN
- EXISTING STORM SEWER TO REMAIN
- ⊕ BENCHMARK
- ⊕ EXISTING TRAFFIC SIGNAL MAST ARM
- ⊗ EXISTING TREE TO BE REMOVED
- ⊙ EXISTING TREE TO REMAIN

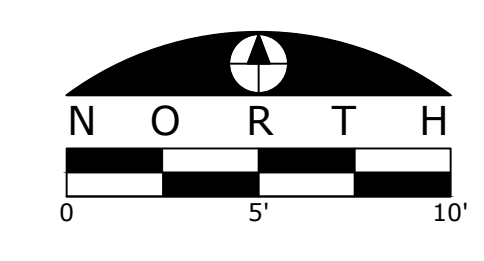


BENCHMARKS	
DESCRIPTION	ELEVATION (USGS)
BENCHMARK 1 CHISELED SQUARE	716.52

**REMOVAL PLAN**



5291 ZENITH PARKWAY  
LOVES PARK, IL 61111  
VOICE: (815) 484-4300  
FAX: (815) 484-4303  
www.arcdesign.com  
Illinois Design Firm License No. 184-001334

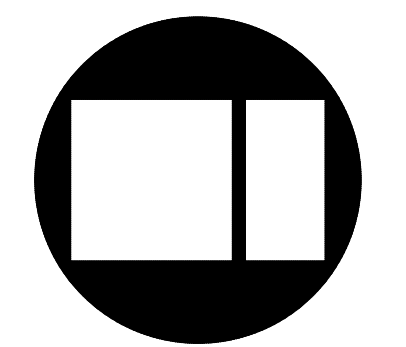

PROGRESS PRINT  
Not For Construction  
Date: 06-08-2021  
LARSON & DARBY GROUP  
architectureengineeringinteriors


ACCESSIBILITY RAMP STUDY  
VETERANS MEMORIAL HALL  
ROCKFORD, ILLINOIS

**COPYRIGHT 2021**  
All drawn and written information appearing herein shall not be duplicated, disclosed, or otherwise used without the written consent of Larson & Darby Group.


ISSUED FOR:	DATE:
DRAWN	APPROVED

DATE: 6-18-2021
PROJECT NUMBER: 30271
SHEET NUMBER: C01




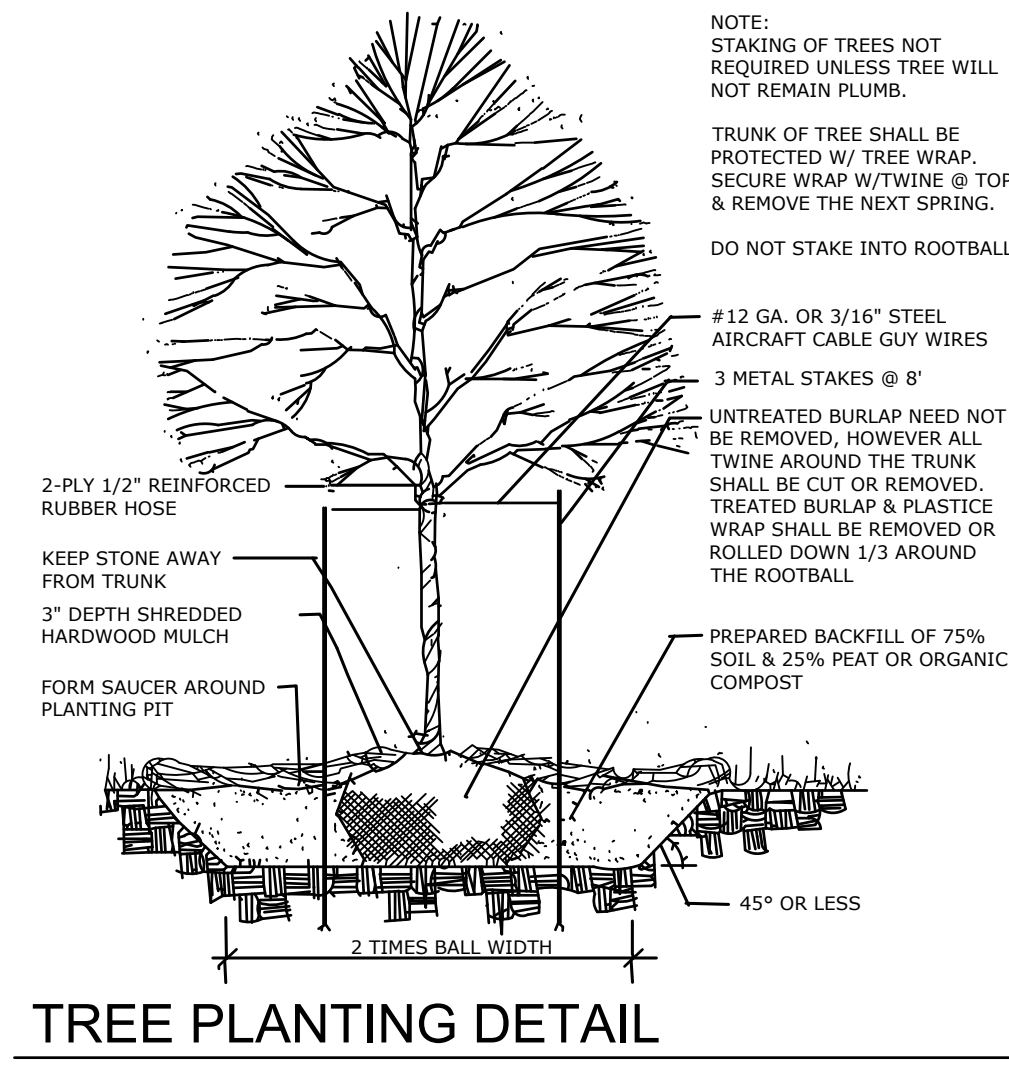

TREE PLANTING DETAIL  
NOT TO SCALE

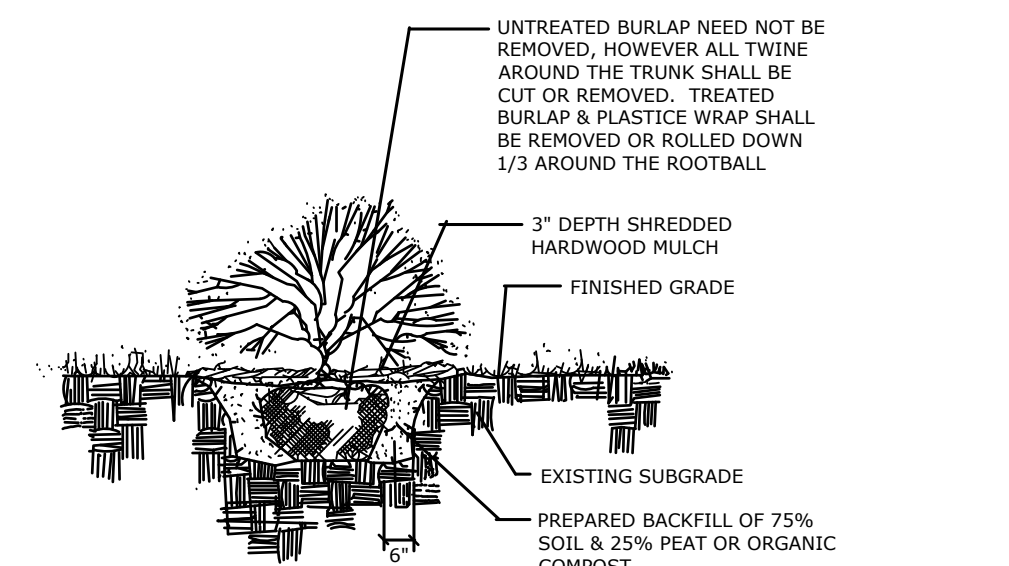

SHRUB PLANTING DETAIL  
NOT TO SCALE

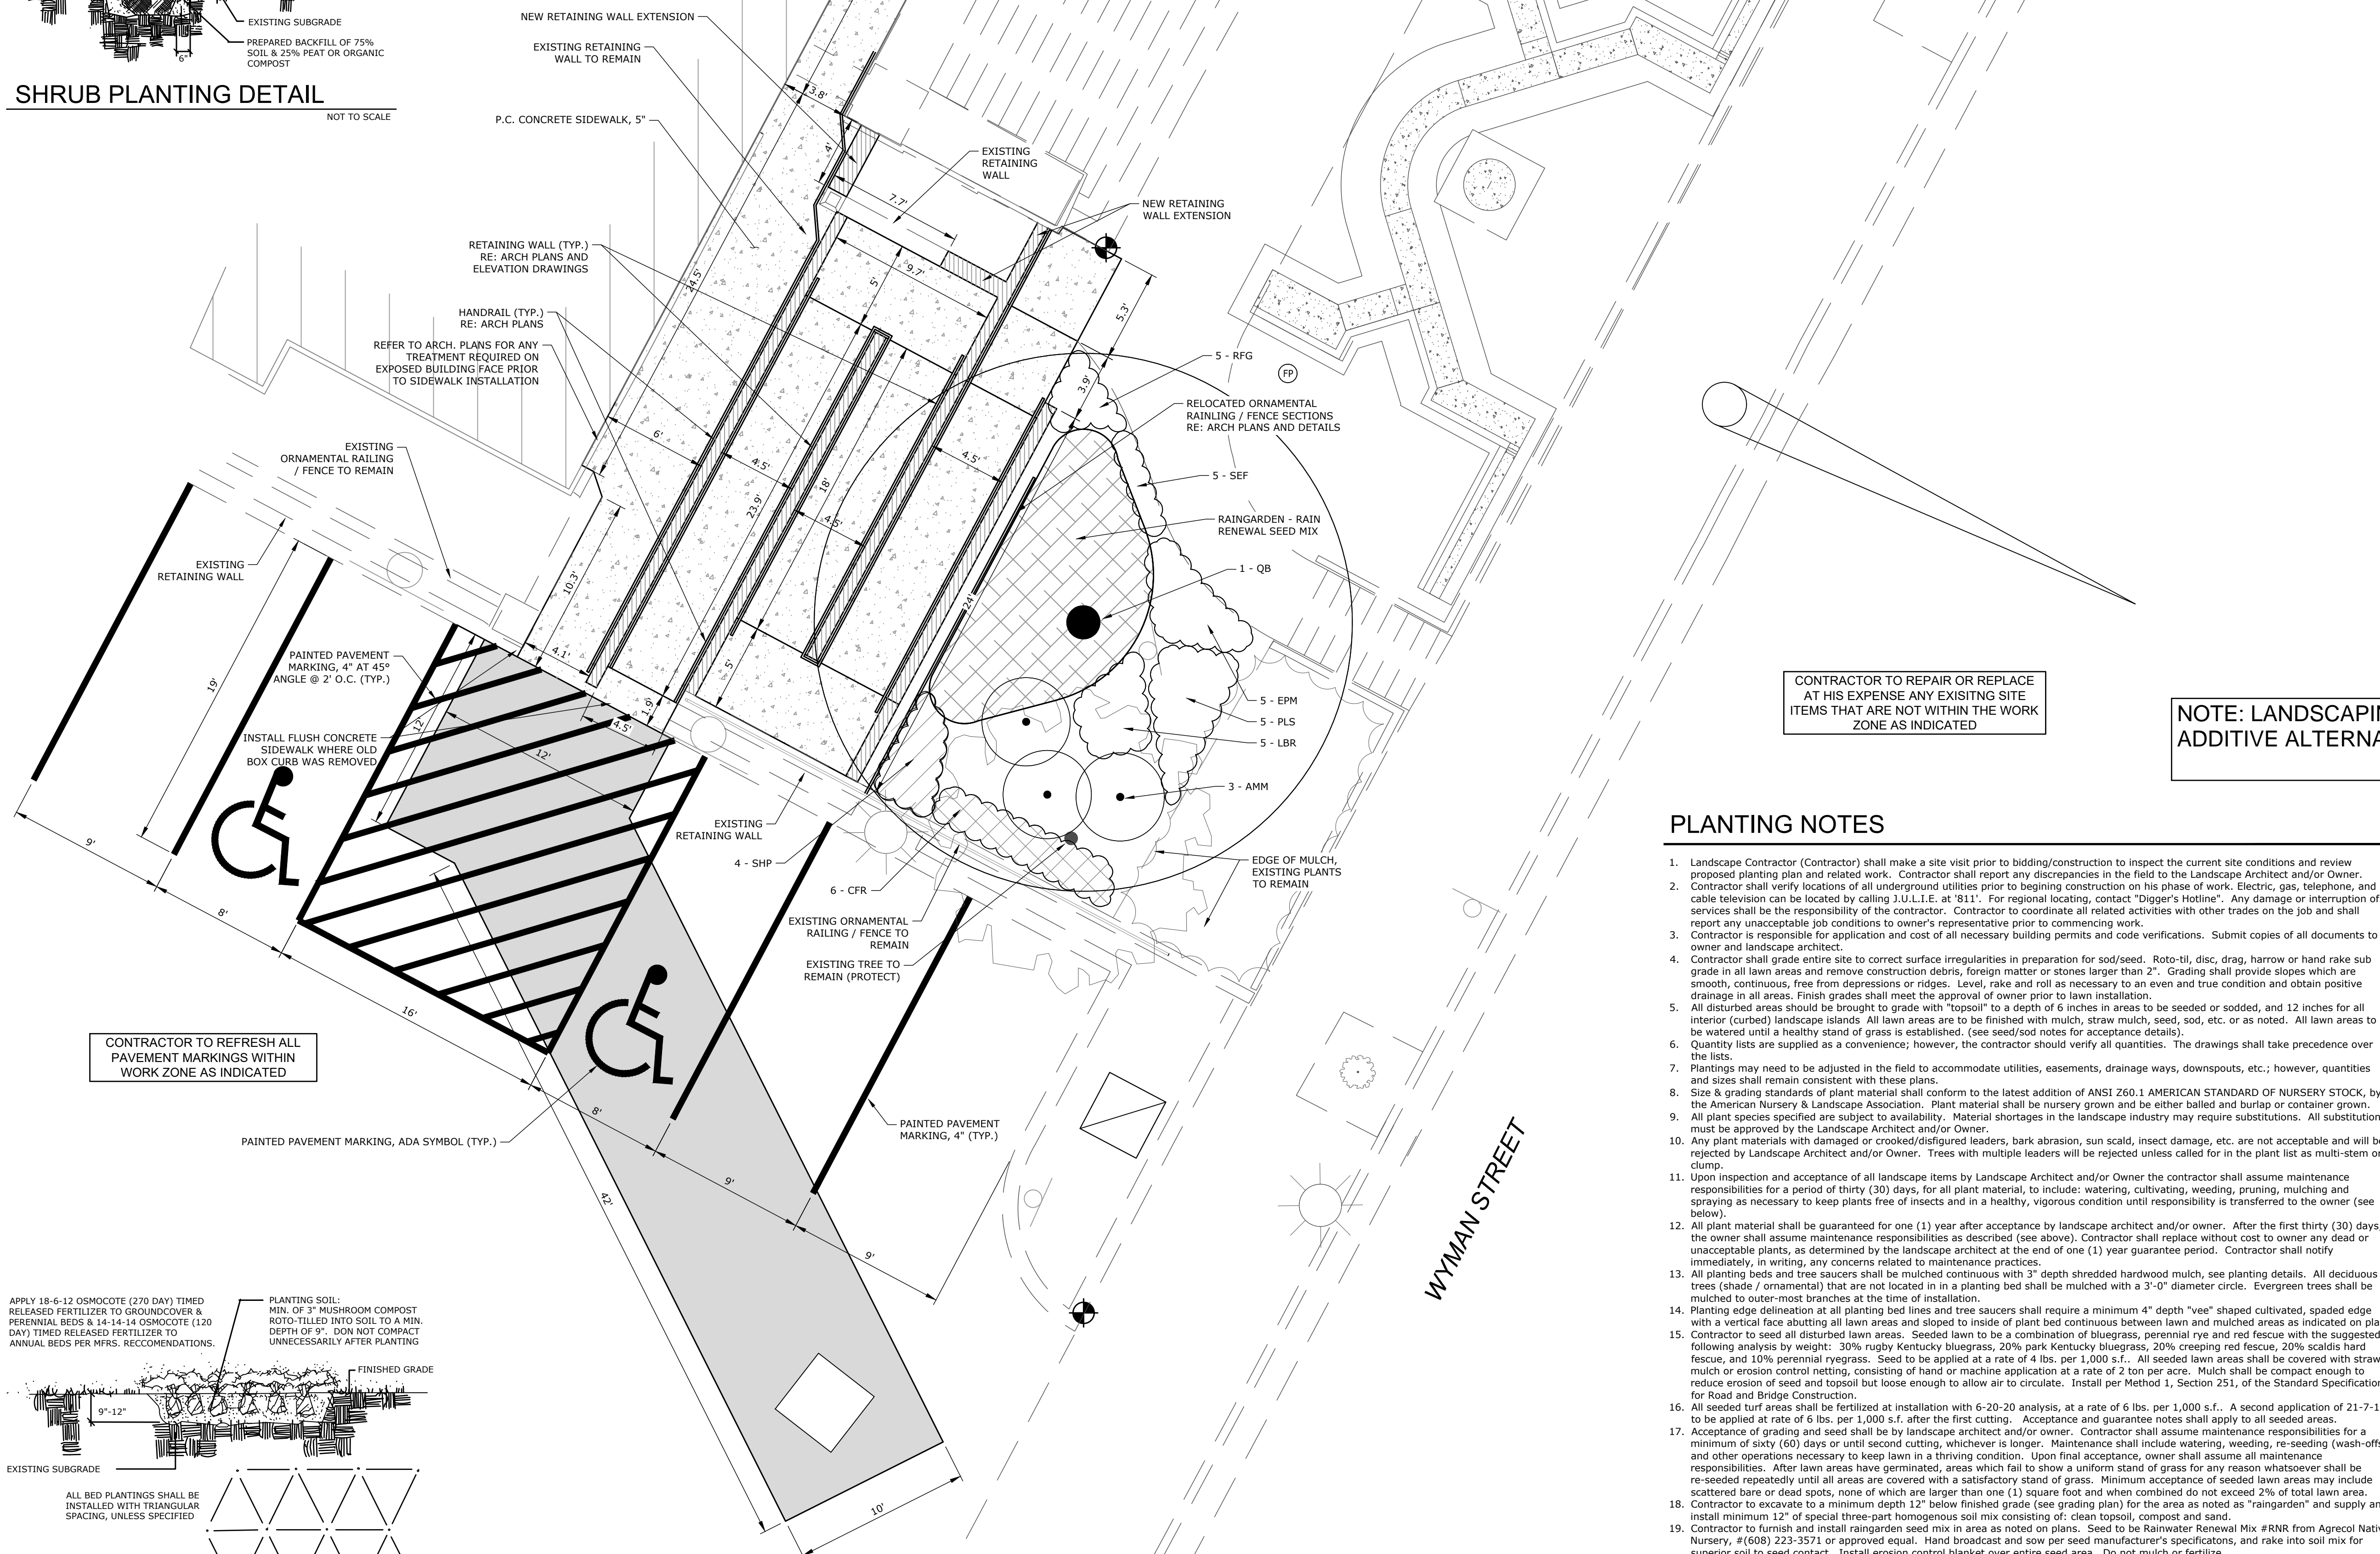


CONTRACTOR TO REPAIR OR REPLACE AT HIS EXPENSE ANY EXISTING SITE ITEMS THAT ARE NOT WITHIN THE WORK ZONE AS INDICATED

NOTE: LANDSCAPING WORK IS ADDITIVE ALTERNATE BID.

PLANTING NOTES

- Landscape Contractor (Contractor) shall make a site visit prior to bidding/construction to inspect the current site conditions and review proposed planting plan and related work. Contractor shall report any discrepancies in the field to the Landscape Architect and/or Owner.
- Contractor shall verify locations of all underground utilities prior to beginning construction on his phase of work. Electric, gas, telephone, and cable television can be located by calling J.U.L.I.E. at 811. For regional locating, contact "Digger's Hotline". Any damage or interruption of services shall be the responsibility of the contractor. Contractor to coordinate all related activities with other trades on the job and shall report any unacceptable job conditions to owner's representative prior to commencing work.
- Contractor is responsible for application and cost of all necessary building permits and code verifications. Submit copies of all documents to owner and landscape architect.
- Contractor shall grade entire site to correct surface irregularities in preparation for sod/seed. Roto-til, disc, drag, harrow or hand rake sub grade in all lawn areas and remove construction debris, foreign matter or stones larger than 2". Grading shall provide slopes which are smooth, continuous, free from depressions or ridges. Level, rake and roll as necessary to an even and true condition and obtain positive drainage in all areas. Finish grades shall meet the approval of owner prior to lawn installation.
- All disturbed areas should be brought to grade with "topsoil" to a depth of 6 inches in areas to be seeded or sodded, and 12 inches for all interior (curbed) landscape islands. All lawn areas are to be finished with mulch, straw mulch, seed, sod, etc. or as noted. All lawn areas to be watered until a healthy stand of grass is established. (See seed/sod notes for acceptance details).
- Quantity lists are supplied as a convenience; however, the contractor should verify all quantities. The drawings shall take precedence over the lists.
- Plantings may need to be adjusted in the field to accommodate utilities, easements, drainage ways, downspouts, etc.; however, quantities and sizes shall remain consistent with these plans.
- Size & grading standards of plant material shall conform to the latest addition of ANSI Z66.1 AMERICAN STANDARD OF NURSERY STOCK, by the American Nursery & Landscape Association. Plant material shall be nursery grown and be either balled and burlap or container grown.
- All plant species specified are subject to availability. Material shortages in the landscape industry may require substitutions. All substitutions must be approved by the Landscape Architect and/or Owner.
- Any plant materials with damaged or crooked/disfigured leaders, bark abrasion, sun scald, insect damage, etc. are not acceptable and will be rejected by Landscape Architect and/or Owner. Trees with multiple leaders will be rejected unless called for in the plant list as multi-stem or clump.
- Upon inspection and acceptance of all landscape items by Landscape Architect and/or Owner the contractor shall assume maintenance responsibilities for a period of thirty (30) days, for all plant material, to include: watering, cultivating, weeding, pruning, mucking and spraying as necessary to keep plants free of insects and in a healthy, vigorous condition until responsibility is transferred to the owner (see below).
- All plant material shall be guaranteed for one (1) year after acceptance by landscape architect and/or owner. After the first thirty (30) days, the owner shall assume maintenance responsibilities as described (see above). Contractor shall replace without cost to owner any dead or unacceptable plants, as determined by the landscape architect at the end of one (1) year guarantee period. Contractor shall notify immediately, in writing, any concerns related to maintenance practices.
- All planting beds and tree saucers shall be mulched continuous with 3" depth shredded hardwood mulch, see planting details. All deciduous trees (shade / ornamentals) that are not located in a planting bed shall be mulched with a 2"-4" diameter circle. Evergreen trees shall be mulched to outer-most branches at the time of installation.
- Planting edge delineation at all planting beds and tree saucers shall require a minimum 4" depth "vee" shaped cultivated, spaded edge with a vertical face abutting all lawn areas and sloped to inside of plant bed continuous between lawn and mulched areas as indicated on plan.
- Contractor to seed all disturbed lawn areas. Seeded lawn to be a combination of bluegrass, perennial rye and red fescue with the suggested following analysis by weight: 30% rusty Kentucky bluegrass, 20% dark Kentucky bluegrass, 20% creeping red fescue, 20% scalds hard fescue, and 10% perennial ryegrass. Seed to be applied at a rate of 4 lbs. per 1,000 s.f.. All seeded lawn areas shall be covered with straw mulch or erosion control netting, consisting of hand or machine application at a rate of 2 ton per acre. Mulch shall be compact enough to reduce erosion of seed and topsoil but loose enough to allow air to circulate. Install per Method 1, Section 251, of the Standard Specifications for Road and Bridge Construction.
- All seeded turf areas shall be fertilized at installation with 6-20-20 analysis, at a rate of 6 lbs. per 1,000 s.f.. A second application of 21-7-14 to be applied at rate of 6 lbs. per 1,000 s.f. after the first cutting. Acceptance and guarantee notes shall apply to all seeded areas.
- Acceptance of grading and seed shall be by landscape architect and/or owner. Contractor shall assume maintenance responsibilities for a minimum of sixty (60) days or until second cutting, whichever is longer. Maintenance shall include watering, weeding, re-seeding (wash-offs) and other operations necessary to keep lawn in a thriving condition. Upon final acceptance, owner shall assume all maintenance responsibilities. After lawn areas have germinated, areas which fail to show a uniform stand of grass for any reason whatsoever shall be re-seeded repeatedly until all areas are covered with a satisfactory stand of grass. Minimum acceptance of seeded lawn areas may include scattered bare or dead spots, none of which are larger than one (1) square foot and when combined do not exceed 2% of total lawn area.
- Contractor to excavate to a minimum depth 12" below finished grade (see grading plan) for the area as noted as 'raingarden' and supply and install minimum 12" of special three-part homogeneous soil mix consisting of: clean topsoil, compost and sand.
- Contractor to furnish and install raingarden seed mix in area as noted on plans. Seed to be Rainwater Renewal Mix RRNM from Agropec Native Nursery, # (608) 223-3571 or approved equal. Hand broadcast and sow per seed manufacturer's specifications, and rake into soil mix for superior soil to seed contact. Install erosion control blanket over entire seed area. Do not mulch or fertilize.

LEGEND

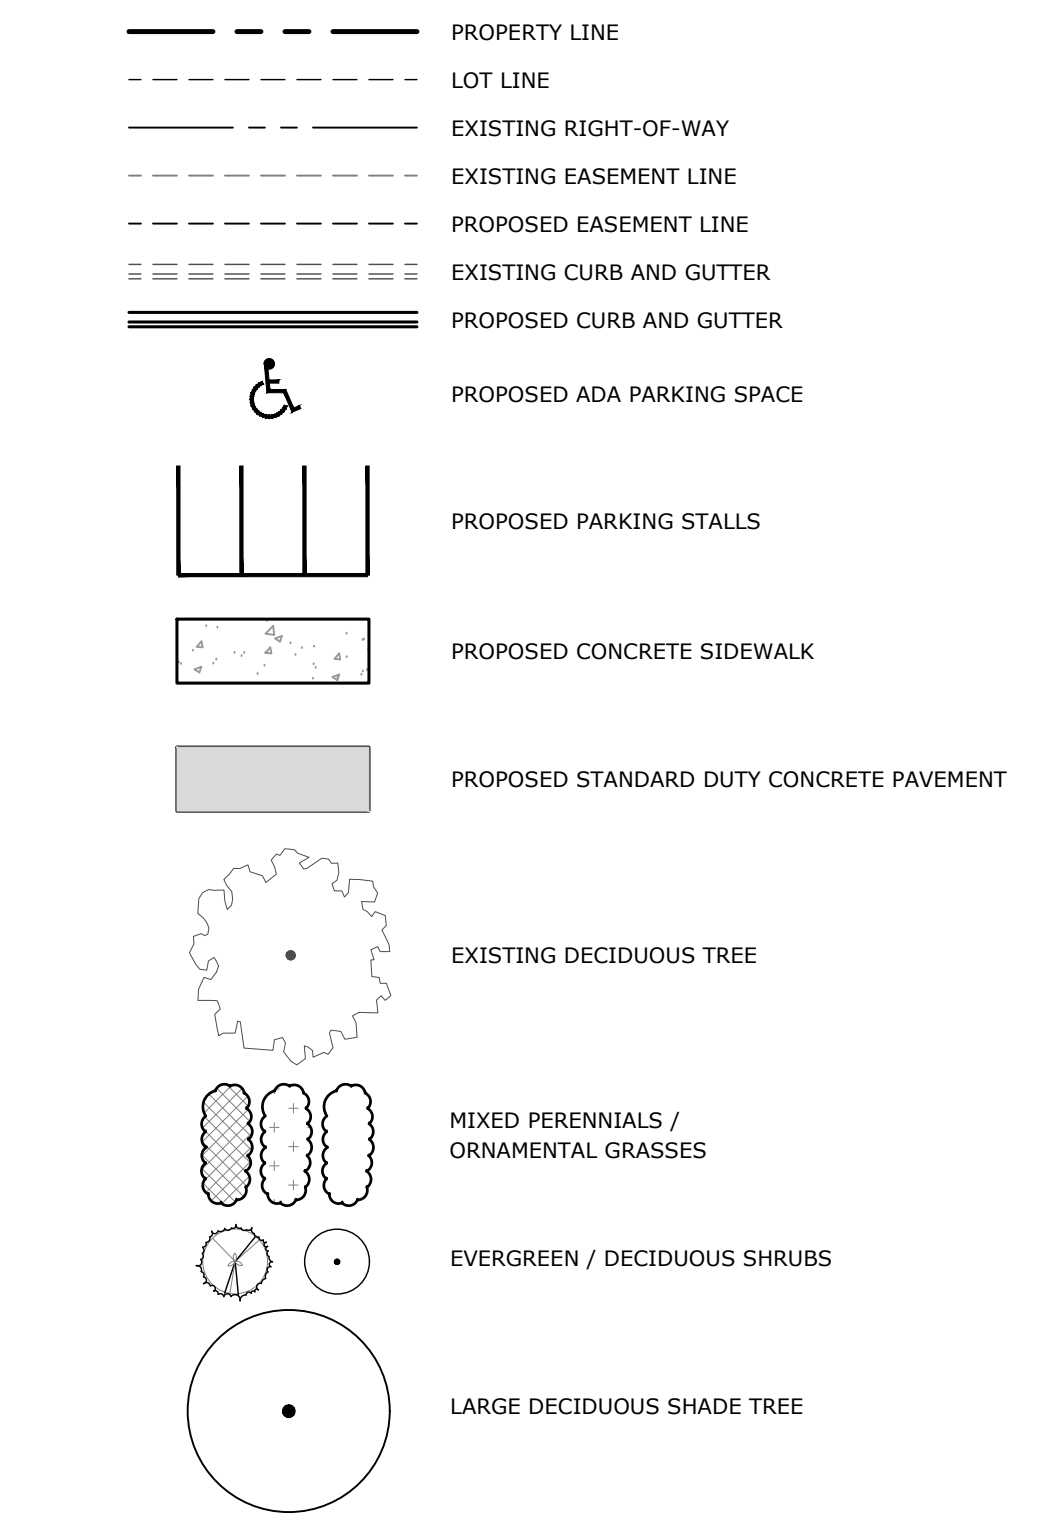


LAYOUT NOTES

- THE CONTRACTOR SHALL FIELD VERIFY THE ELEVATIONS OF THE BENCHMARKS PRIOR TO COMMENCING WORK. THE CONTRACTOR SHALL ALSO FIELD VERIFY LOCATION AND ELEVATION OF EXISTING PIPE INVERTS, FLOOR ELEVATIONS, CURB OR PAVEMENT WHERE MATCHING INTO EXISTING WORK. THE CONTRACTOR SHALL FIELD VERIFY HORIZONTAL CONTROL BY REFERENCING SHOWN COORDINATES TO KNOWN PROPERTY LINES. NOTIFY ENGINEER OF DISCREPANCIES IN EITHER VERTICAL OR HORIZONTAL CONTROL PRIOR TO PROCEEDING WITH WORK.
- REFER TO ARCHITECTURAL PLANS FOR EXACT BUILDING DIMENSIONS.
- DIMENSIONS THAT LOCATE THE BUILDING ARE MEASURED TO THE OUTSIDE FACE OF THE BUILDING.
- SIGN CONSTRUCTION AND PAVEMENT MARKINGS SHALL CONFORM TO THE REQUIREMENTS OF THE MANUAL ON UNIFORM TRAFFIC CONTROL DEVICES, CURRENT EDITION.
- COORDINATE WORK WITHIN R.O.W. WITH CITY OF ROCKFORD. TRAFFIC CONTROL SHALL CONFORM TO IDOT STANDARDS OF WORK WITHIN THE R.O.W.
- ALL RADII ARE DIMENSIONED TO THE EDGE OF PAVEMENT.
- SOME FIELD ADJUSTMENTS MAY BE NECESSARY AT POINTS WHERE PROPOSED PAVEMENT, CURB AND SIDEWALKS MEET EXISTING PAVEMENT, CURB AND SIDEWALKS. REVIEW ANY REQUIRED CHANGES WITH ENGINEER PRIOR TO CONSTRUCTION OF WORK.

PLANT LIST


KEY	QTY	Botanical name COMMON NAME	SIZE	REMARKS
QB	1	Quercus bicolor SWAMP WHITE OAK	2.5"	
AMM	3	Aronia melanocarpa "Morton" IRIQUOUS BEAUTY CHOKEBERRY	24" 5 GAL	
CFR	6	Calamagrostis acutiflora "Karl Foerster" FEATHER REED GRASS	GAL	3'-0" O.C. - ORN. GRASS
EPH	5	Echinacea purpurea "Magnus" PURPLE CONEFLOWER	GAL	2'-0" O.C. - PERENNIAL
LBR	5	Ligularia "Bottle Rocket" BOTTLE ROCKET LIGULARIA	GAL	2'-6" O.C. - PERENNIAL
PLS	5	Perovskia atriplicifolia "Little Spire" LITTLE SPIRE RUSSIAN SAGE	GAL	2'-6" O.C. - PERENNIAL
RFG	5	Rudbeckia fulgida "Goldsturm" BLACK-EYED SUSAN	GAL	2'-0" O.C. - PERENNIAL
SEF	5	Saxia "Eck Friesland" EAST FRIESLAND SALVIA	GAL	2'-0" O.C. - PERENNIAL
SHP	4	Sporobolus heterolepis PRAIRIE DROPSSEED	GAL	3'-0" O.C. - ORN. GRASS

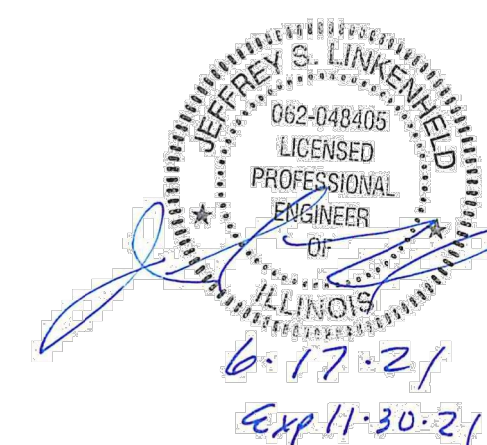

LAYOUT AND LANDSCAPE PLAN

5291 ZENITH PARKWAY  
LOVES PARK, IL 61111  
VOICE: (815) 484-4300  
FAX: (815) 484-4303

www.arcdesign.com  
Illinois Design Firm License No. 184-001334

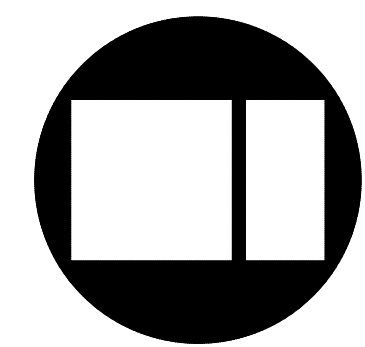

PROGRESS PRINT  
Not For Construction  
Date: 06-08-2021  
LARSON & DARBY GROUP  
architecture-engineering-interiors


COPYRIGHT 2021  
All drawn and written information appearing herein shall not be duplicated, disclosed, or otherwise used without the written consent of Larson & Darby Group.

ISSUED FOR:	DATE:
PROJECT NUMBER:	30271
SHEET NUMBER:	C02
DRAWN:	APPROVED:

DATE: 6-18-2021  
PROJECT NUMBER: 30271  
SHEET NUMBER: C02



TW = TOP OF WALK ELEVATION ONLY.  
REFER TO ARCH. PLANS FOR WALL  
DESIGN AND ELEVATION INFORMATION

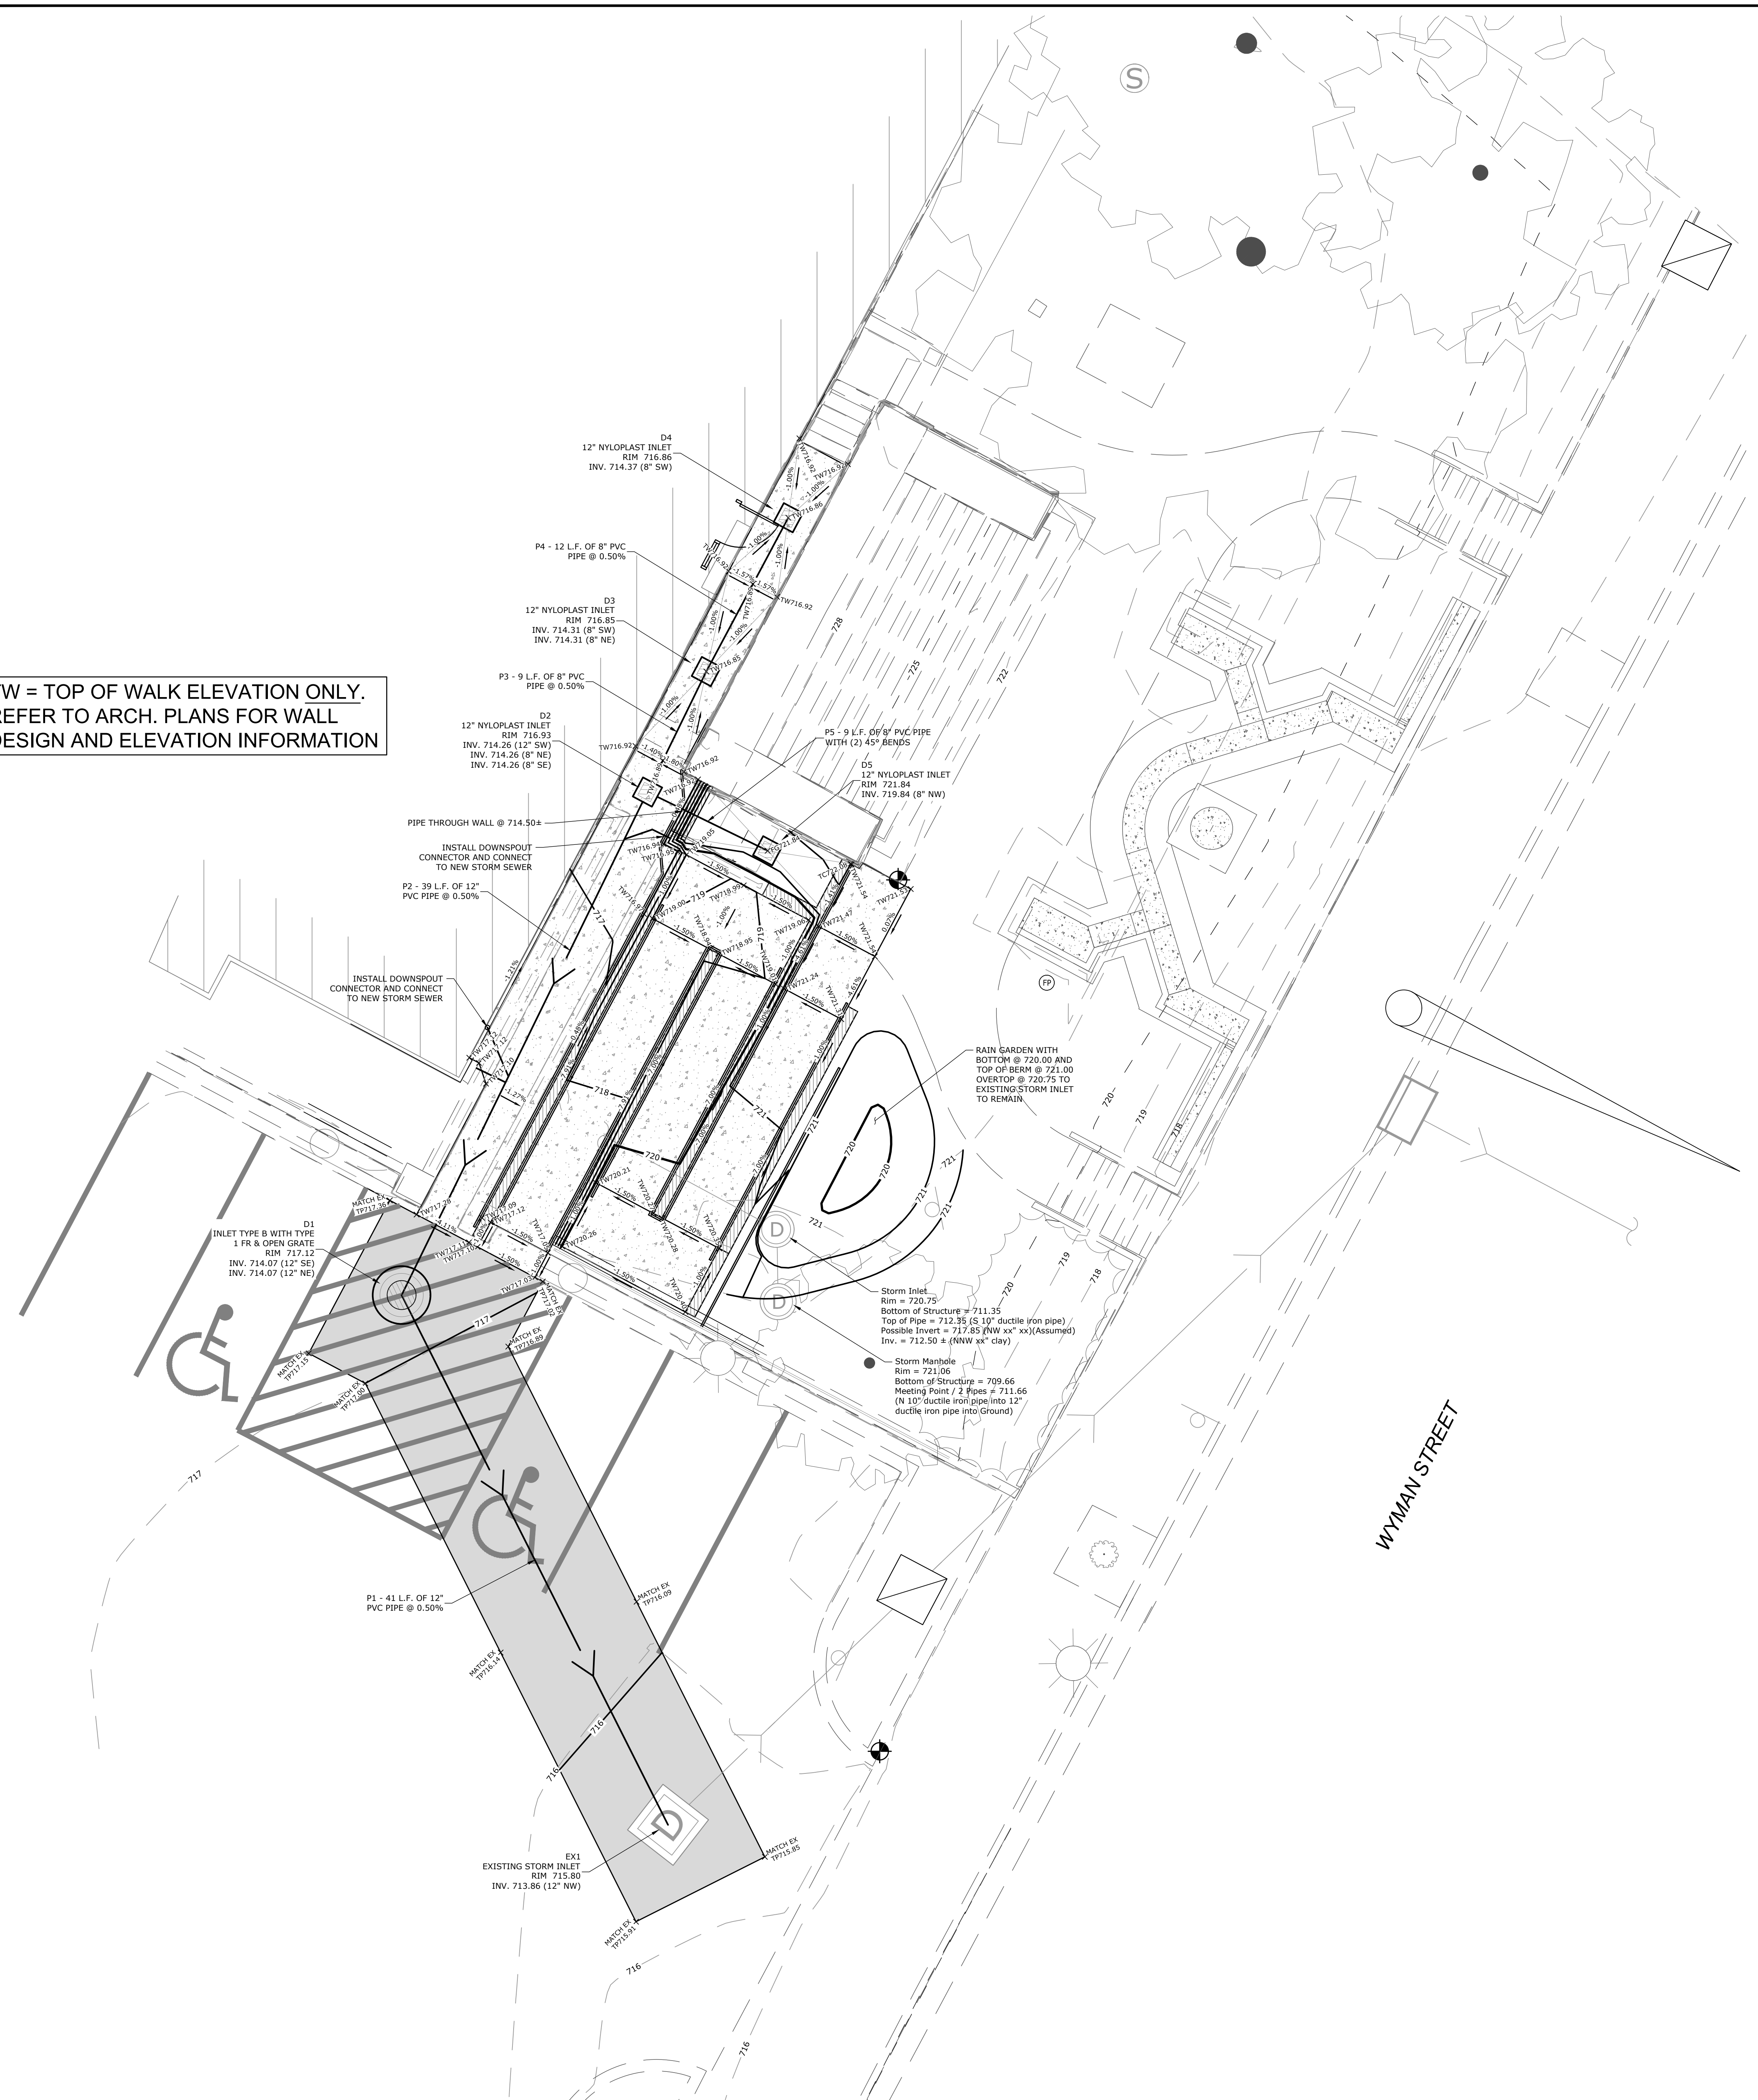


**LEGEND**

- PROPERTY LINE
- LOT LINE
- EXISTING RIGHT-OF-WAY
- PROPOSED CURB AND GUTTER
- EXISTING CURB AND GUTTER
- PROPOSED STORM SEWER
- EXISTING STORM SEWER
- PROPOSED GRADE BREAK LINE
- EXISTING GRADE BREAK LINE
- PROPOSED CONTOUR LINE
- EXISTING CONTOUR LINE
- TOP OF WALK ELEVATION
- TOP OF CURB ELEVATION
- FINISHED GRADE ELEVATION
- TOP OF WALL ELEVATION
- BENCHMARK
- EXISTING MANHOLE OR INLET
- PROPOSED INLET OR MANHOLE
- PROPOSED CLEANOUT
- 1.6% DIRECTION OF SHEET FLOW

**GRADING NOTES**

1. THE CONTRACTOR SHALL FIELD VERIFY THE ELEVATIONS OF THE BENCHMARKS PRIOR TO COMMENCING WORK. THE CONTRACTOR SHALL ALSO FIELD VERIFY LOCATION AND ELEVATION OF EXISTING PIPE INVERTS, FLOOR ELEVATIONS CURB OR PAVEMENT WHERE MATCHING INTO EXISTING WORK. THE CONTRACTOR SHALL FIELD VERIFY HORIZONTAL OR VERTICAL CONTROL POINTS PRIOR TO PROCEEDING WITH WORK.
2. ALL UNSURFACED AREAS ARE TO RECEIVE FOUR INCHES OF TOPSOIL AND SOODED (OR SEED) WHERE NOTED) AND WATERED UNTIL A HEALTHY STAND OF GRASS IS OBTAINED.
3. ALL STORM SEWER PIPE IS TO BE REINFORCED CONCRETE CULVERT PIPE CLASS IV UNLESS OTHERWISE NOTED. WHERE HDPE OR PVC PIPE IS LISTED AS ACCEPTABLE MATERIALS, PVC SDR 35, HDPE DOUBLE WALL (ADS N-12), OR PVC SCHEDULE 40 MAY BE USED AT THE CONTRACTOR'S DISCRETION.
4. THE MAXIMUM SLOPE RATIO ON CUT/FILL SLOPES IS 3.5 HORIZONTAL TO 1 VERTICAL.
5. PROPERTY CORNERS SHALL BE CAREFULLY PROTECTED UNTIL THEY HAVE BEEN REFERENCED BY A PROFESSIONAL LAND SURVEYOR. PROPERTY MONUMENTS DISTURBED BY THE CONTRACTOR'S OPERATION SHALL BE REPLACED AT THE CONTRACTOR'S EXPENSE.
6. CONTRACTOR SHALL SET ALL CLEANOUT, MANHOLE AND INLET CASTINGS, FIRE HYDRANTS AND VALVE BOXES TO FINISHED GRADE.
7. ALL PROPOSED PAVED AREAS SHALL BE STRIPPED OF ALL TOPSOIL AND UNSUITABLE MATERIAL AND ENCAVATED OR FILLED TO WITHIN 0.10 FEET OF DESIGN SURGRADE.
8. THE EARTHWORK CONTRACTOR IS RESPONSIBLE FOR MAINTAINING POSITIVE DRAINAGE AT THE CONCLUSION OF EACH WORKING DAY.
9. ROOF AND CANOPY DRAIN SHALL INCORPORATE BOOT PER DETAIL. 6" PVC PIPE SHALL EXTEND TO A MAIN AS SHOWN ON THE PLAN. POSITIVE DRAINAGE SHALL BE MAINTAINED TOWARD MAIN AT 1.0% MINIMUM SLOPE. 6" PVC CONNECTION TO BE MADE WITH INSERT-A-TEE OR ENGINEER APPROVED EQUIVALENT BETWEEN DISSIMILAR MATERIALS.

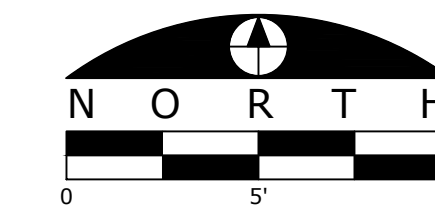

**BENCHMARKS**


DESCRIPTION	ELEVATION (USGS)
BENCHMARK 1 CHISELED SQUARE	716.52

**GRADING AND DRAINAGE PLAN**



5291 ZENITH PARKWAY  
LOVES PARK, IL 61111  
VOICE: (815) 484-4300  
FAX: (815) 484-4303

www.arcdesign.com  
Illinois Design Firm License No. 184-001334

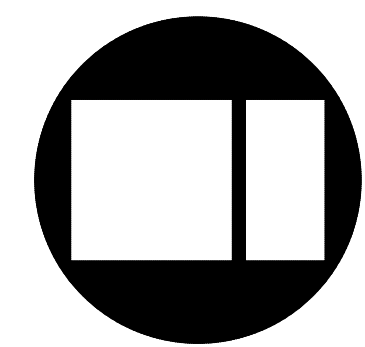

PROGRESS PRINT  
Not For Construction  
Date: 06-08-2021  
LARSON & DARBY GROUP  
architecture-engineering-interiors











ACCESSIBILITY RAMP STUDY  
VETERANS MEMORIAL HALL  
ROCKFORD, ILLINOIS

COPYRIGHT 2021  
All drawn and written information appearing herein shall not be duplicated, disclosed, or otherwise used without the written consent of Larson & Darby Group.

ISSUED FOR:	DATE:
DRAWN	APPROVED

DATE: 6-18-2021
PROJECT NUMBER: 30271
SHEET NUMBER: C03



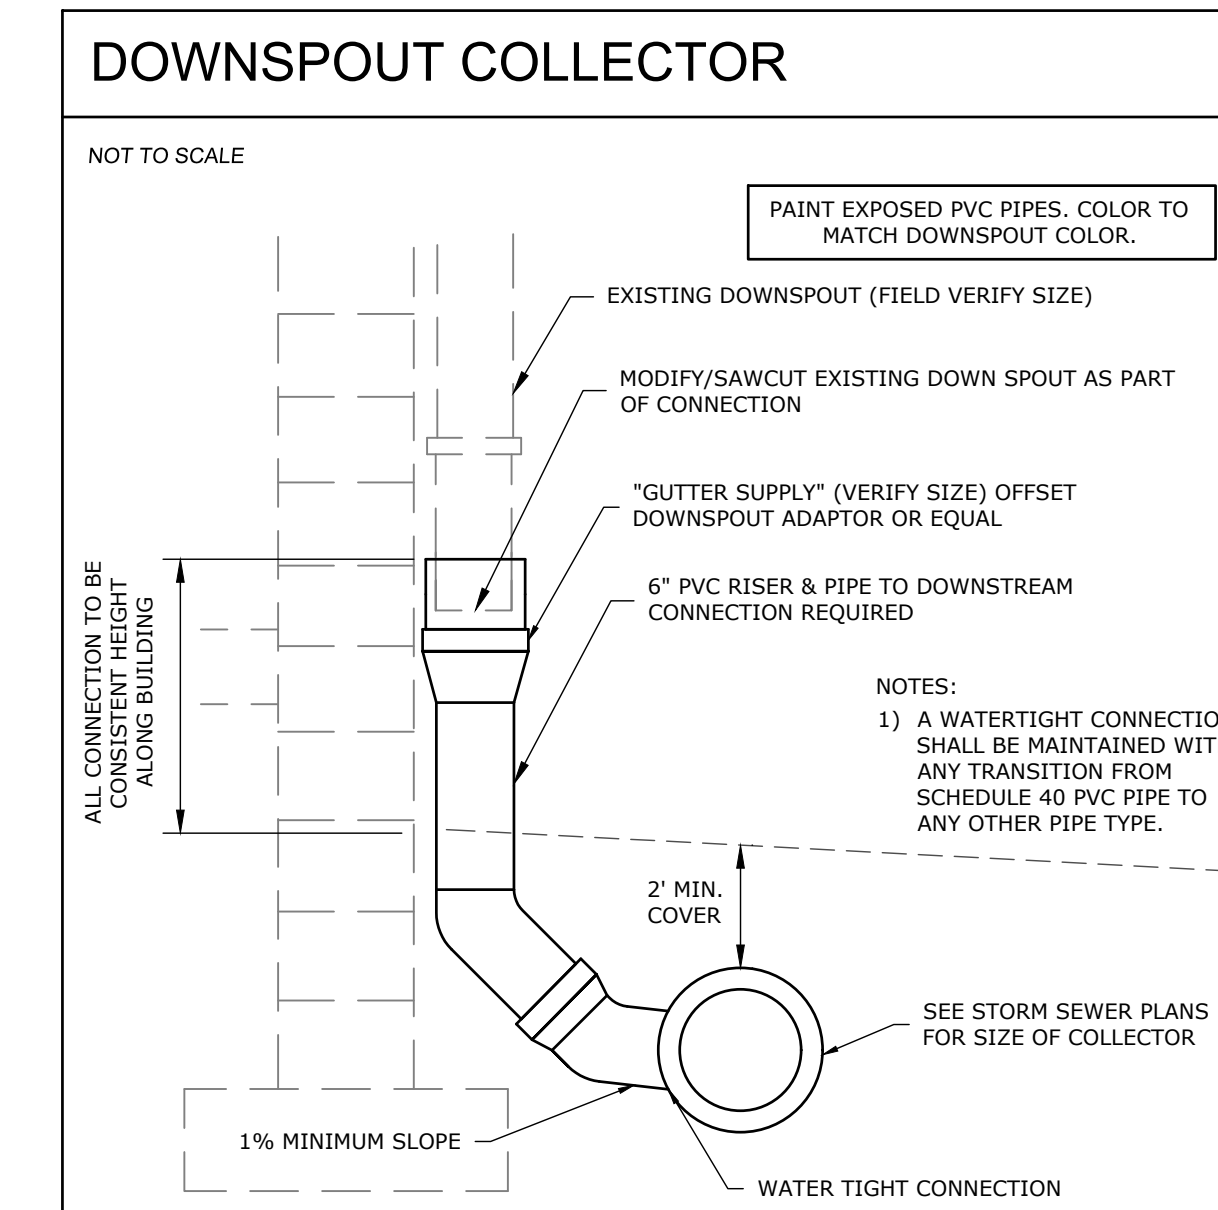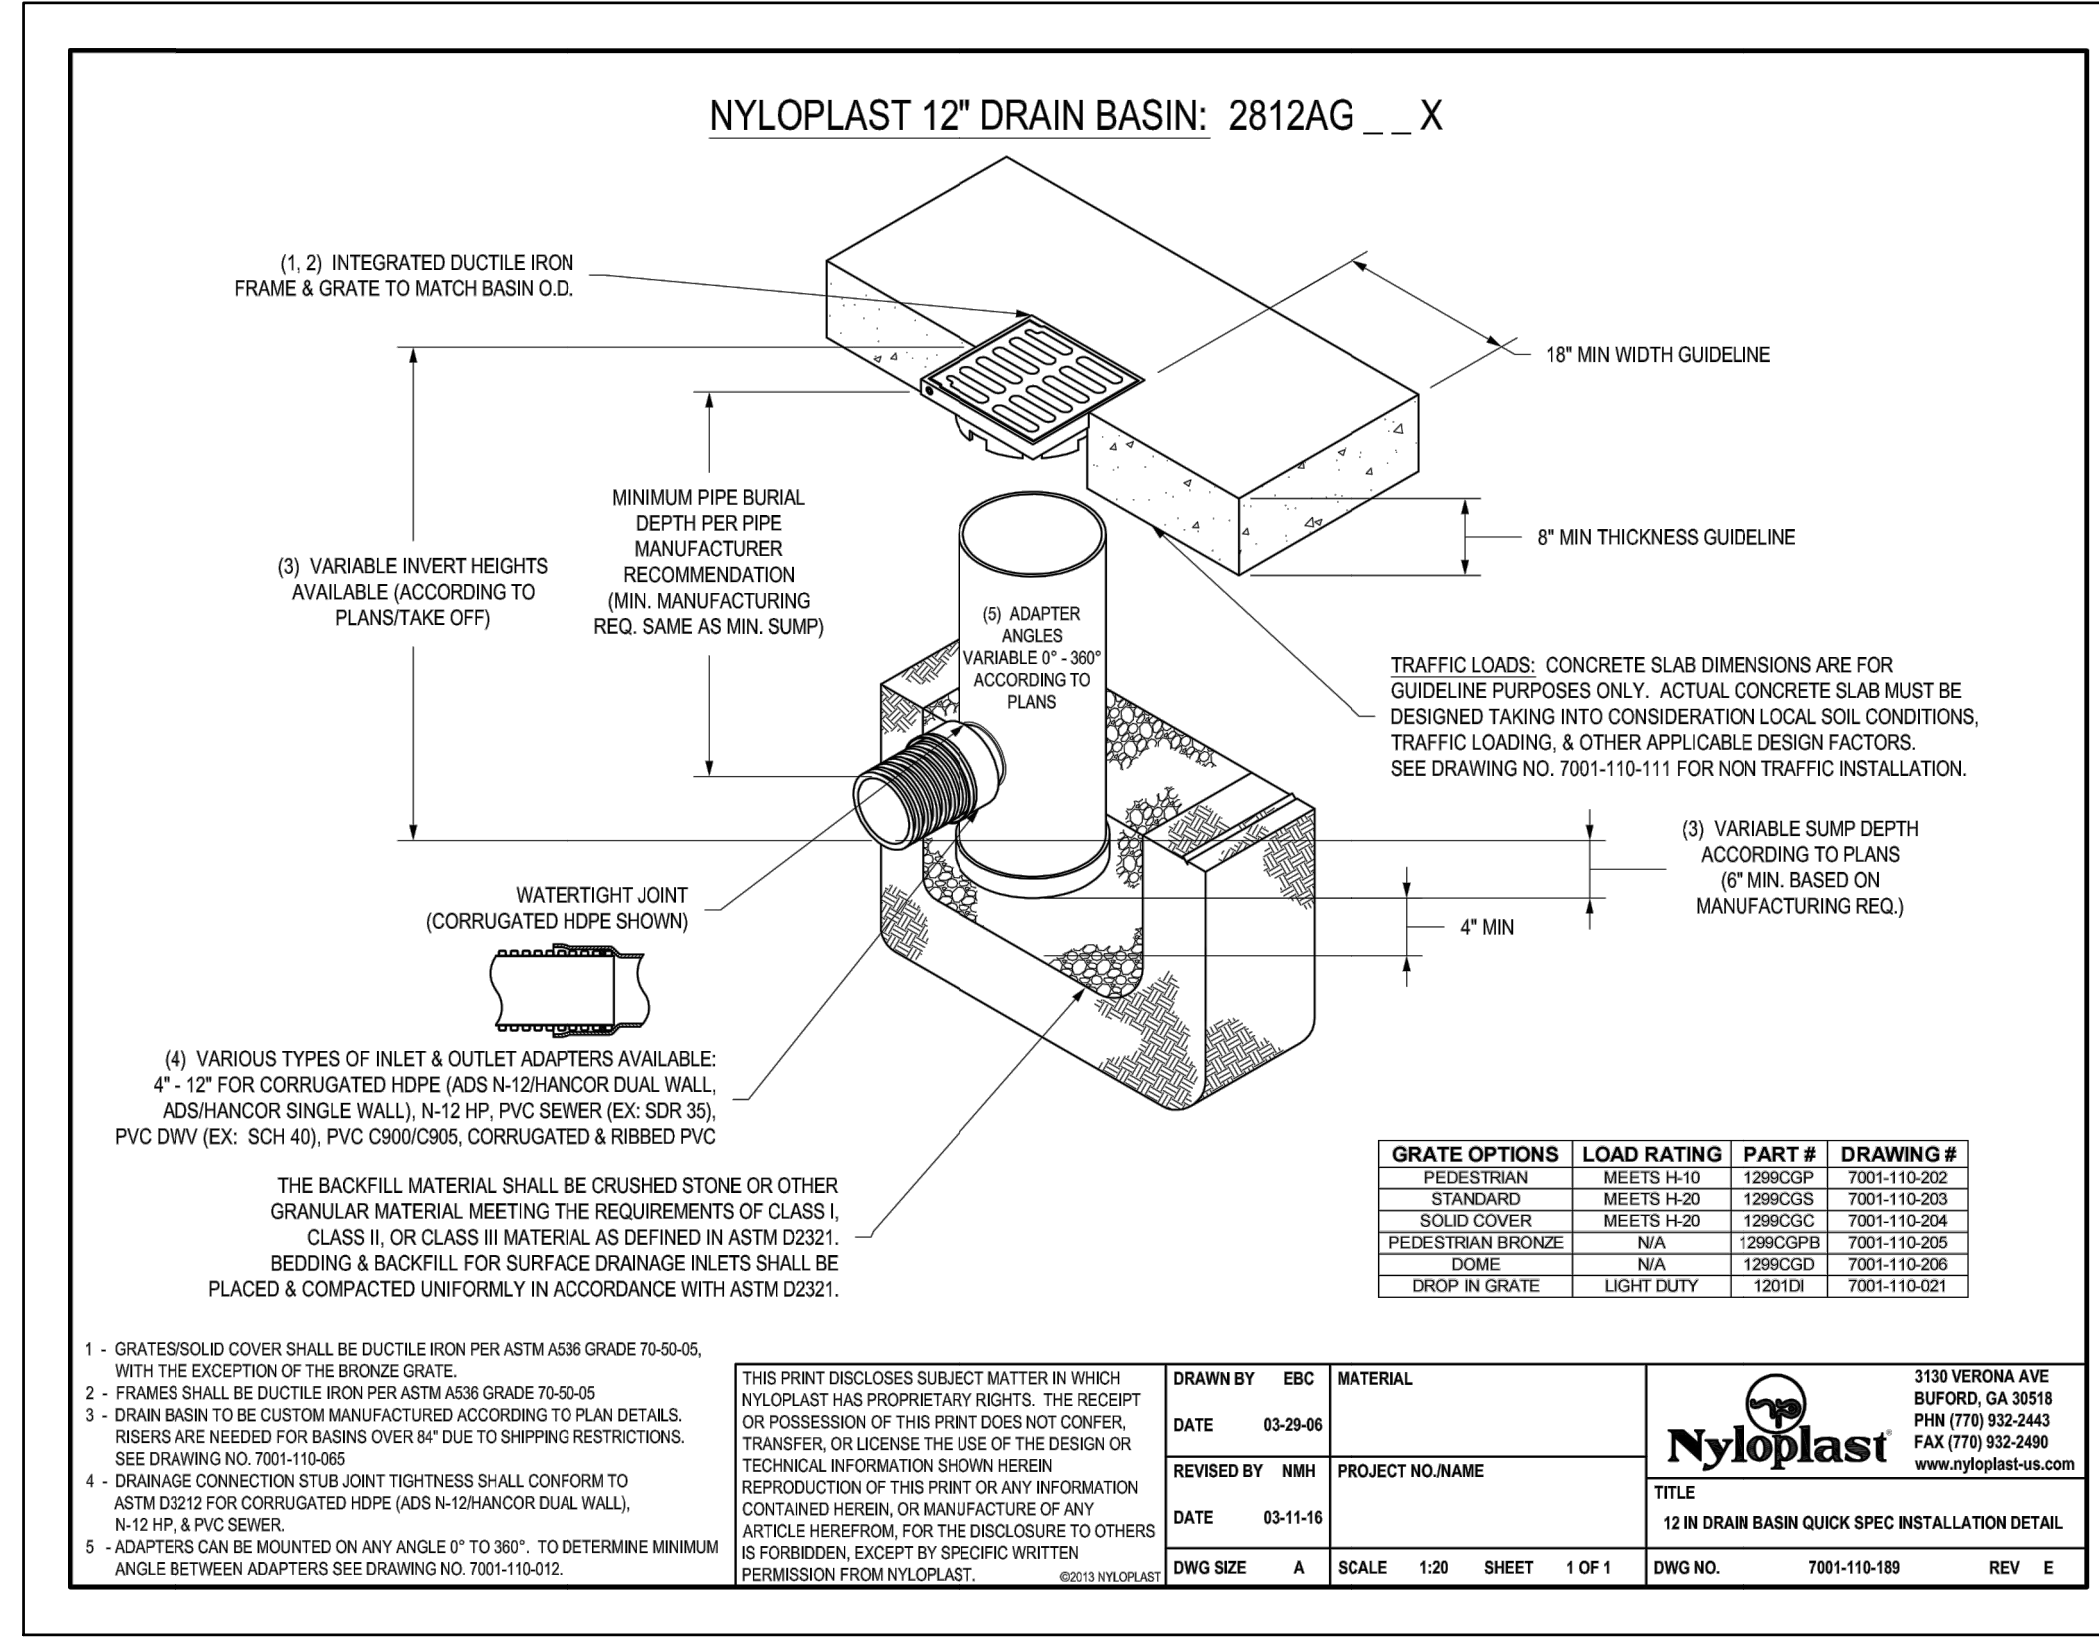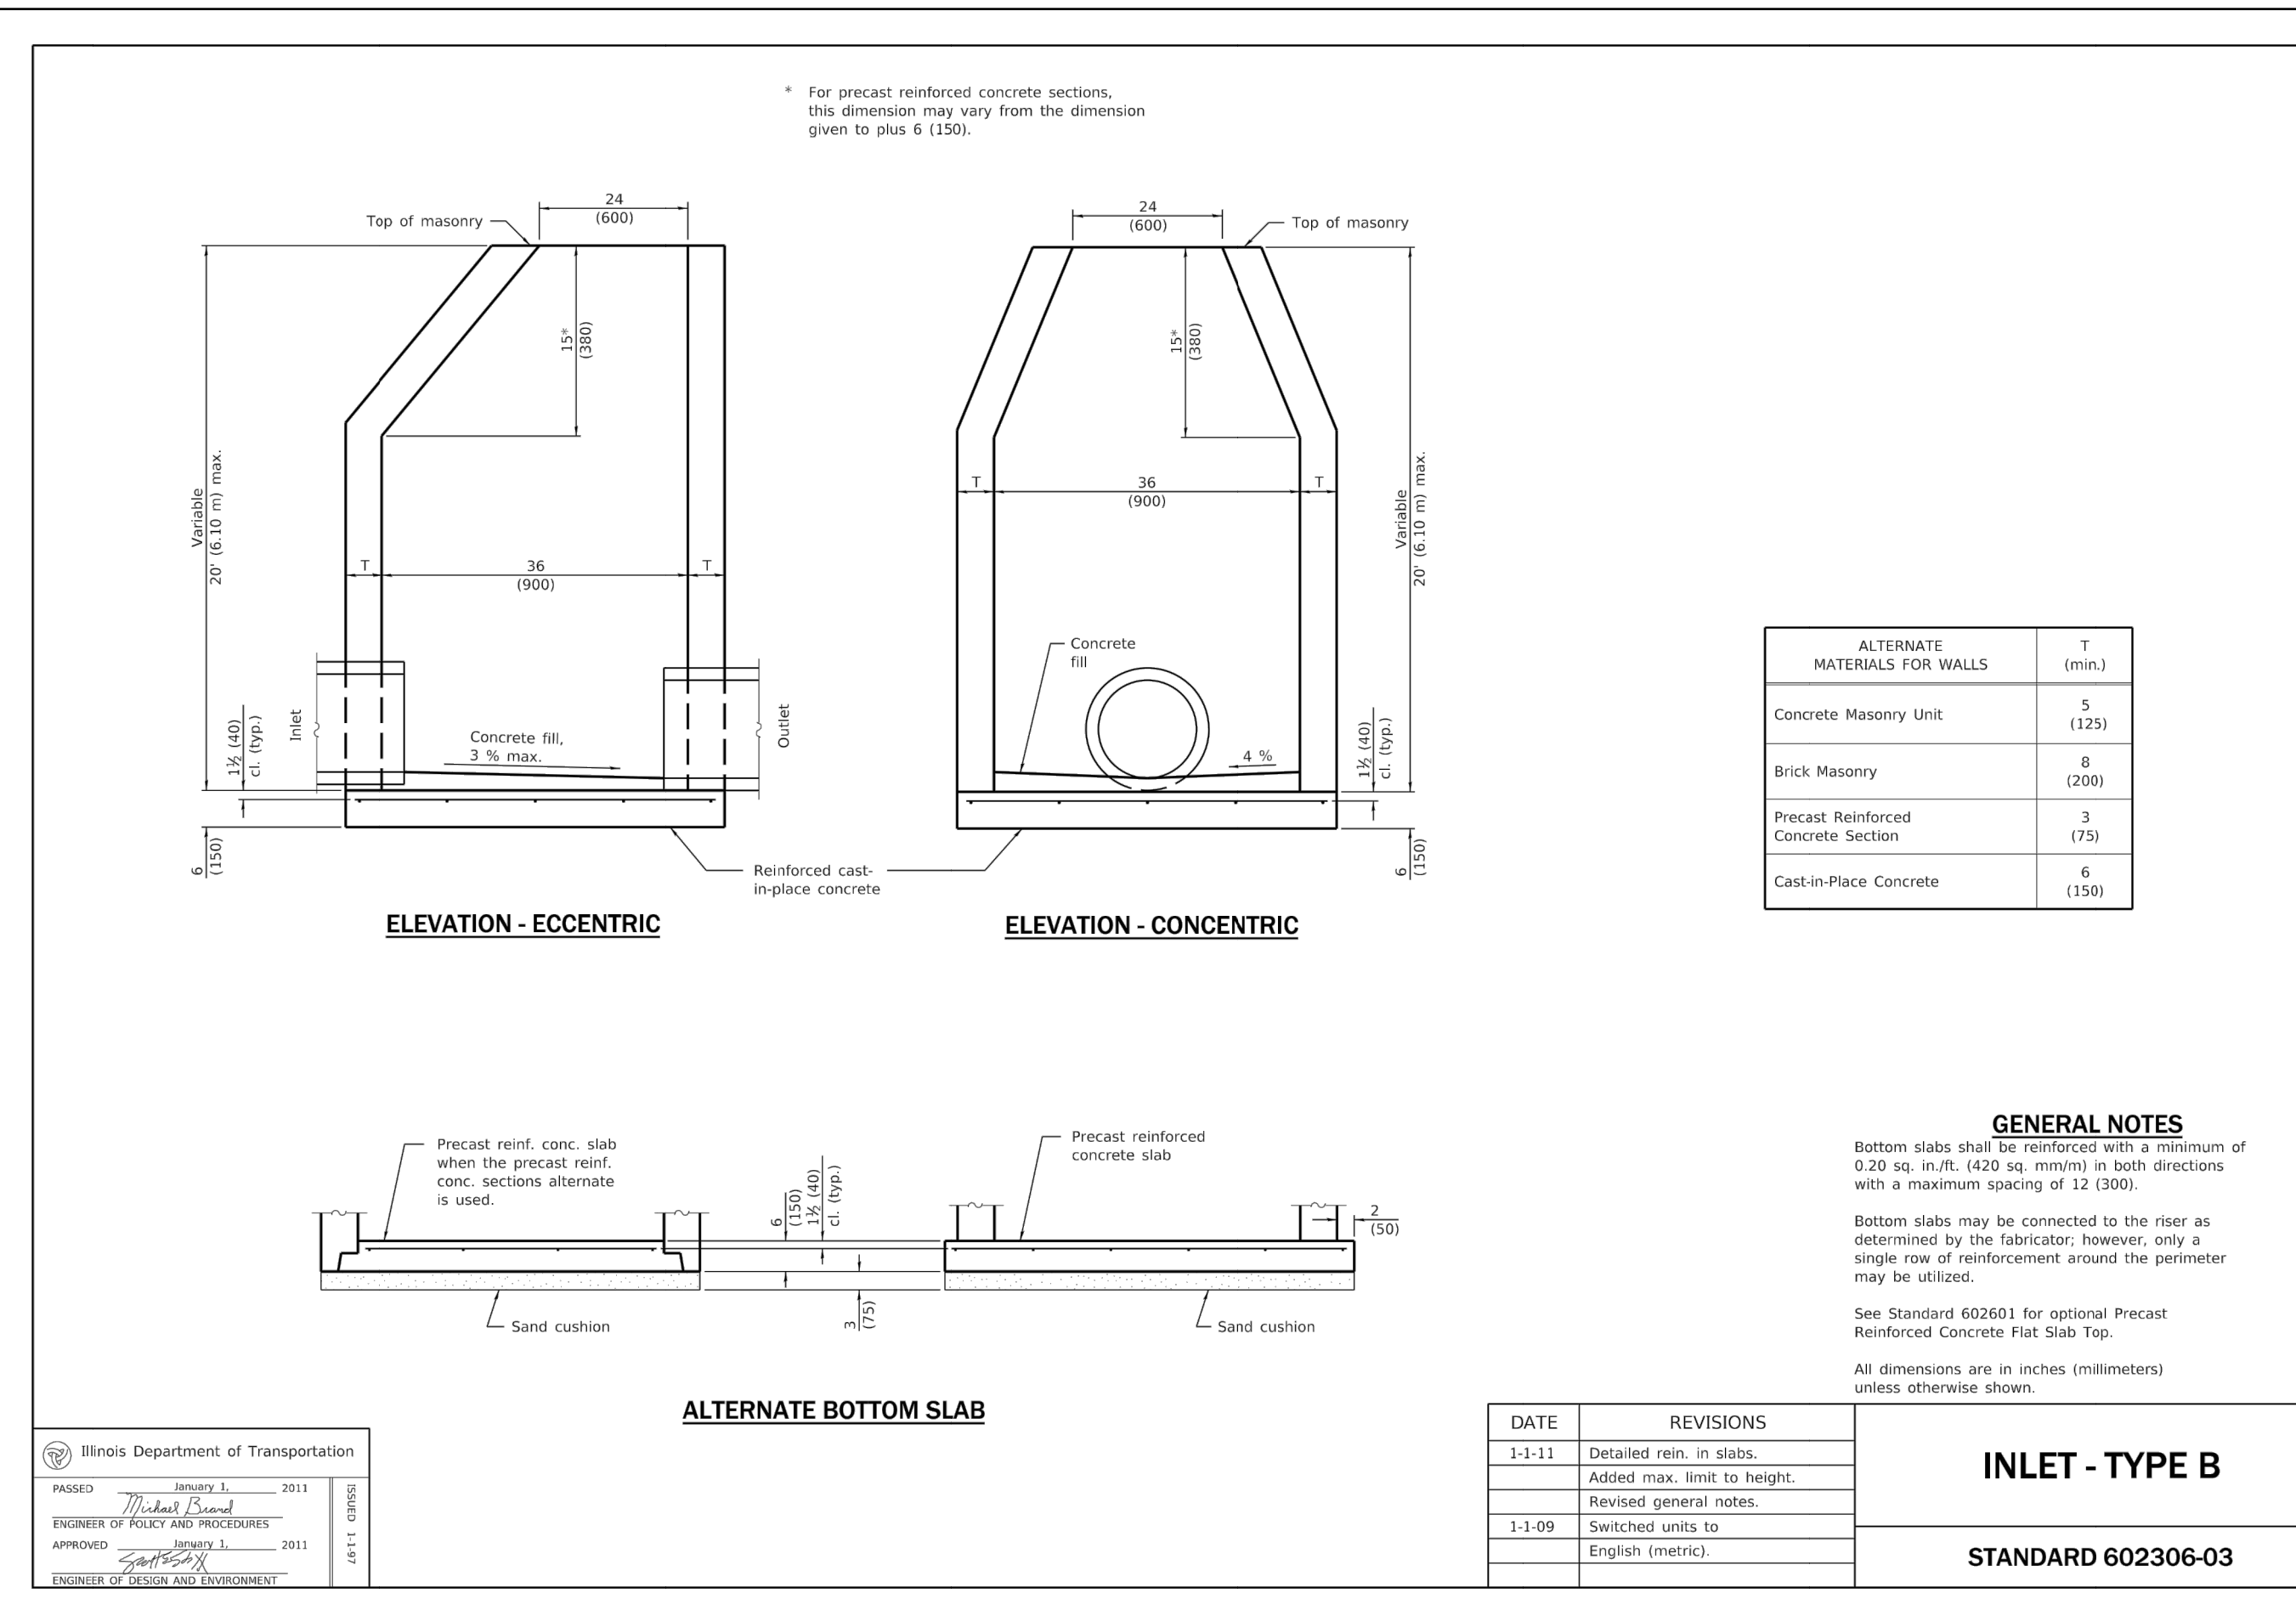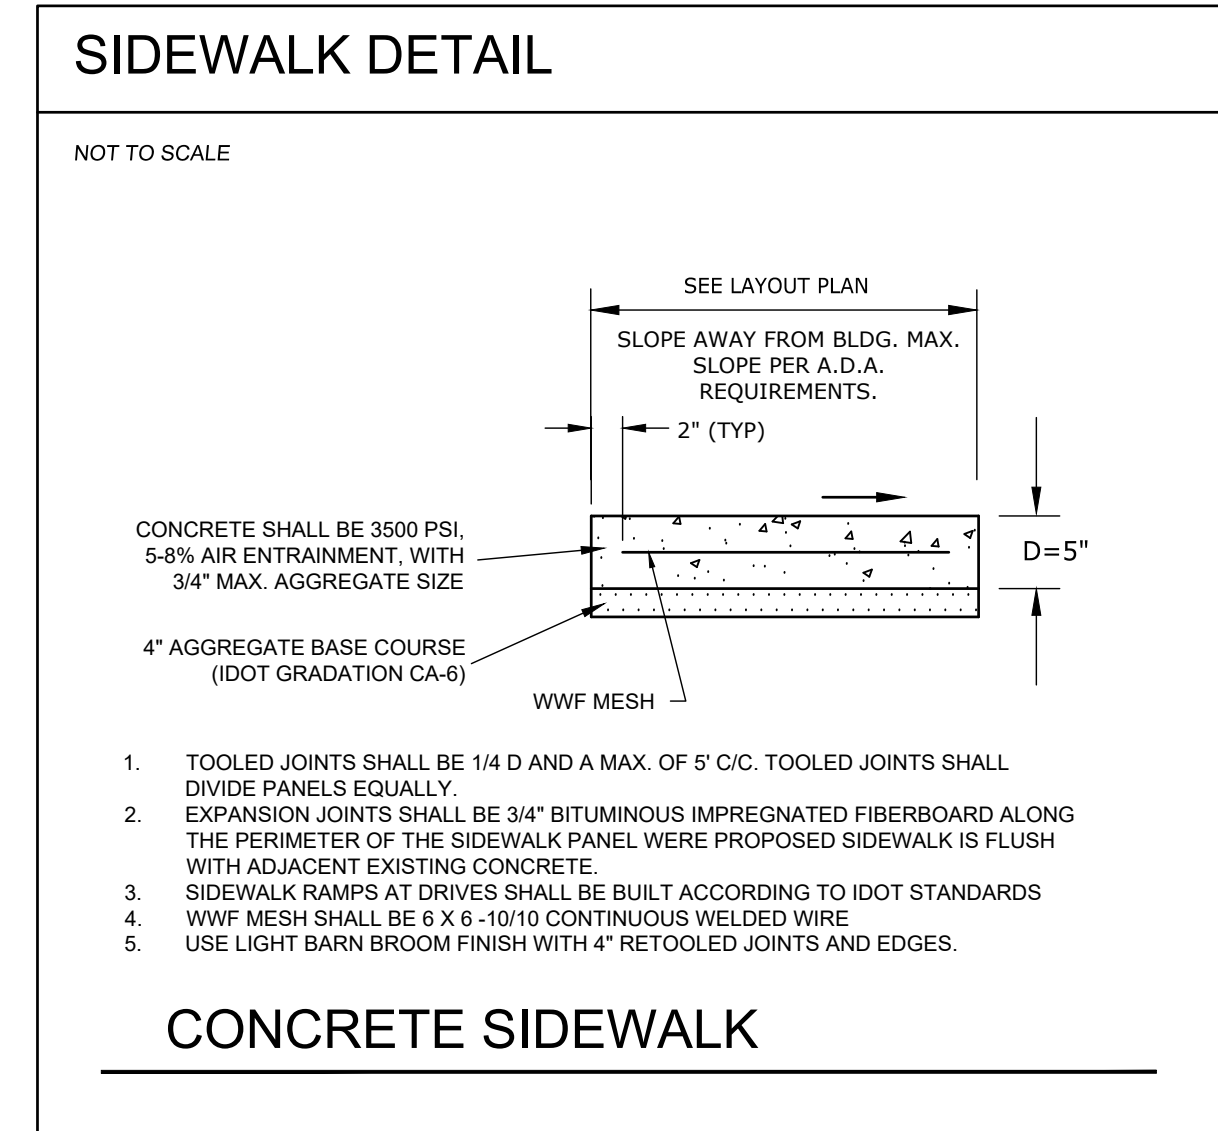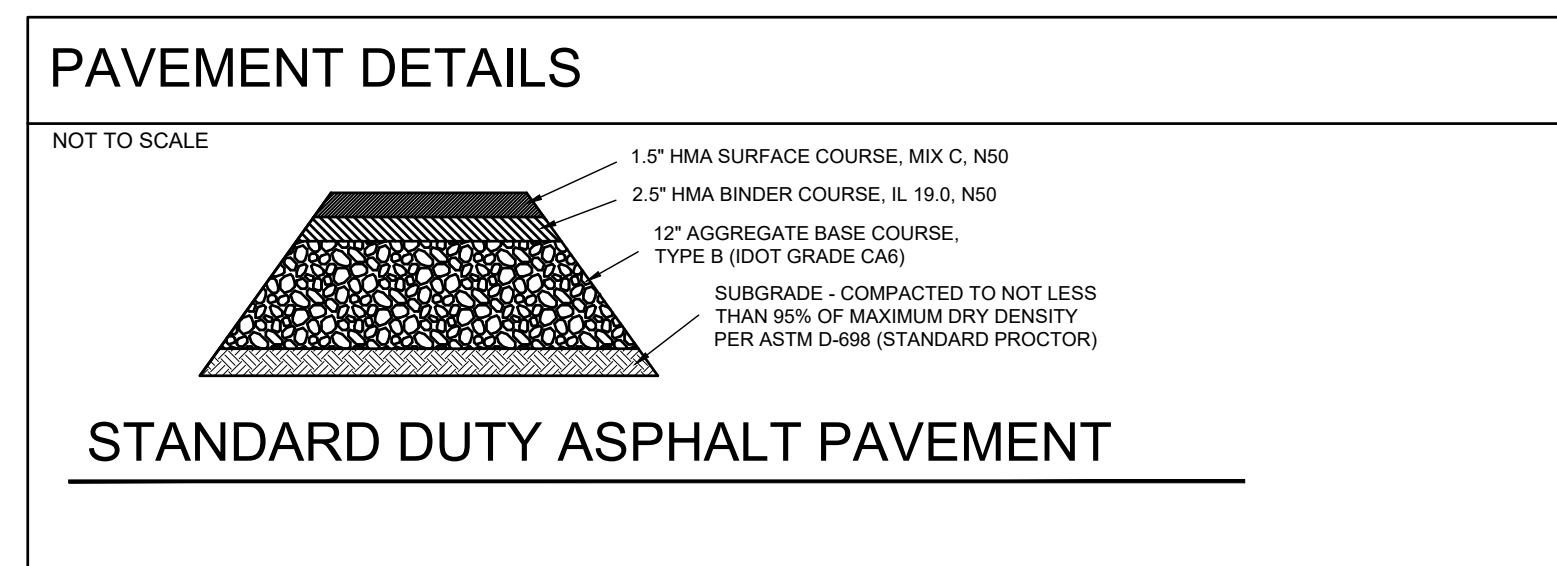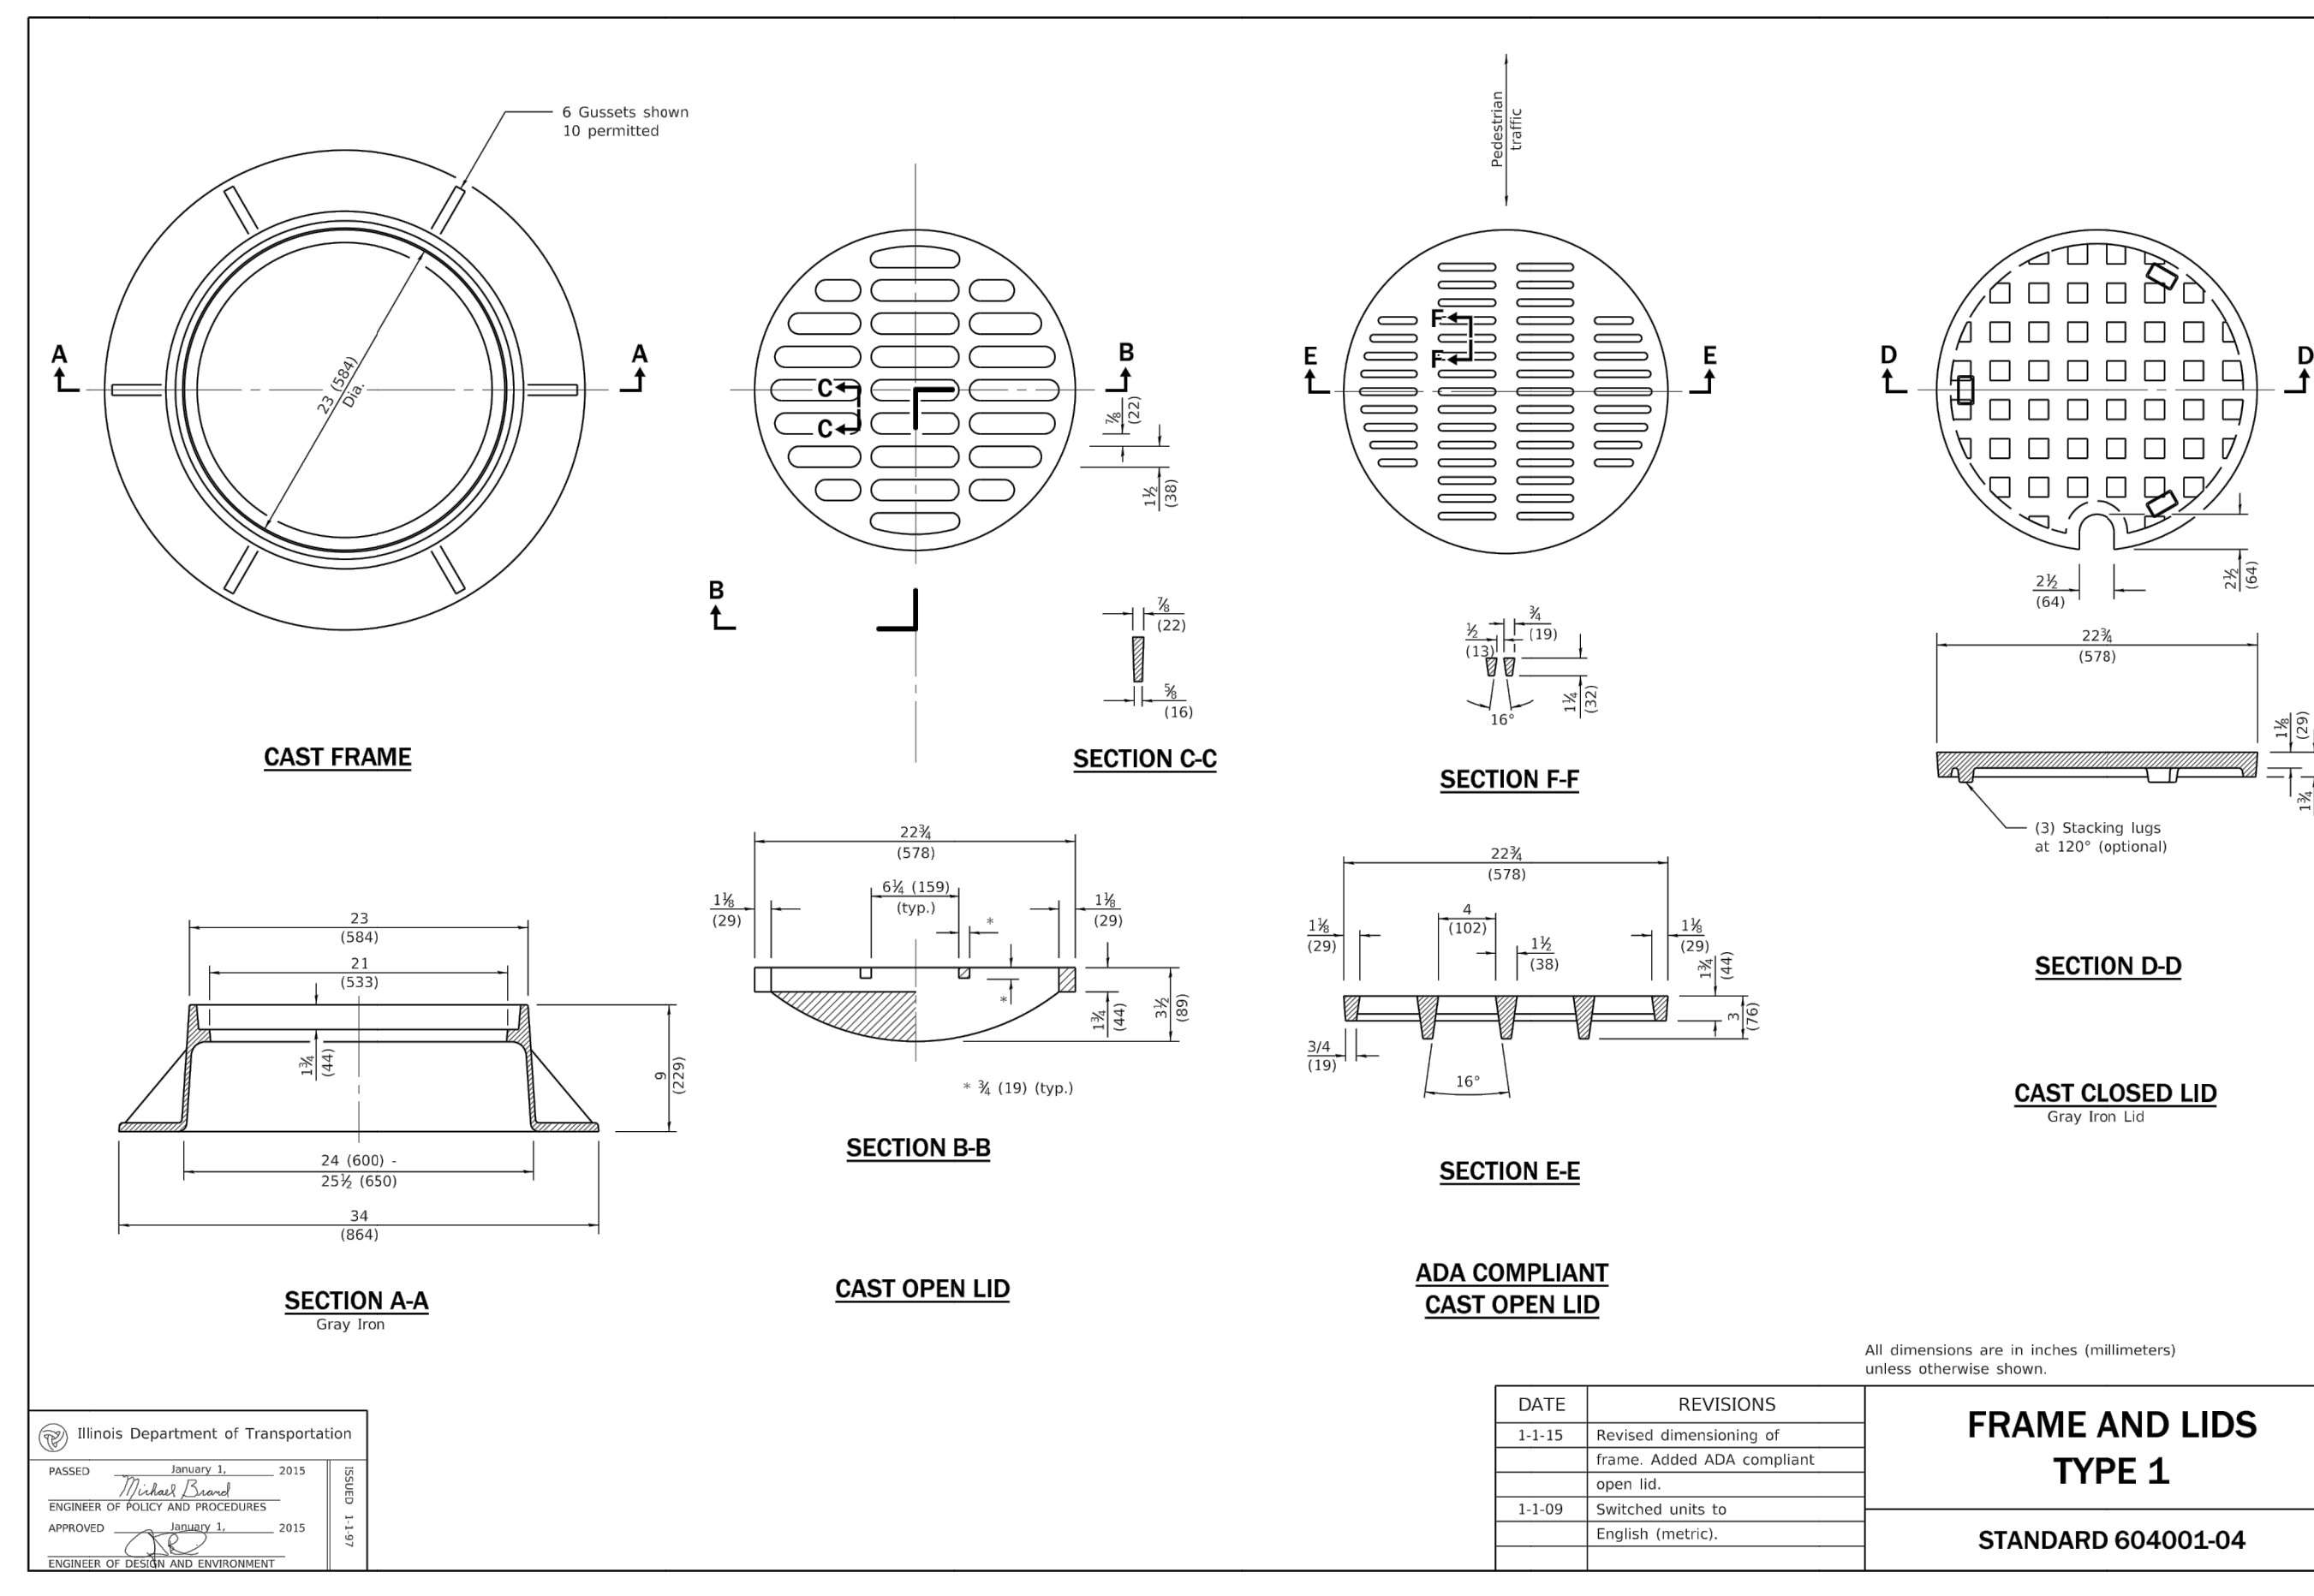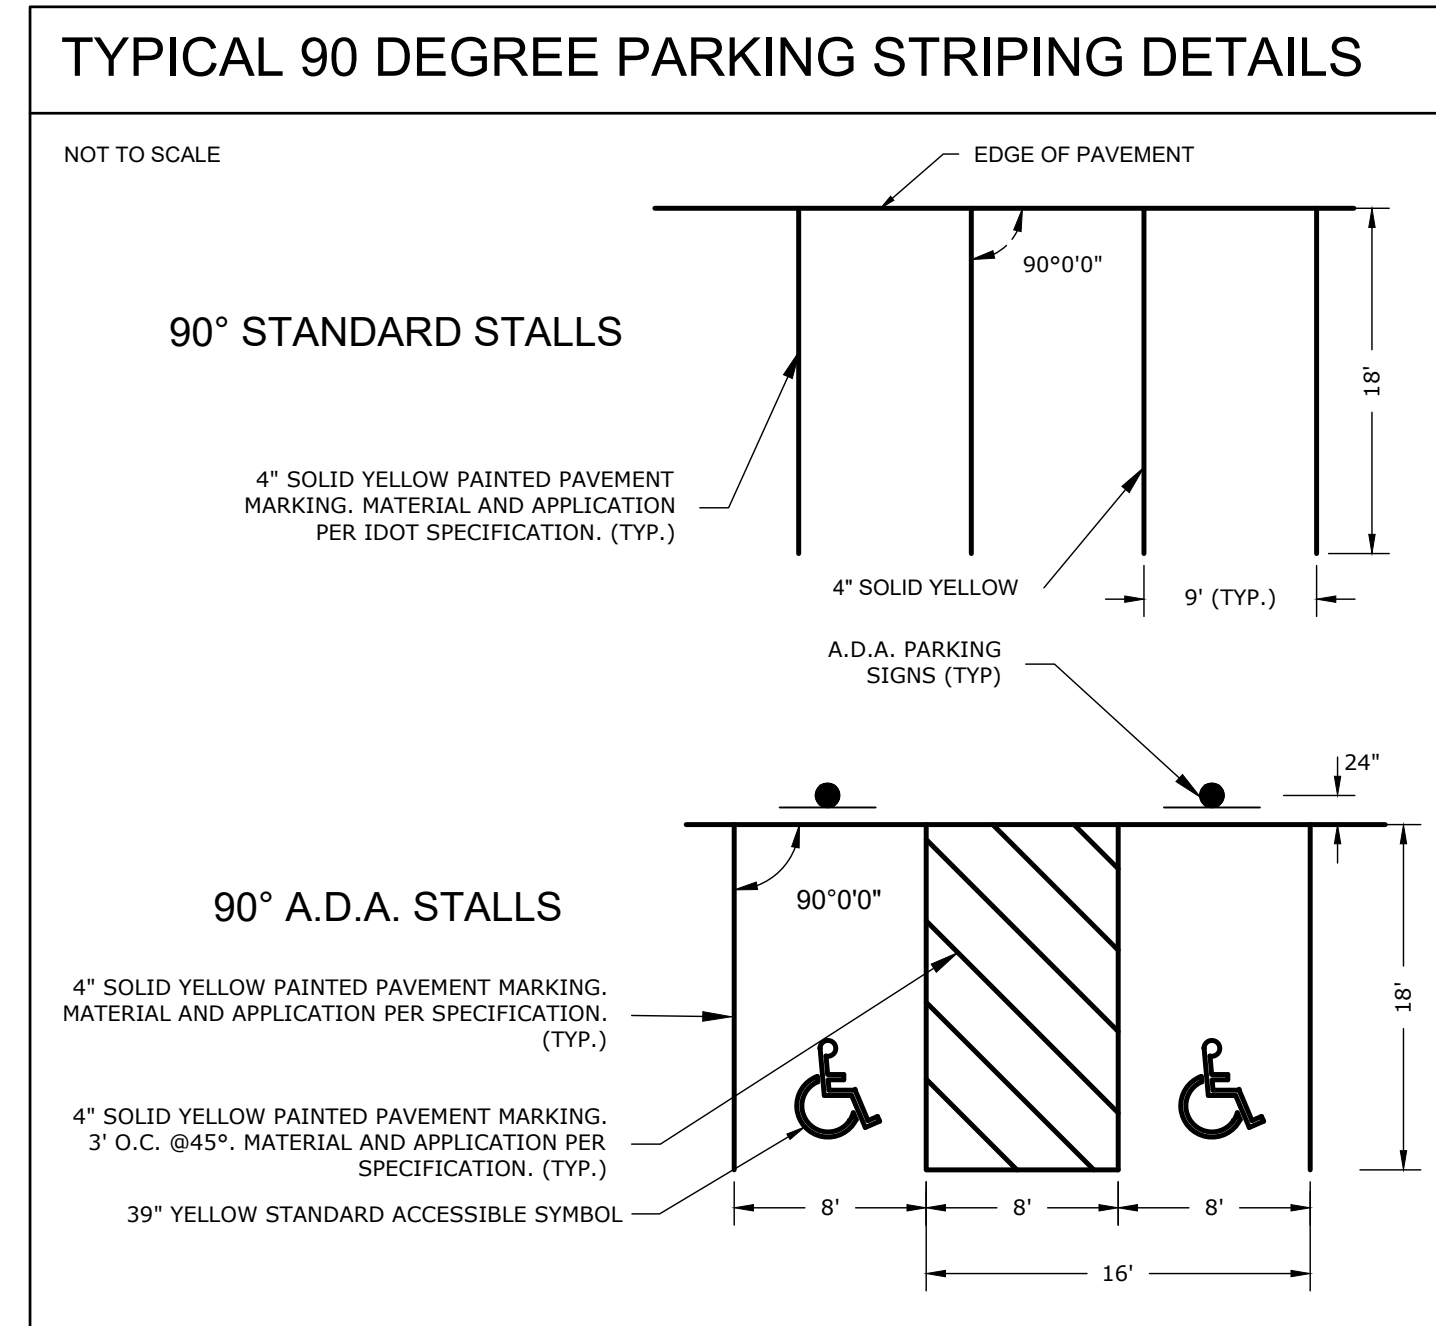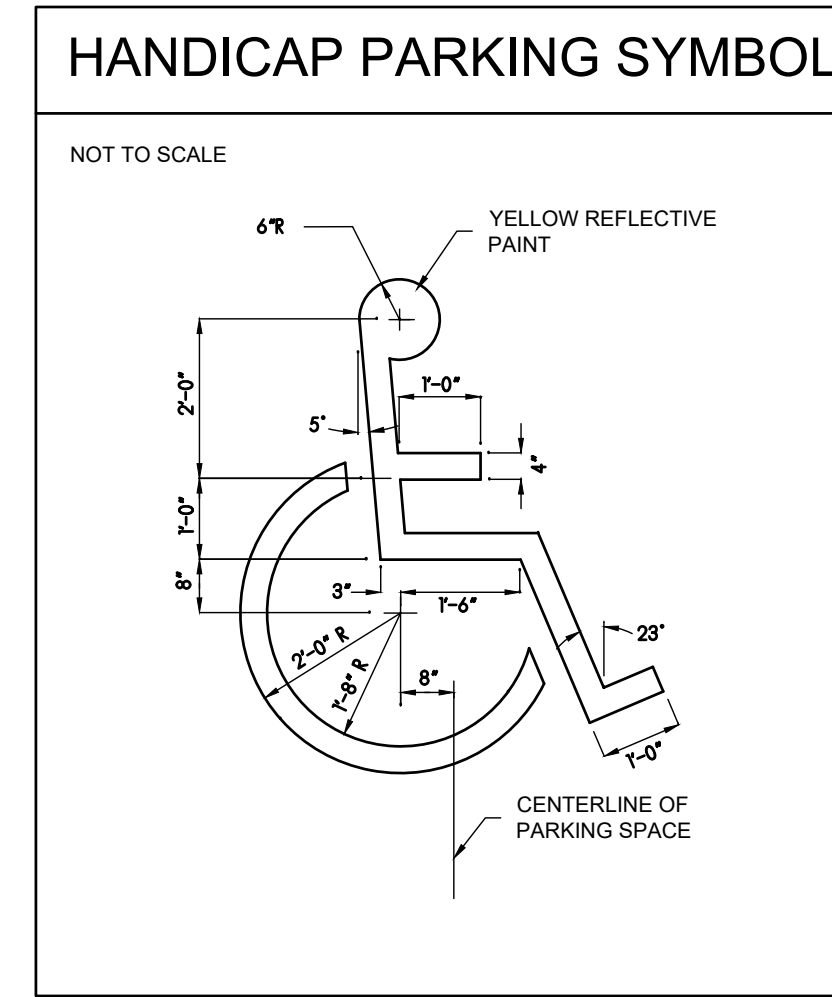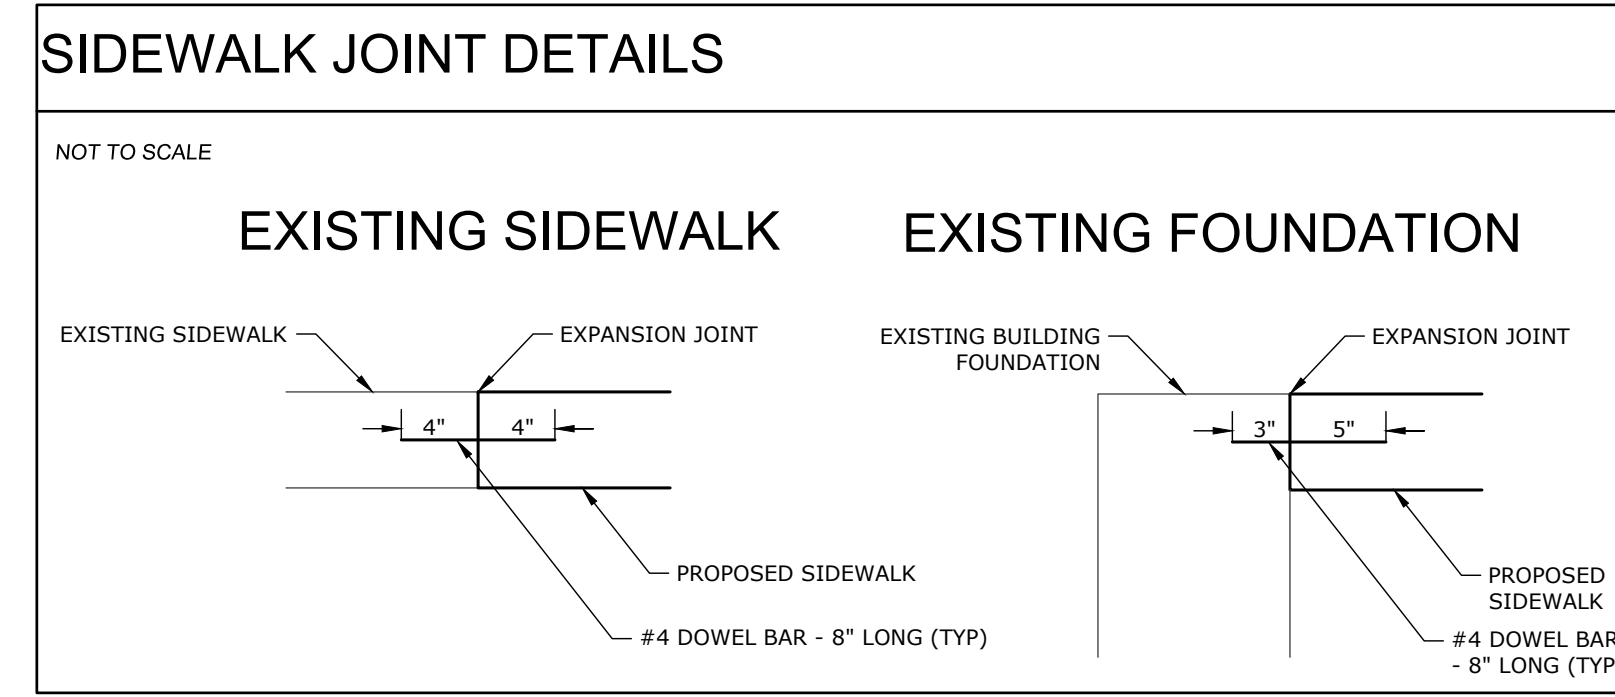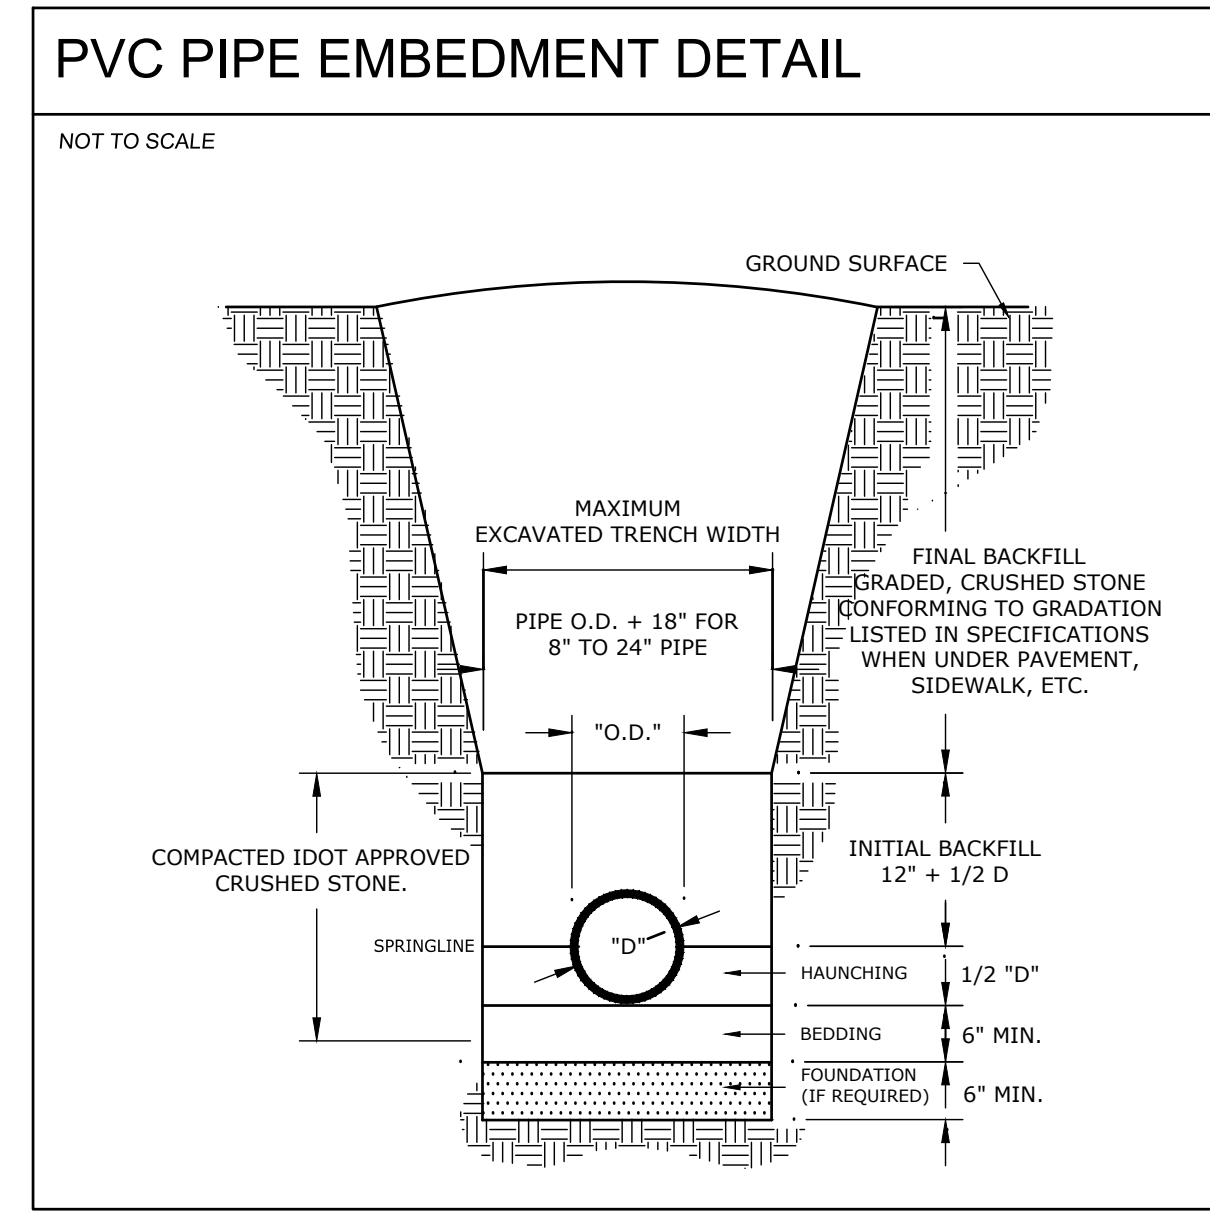

# CONSTRUCTION DETAILS

**ARC DESIGN**  
RESOURCES INC.

5291 ZENITH PARKWAY  
LOVES PARK, IL 61111  
VOICE: (815) 484-4300  
FAX: (815) 484-4303

www.arcdesign.com  
Illinois Design Firm License No. 184-001334

**Larson & Darby Group**  
Architecture Engineering Interiors

4949 Harrison Ave., Suite 100, Rockford, IL 61108 Tel: (815) 484-0739 Fax: (815) 229-9867

PROGRESS PRINT  
Not For Construction  
Date: 06-08-2021  
LARSON & DARBY GROUP  
architecture-engineering-interiors


ACCESSIBILITY RAMP STUDY  
VETERANS MEMORIAL HALL  
ROCKFORD, ILLINOIS

ISSUED FOR: DATE  
PROJECT NUMBER: 30271  
SHEET NUMBER: C04  
DRAWN: APPROVED


DATE: 6-18-2021  
PROJECT NUMBER: 30271  
SHEET NUMBER: C04

Copyright 2021  
All drawn and written information appearing herein shall not be duplicated, disclosed, or otherwise used without the written consent of Larson & Darby Group.




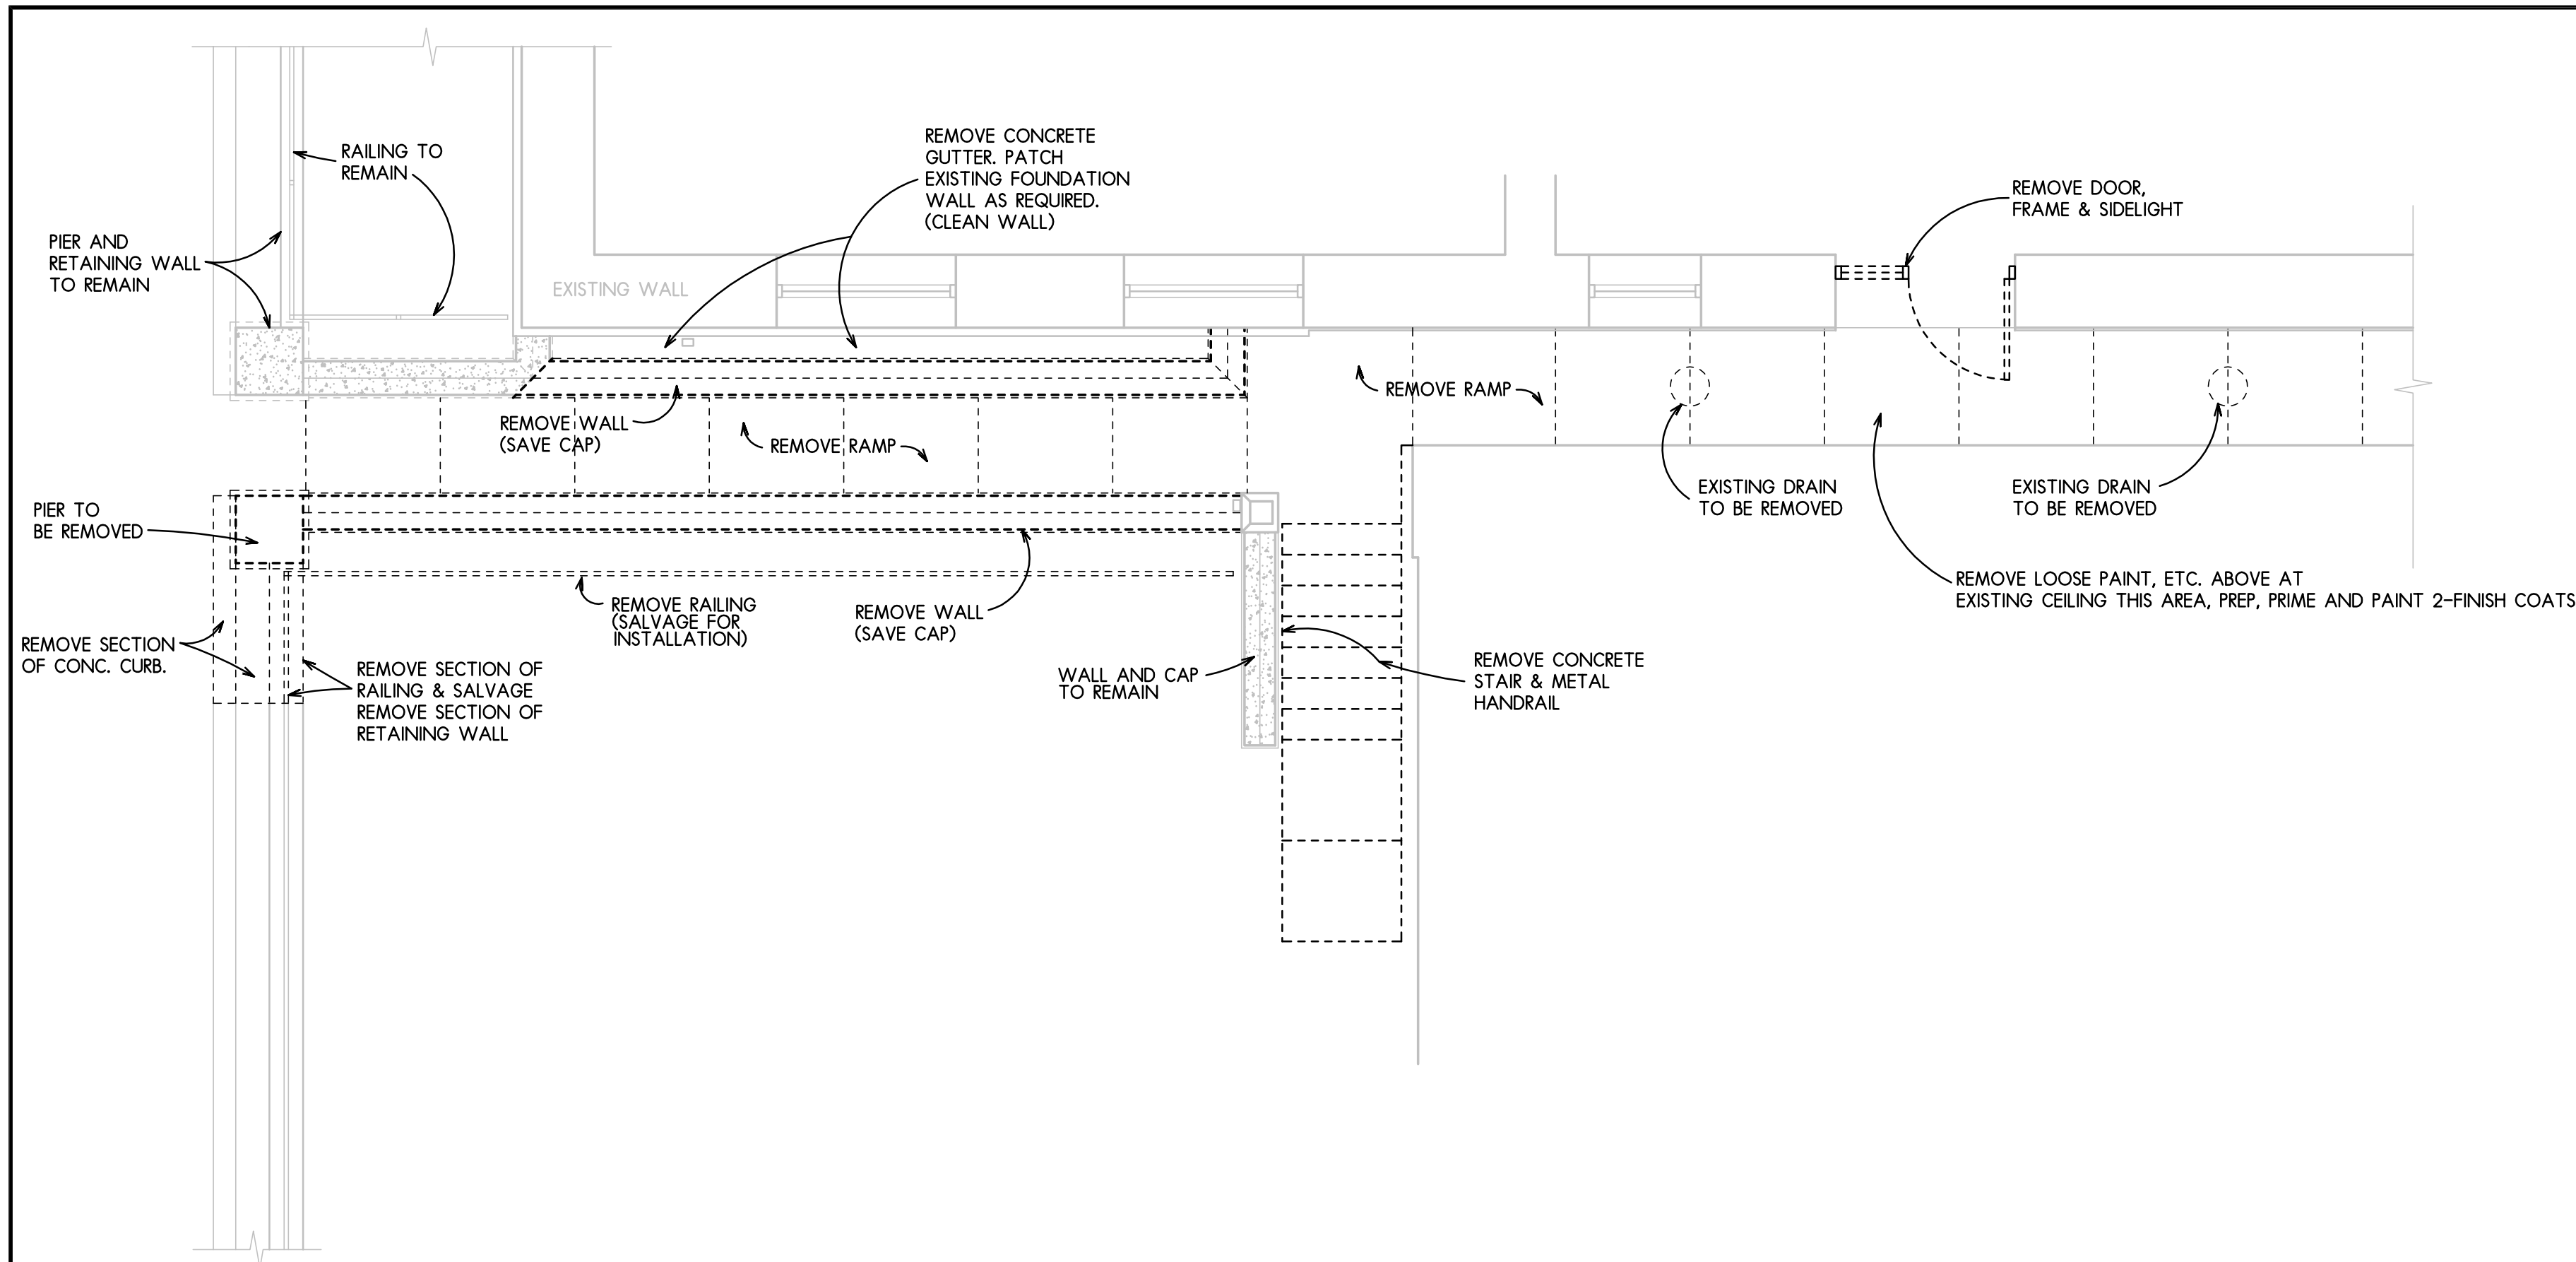


**1** DEMOLITION  
EXISTING LOWER LEVEL ENTRANCE & STAIR PLAN  
SCALE: 1/4" = 1'-0"

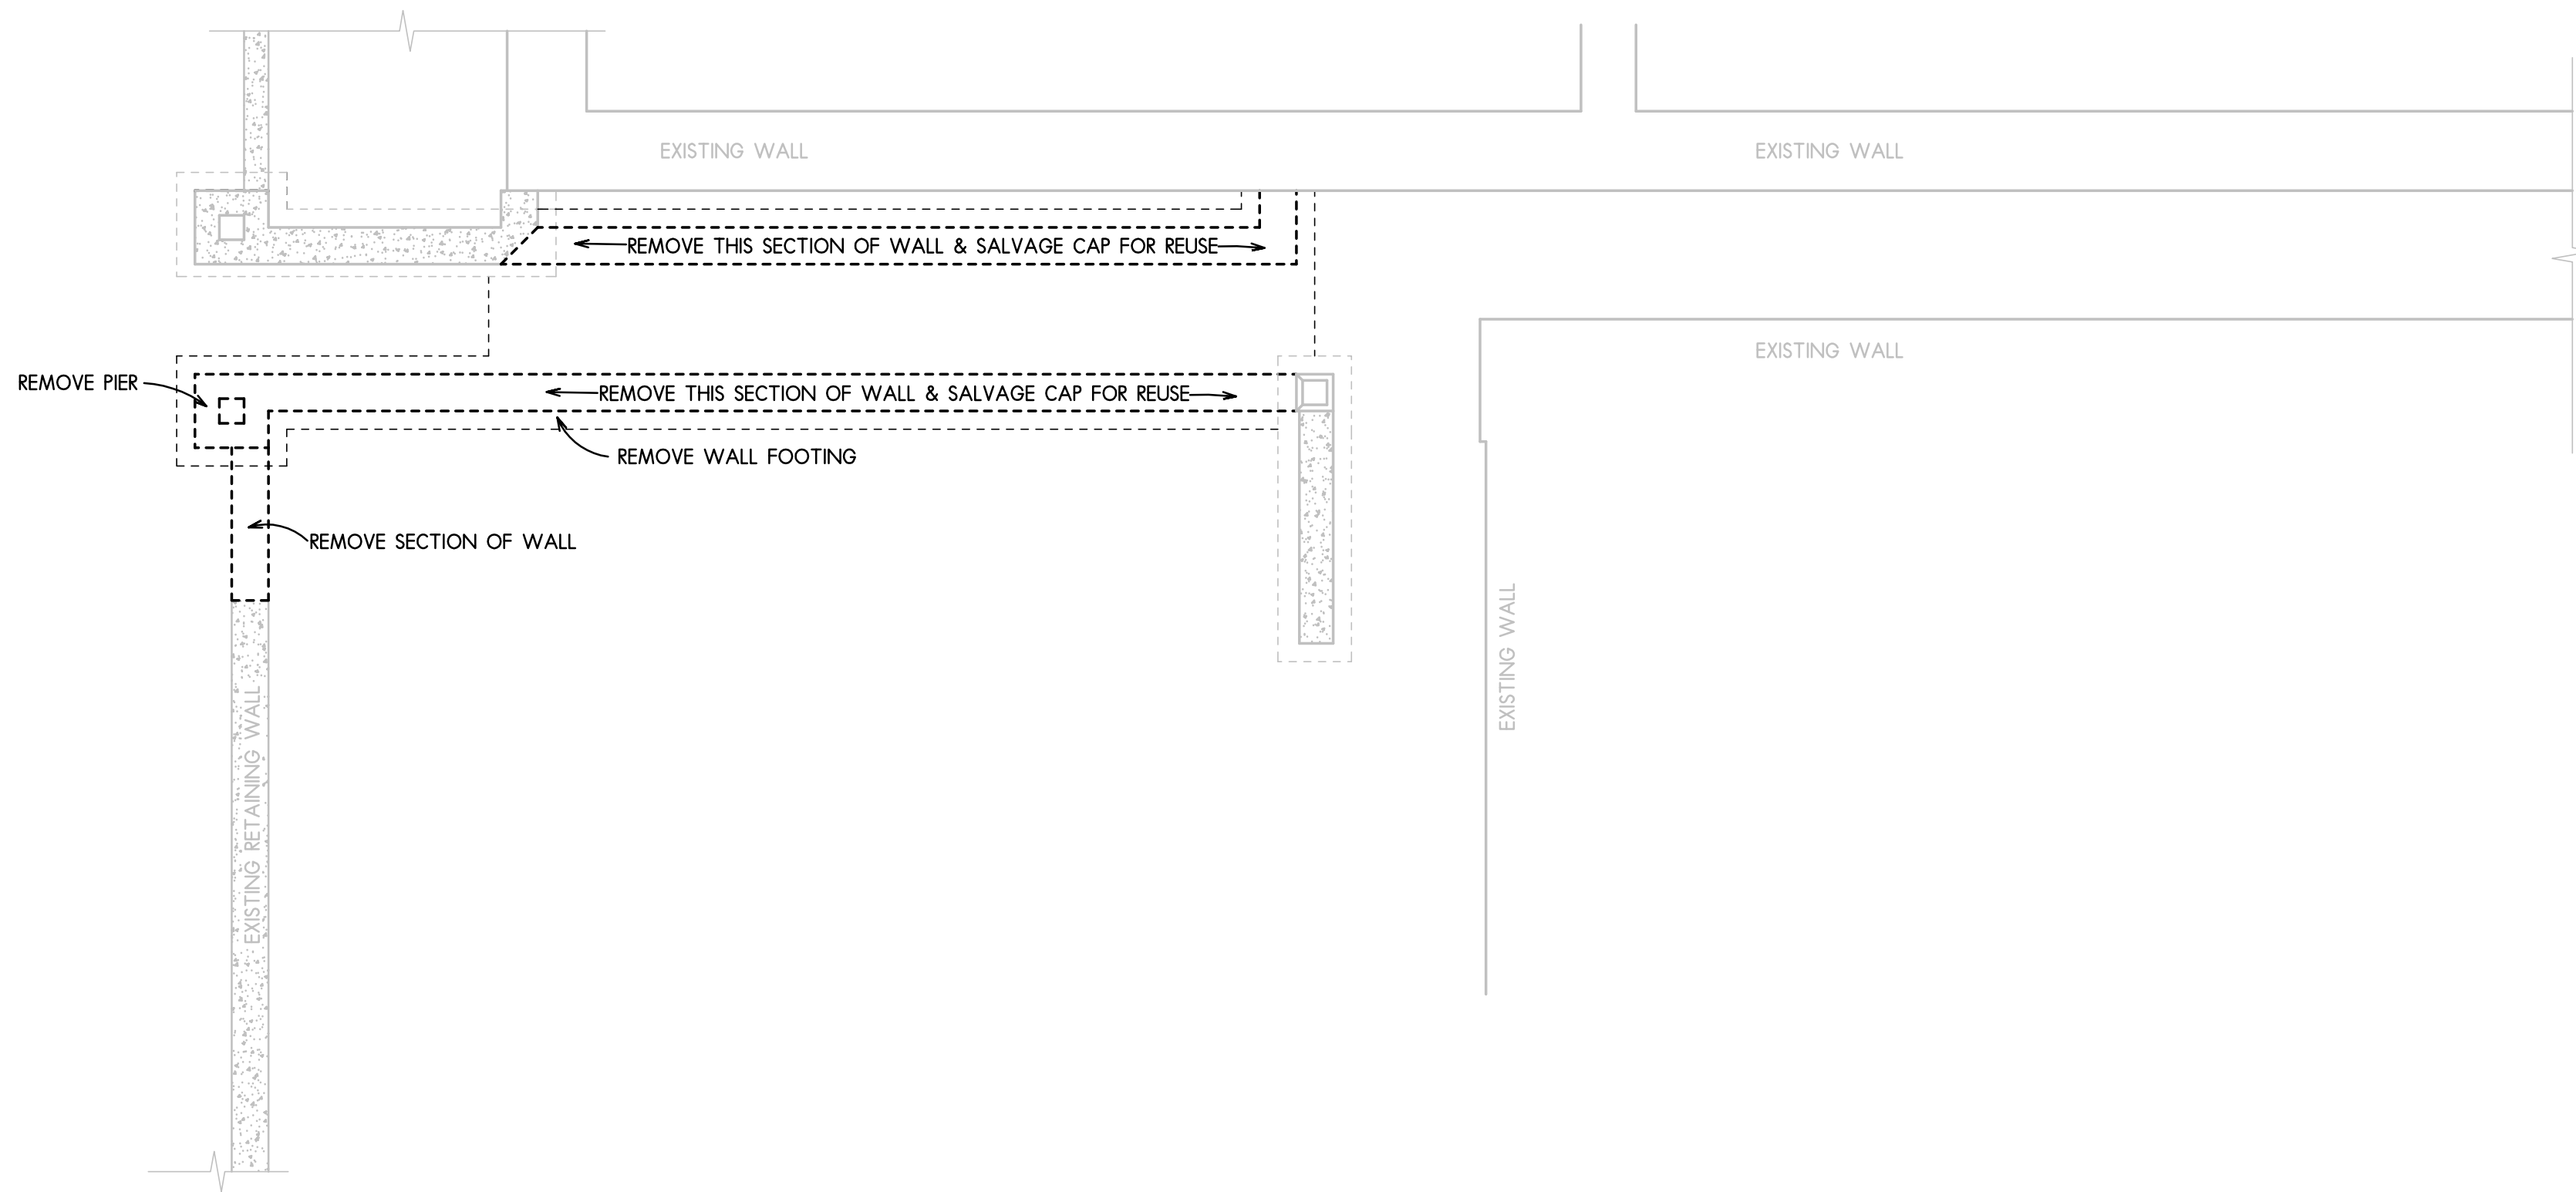


**3** DEMOLITION  
FOUNDATION/ FOOTING PLAN  
SCALE: 1/4" = 1'-0"

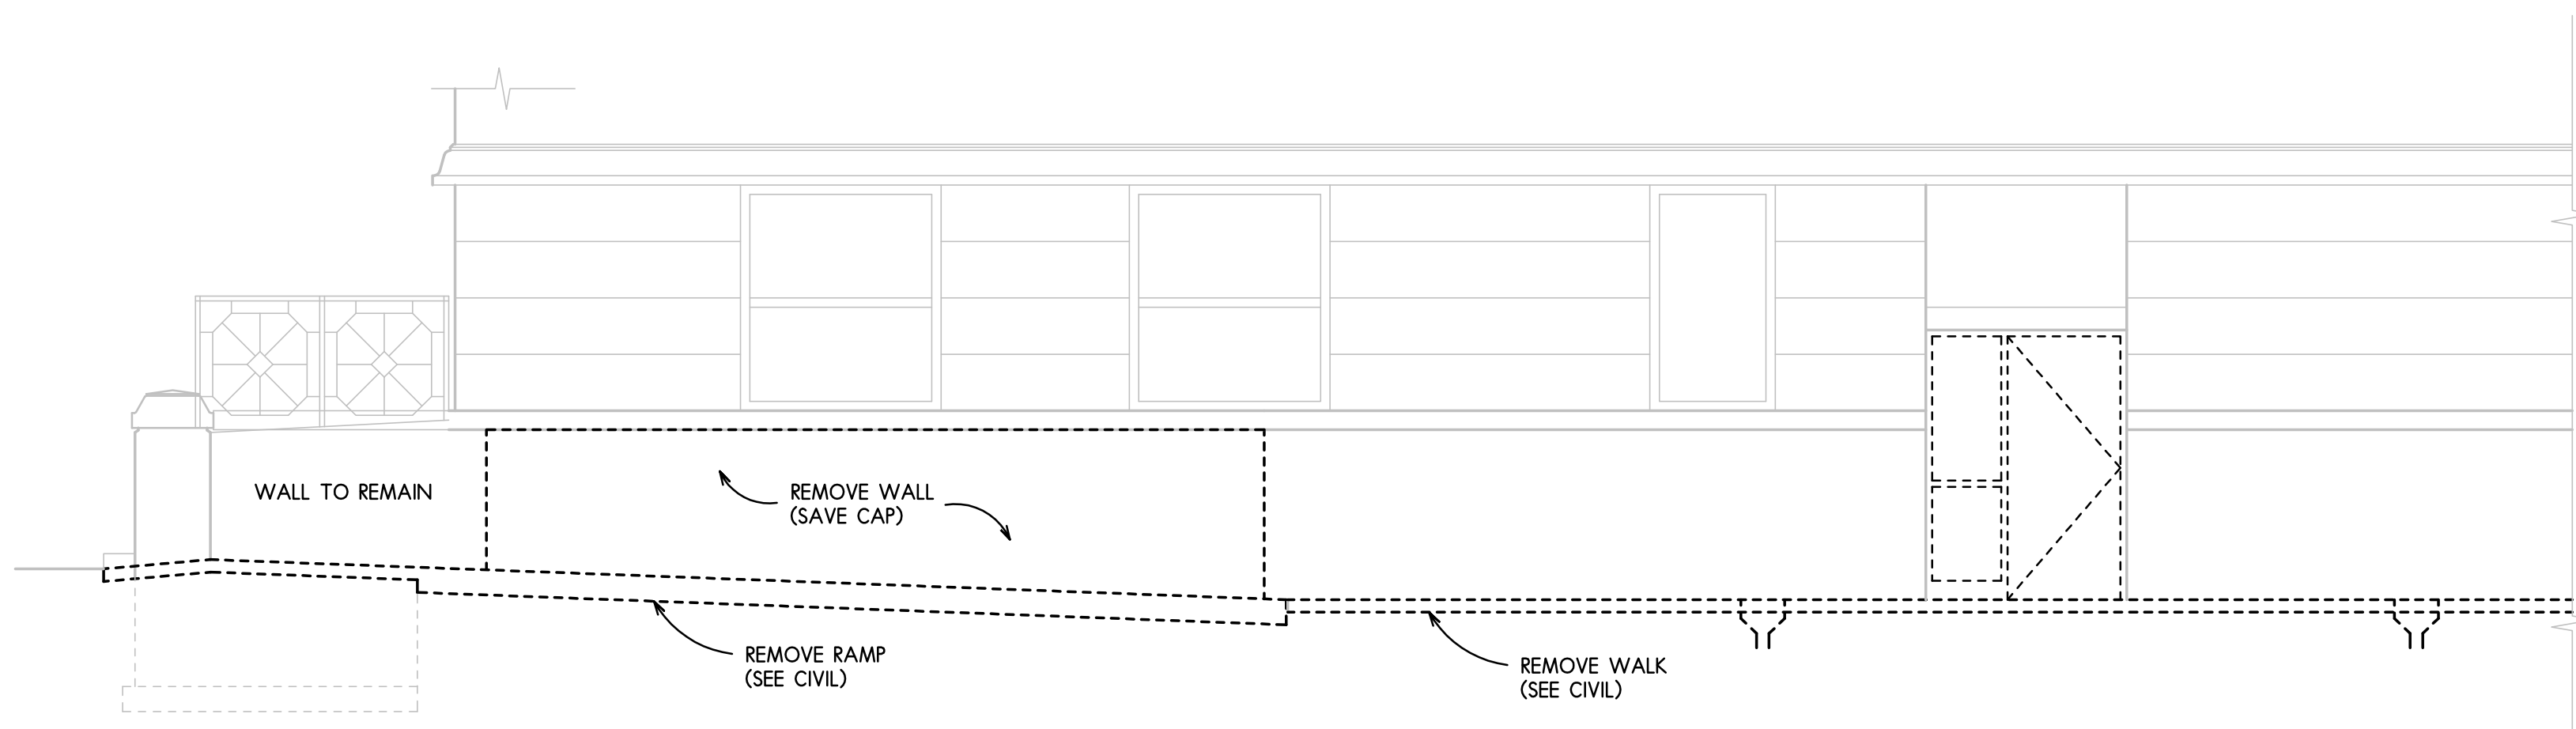


**5** DEMOLITION  
LONGITUDINAL WALK SECTION  
SCALE: 1/4" = 1'-0"

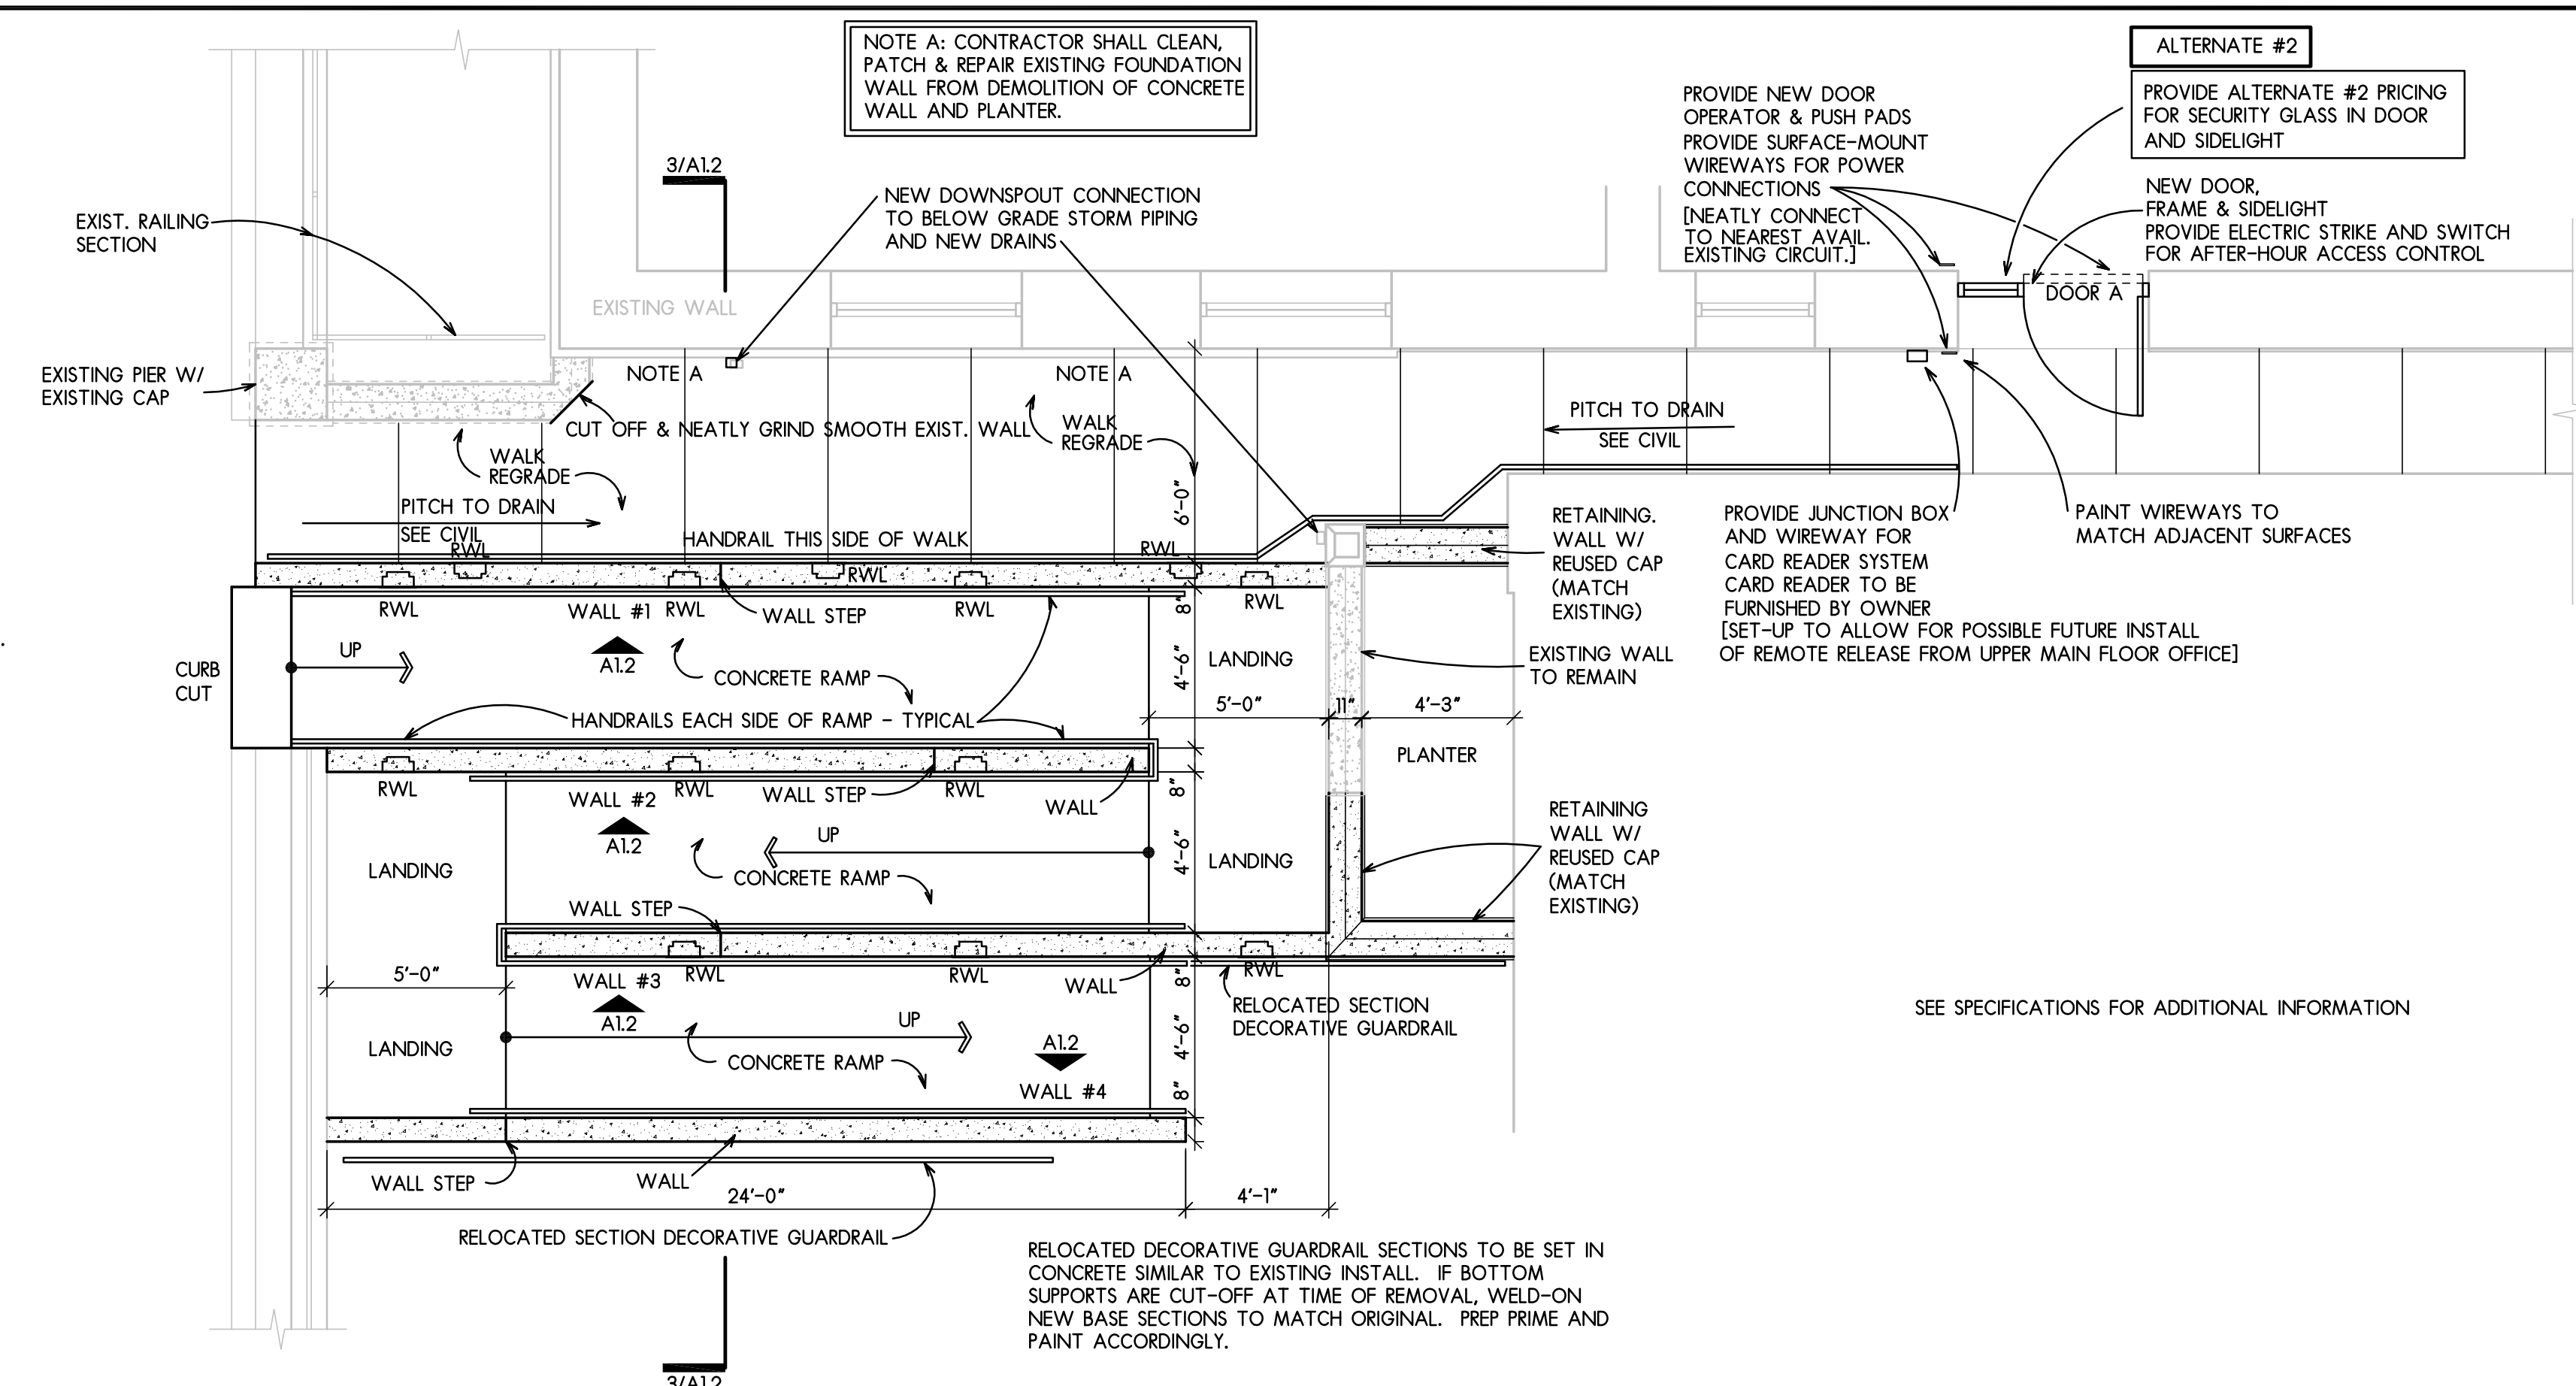


**2** PROPOSED  
ACCESSIBLE WALK & RAMP PLAN  
SCALE: 1/4" = 1'-0"

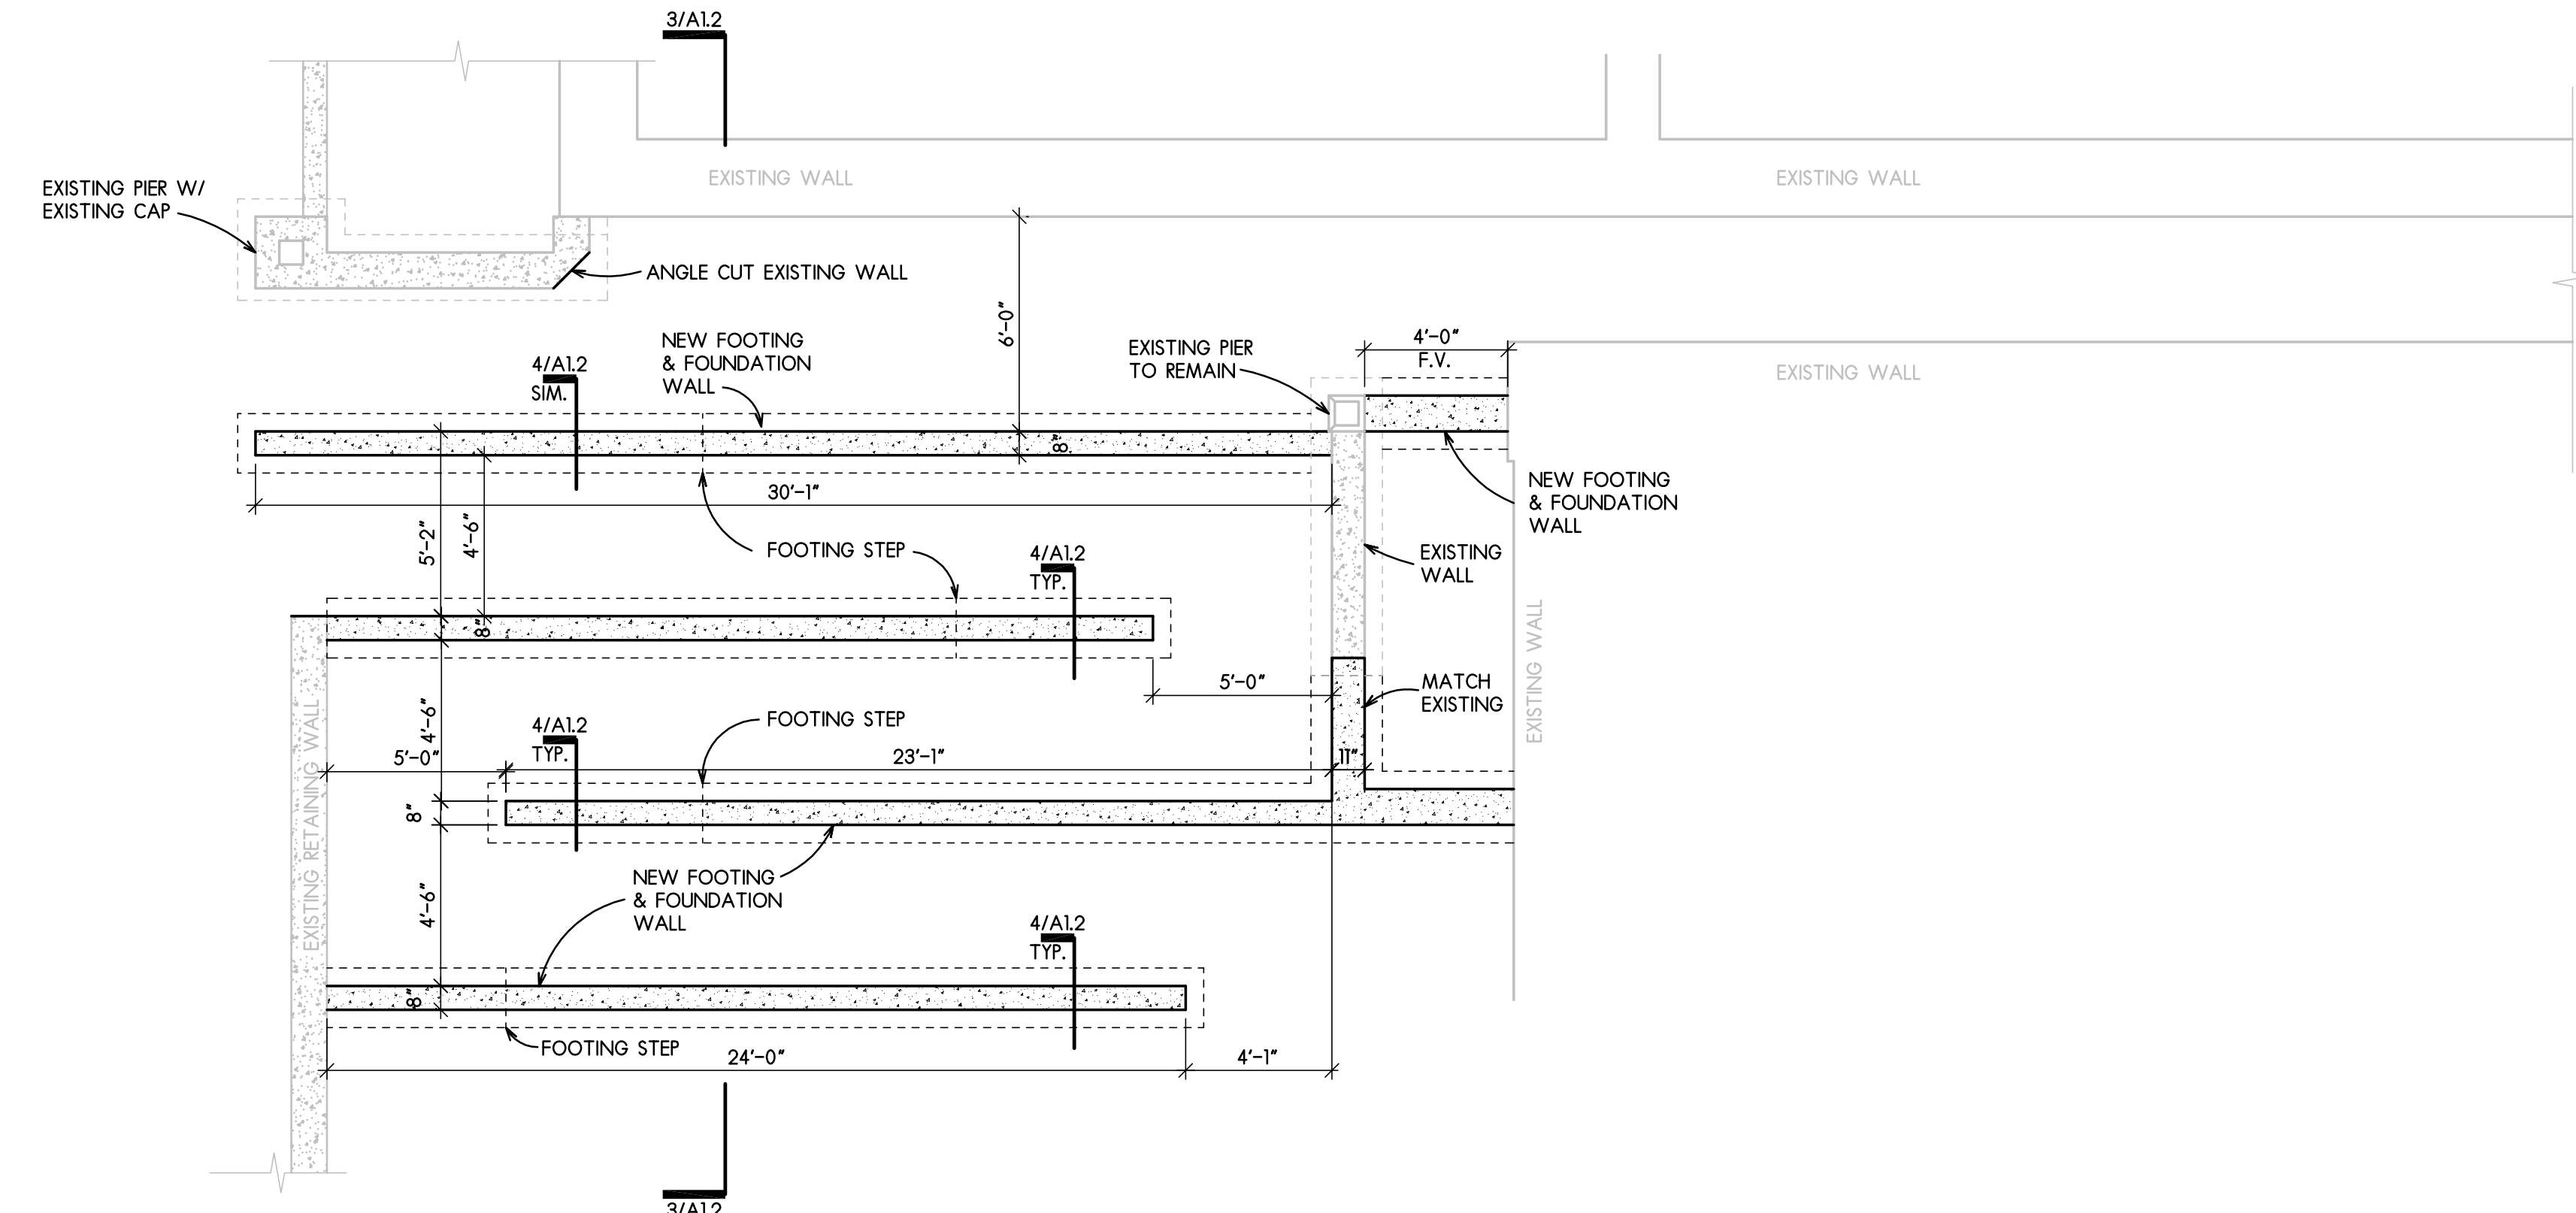

**4** PROPOSED  
FOUNDATION/ FOOTING PLAN  
SCALE: 1/4" = 1'-0"

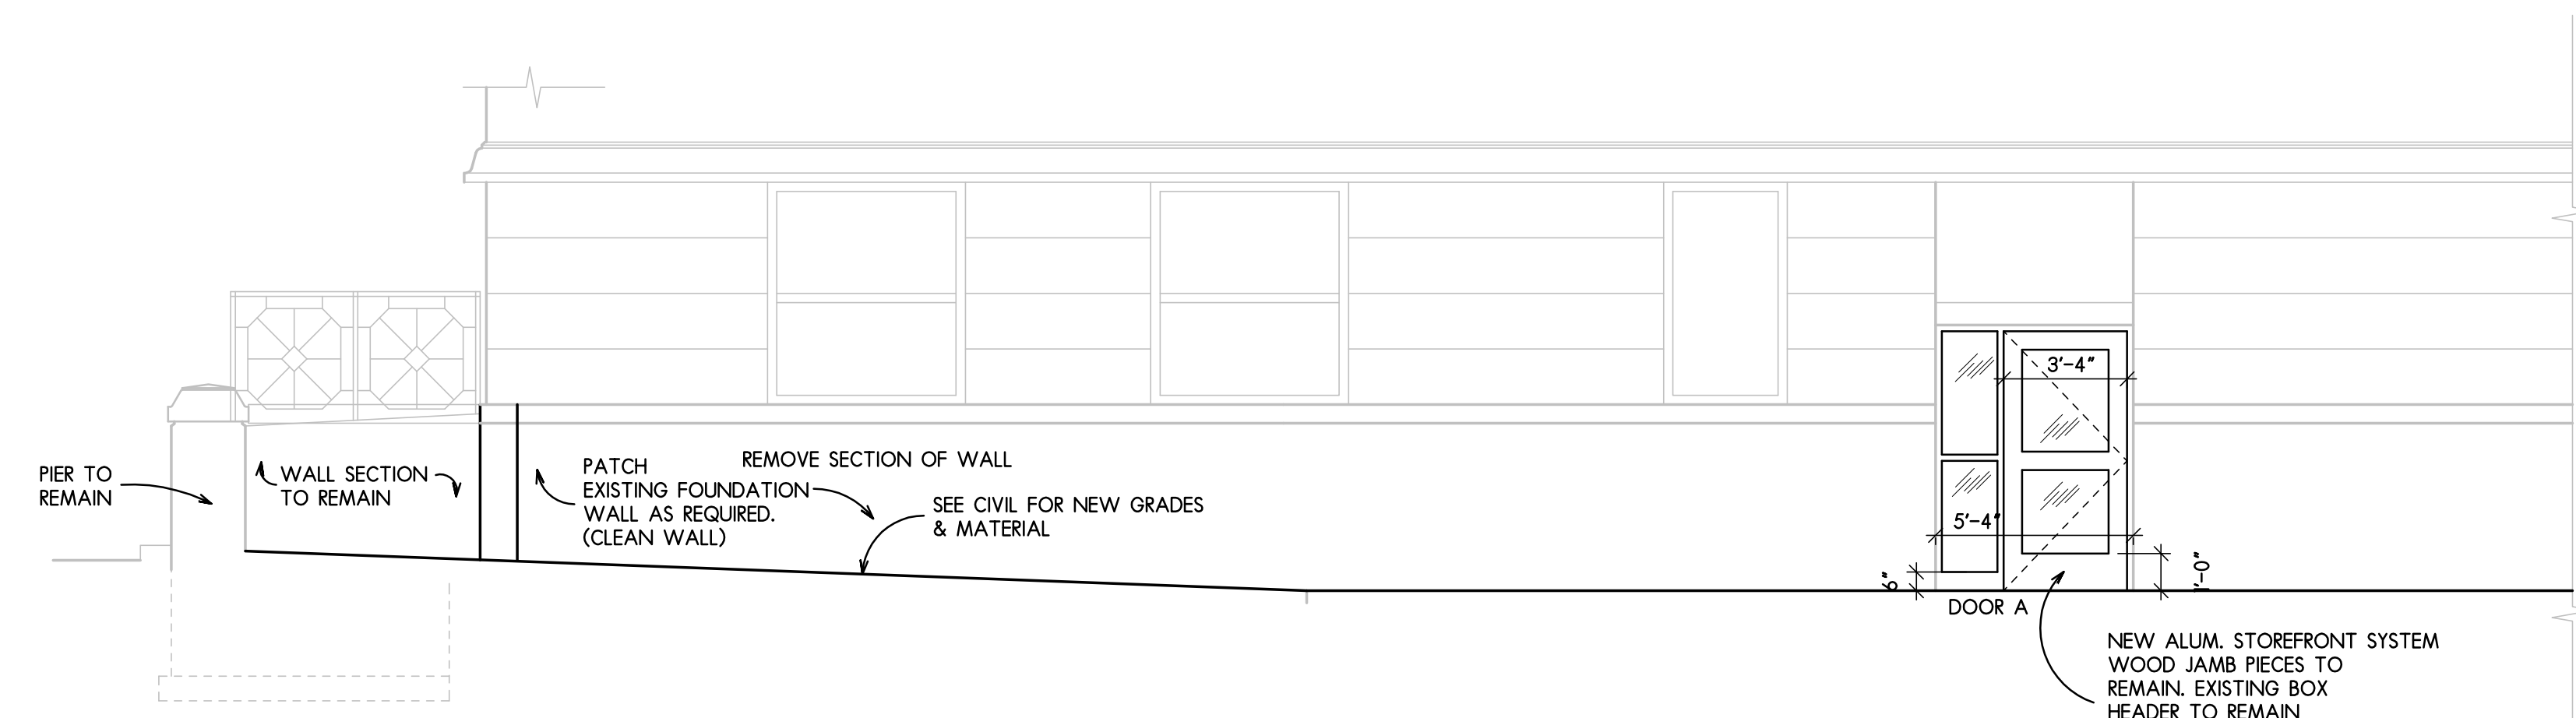


**6** PROPOSED  
LONGITUDINAL WALK SECTION  
SCALE: 1/4" = 1'-0"

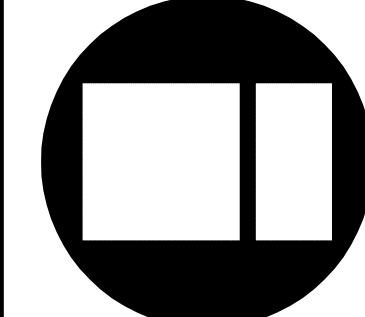


ISSUED FOR:	DATE:
DRAWN:	APPROVED:


DATE: 6-18-2021	PROJECT NUMBER: 30271	SHEET NUMBER: A1.1
-----------------	-----------------------	--------------------

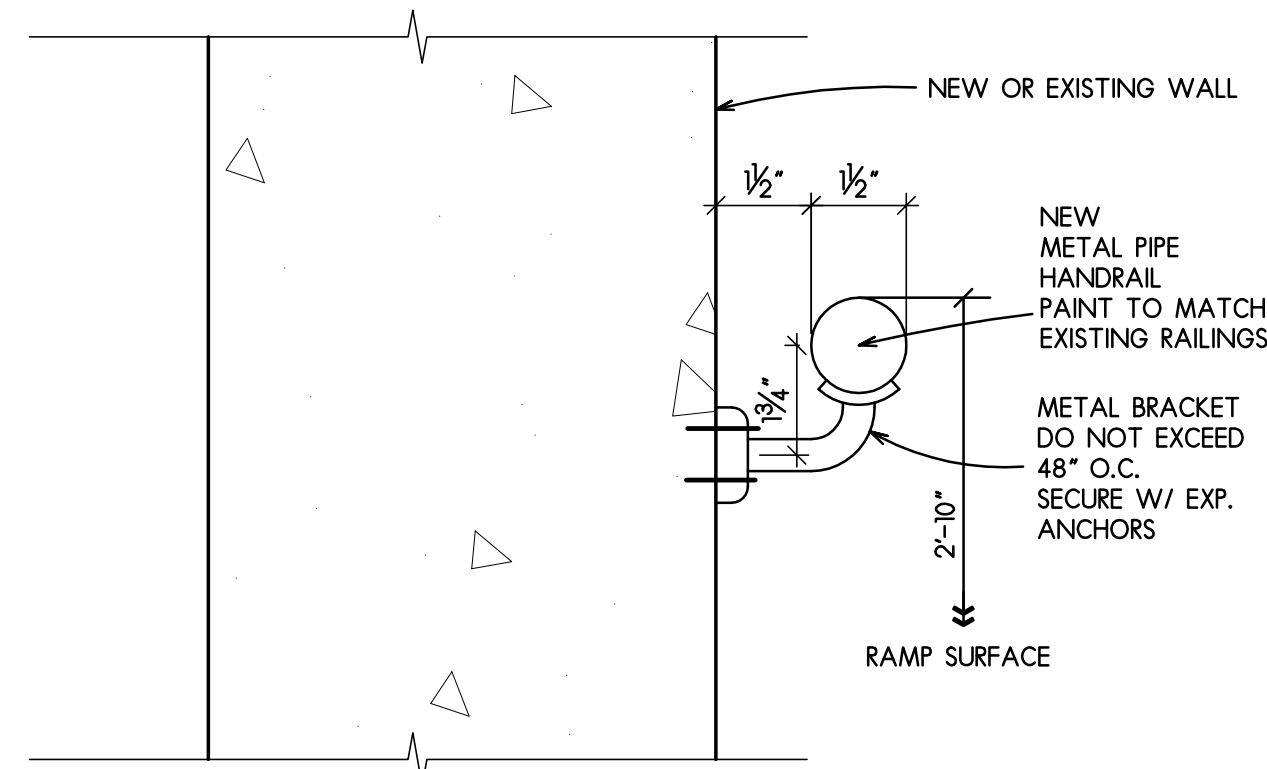


**1 HANDRAIL DETAIL**  
SCALE: NO SCALE

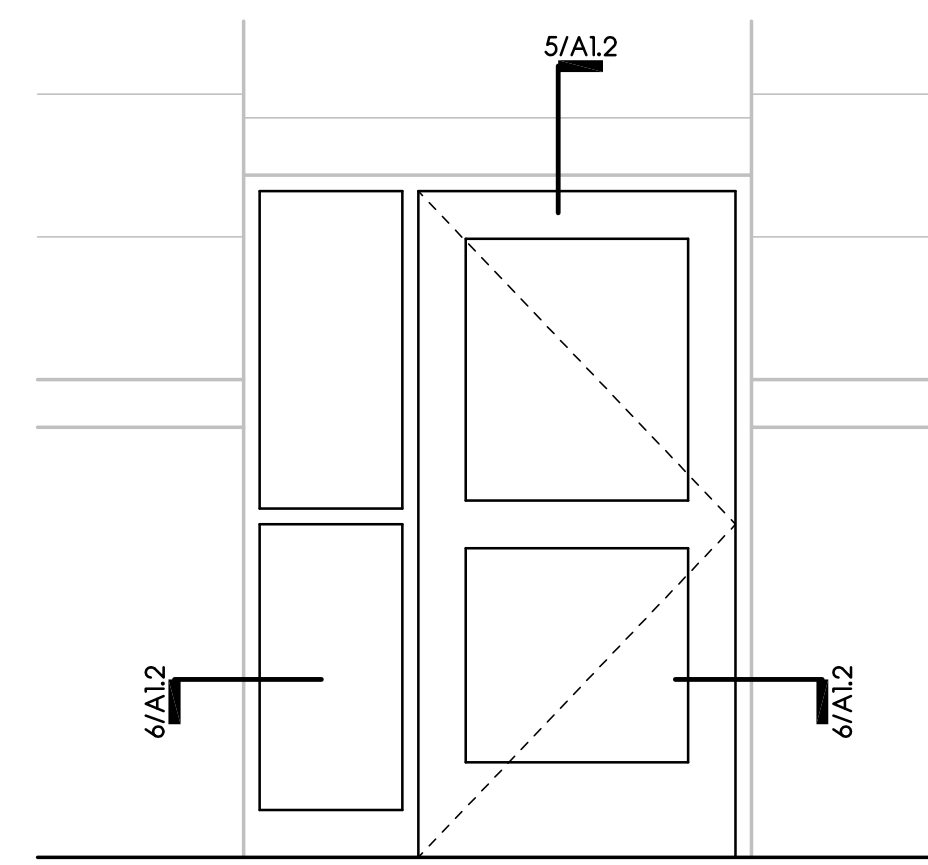

**2 DOOR A ELEVATION**  
SCALE: 1/2" = 1'-0"

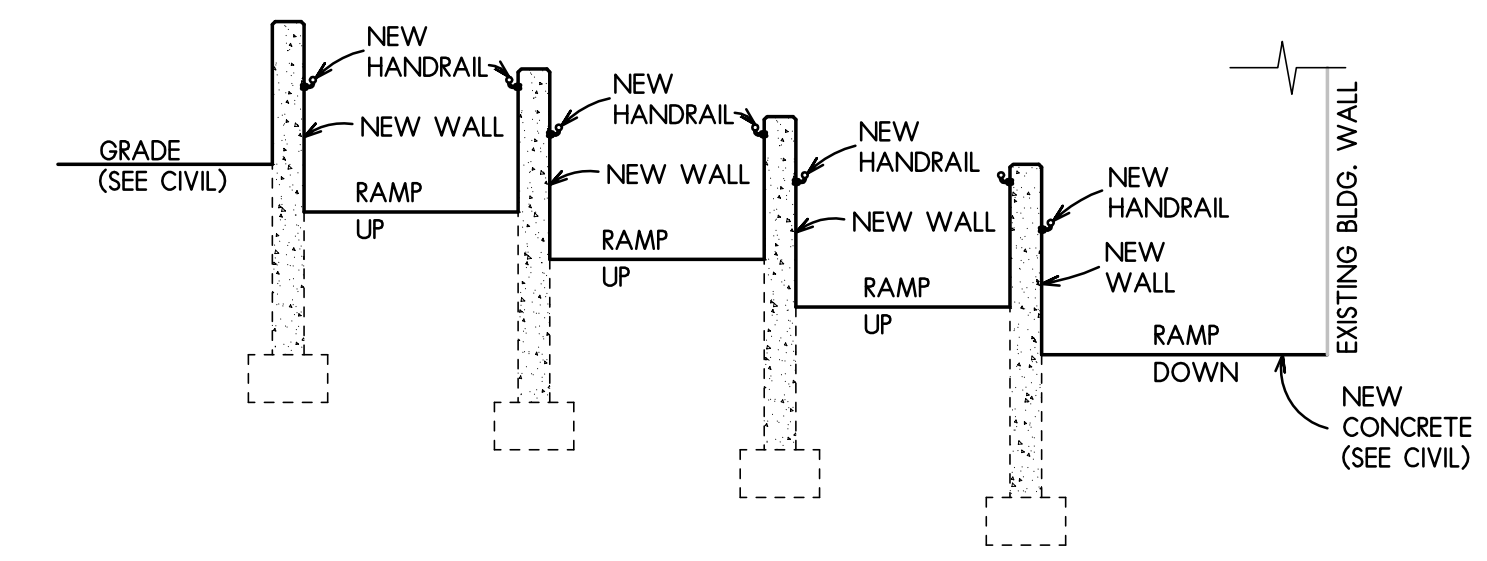


**3 RAMP SECTION**  
SCALE: 1/4" = 1'-0"

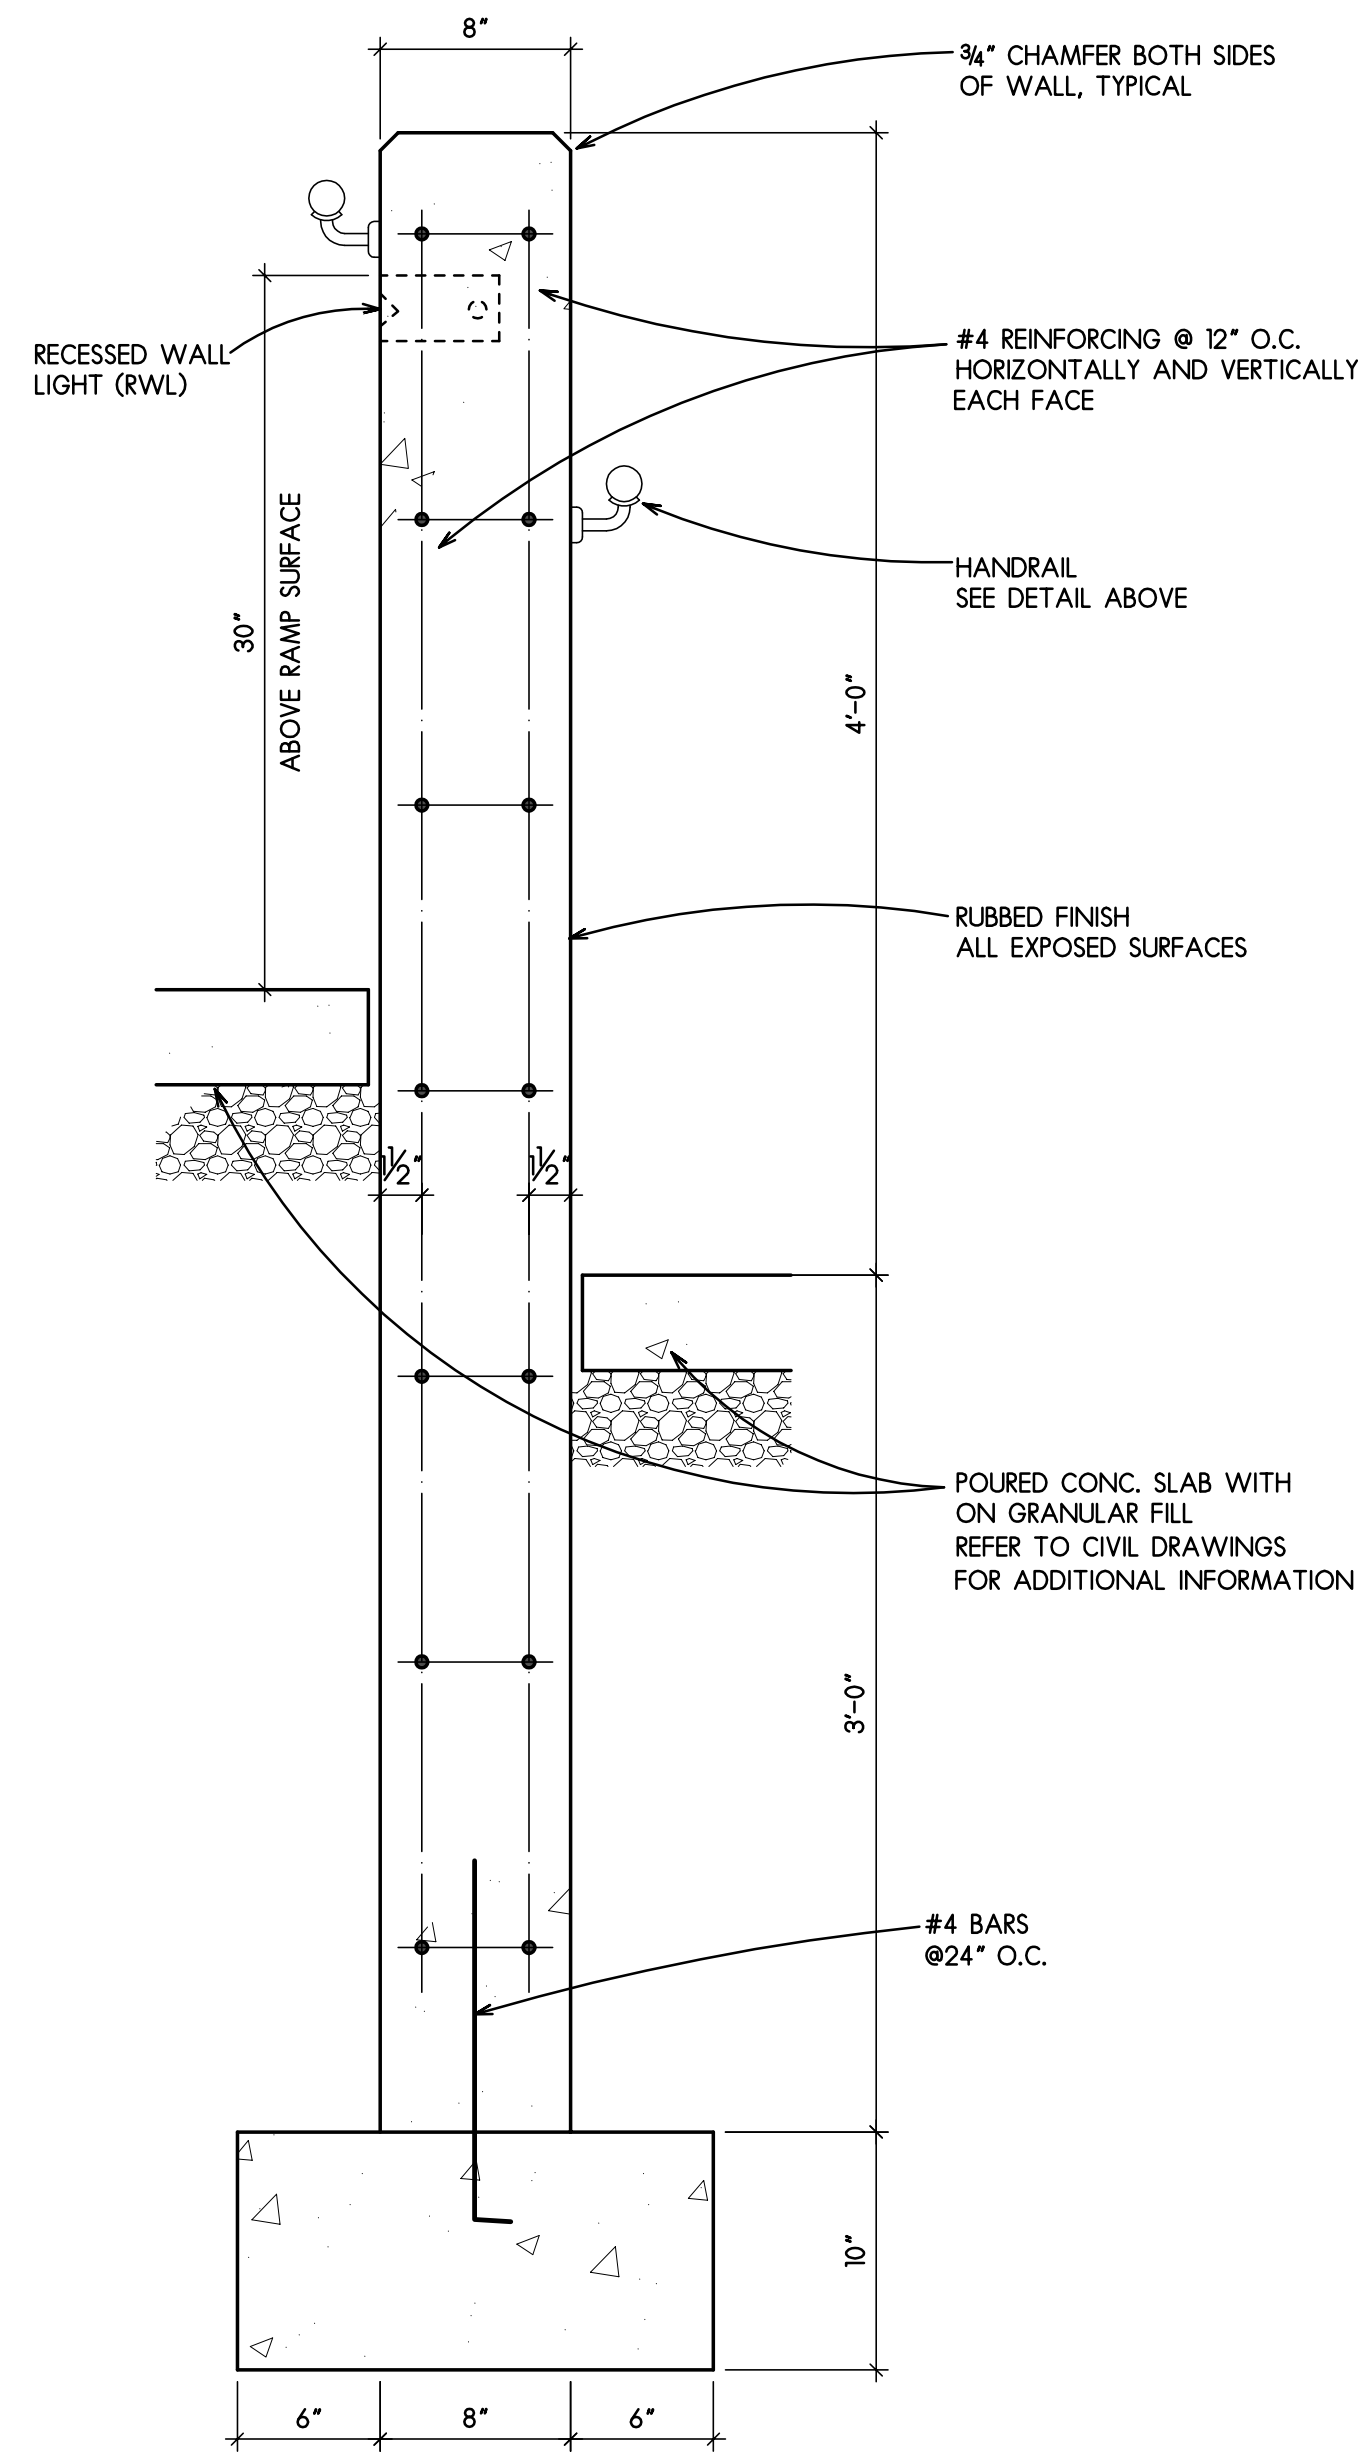


**4 TYP. RAMP WALL**  
SCALE: 1/2" = 1'-0"


RWL = RECESSED LED WALL LIGHT (4000K)  
MODEL NO. 33 055 BY BEGA LIGHTING  
CARPINTERIA, CA  
CONNECT THESE FIXTURES TO EXIST.  
EXTERIOR LIGHTING CIRCUIT & CONTROLS  
ALTERNATE #1

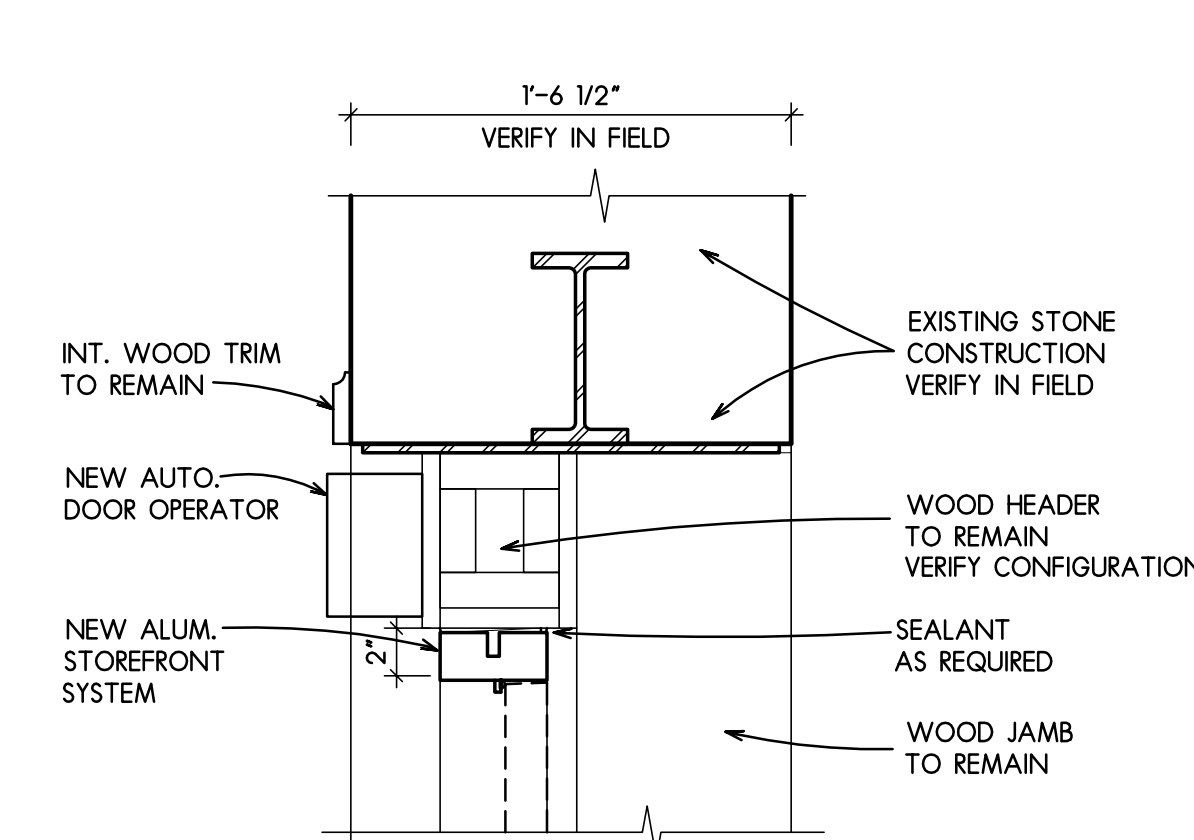

**5 H1 HEAD DETAIL**  
SCALE: 1 1/2" = 1'-0"

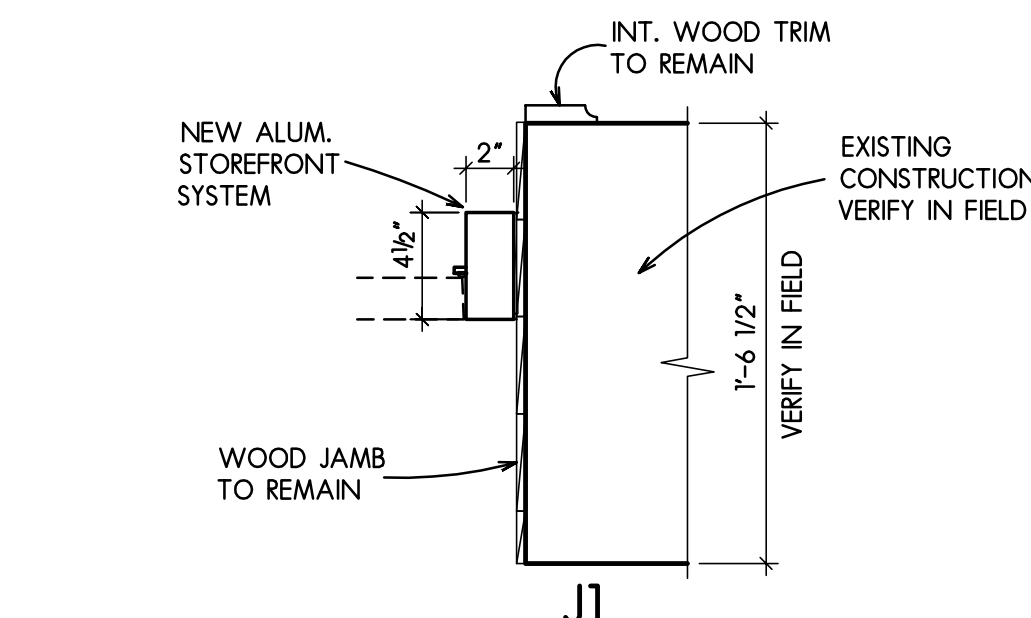


**6 JAMB DETAIL**  
SCALE: 1 1/2" = 1'-0"

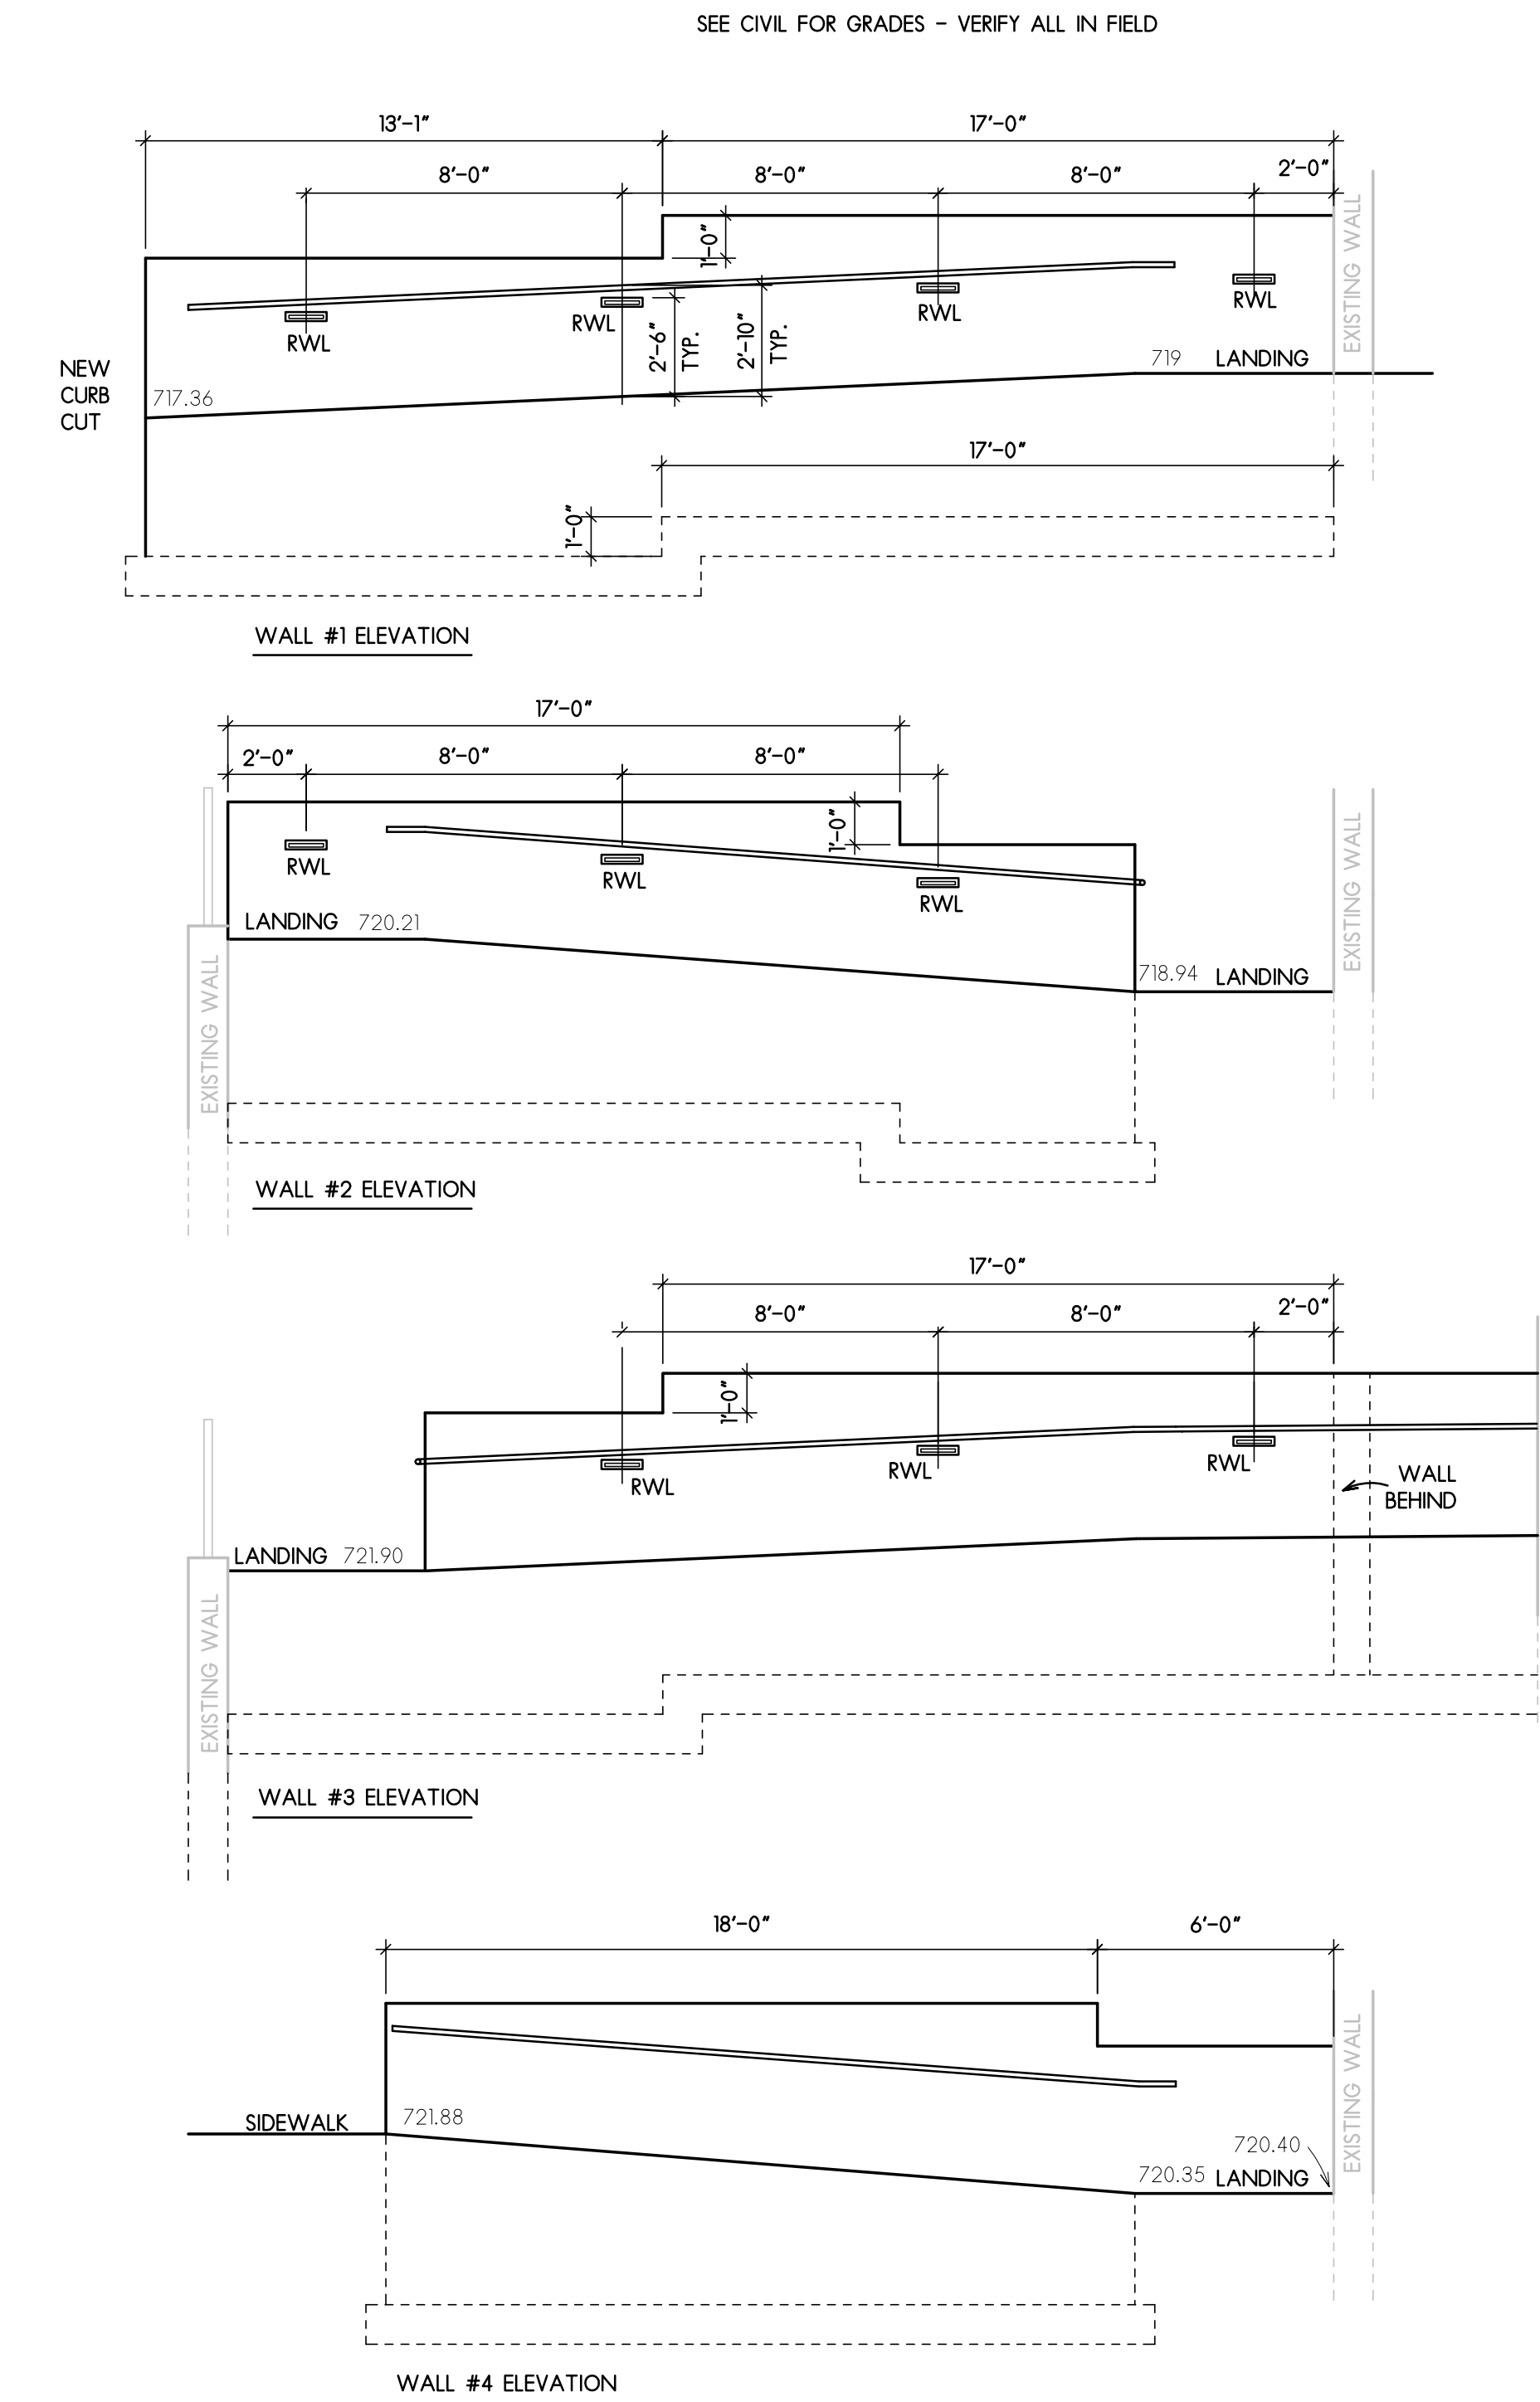

**7 RAMP WALL ELEVATIONS**  
SCALE: 1/4" = 1'-0"

RWL = RECESSED LED WALL LIGHT (4000K)  
MODEL NO. 33 055 BY BEGA LIGHTING  
CARPINTERIA, CA  
CONNECT THESE FIXTURES TO EXIST.  
EXTERIOR LIGHTING CIRCUIT & CONTROLS  
ALTERNATE #1

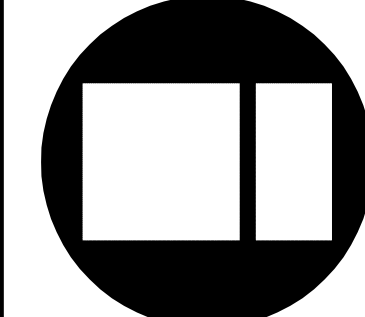

PROGRESS PRINT  
Not For Construction  
Date: 06-16-2021  
LARSON & DARBY GROUP  
architecture-engineering-interiors

ACCESS AND ACCESSIBILITY UPGRADES FOR:  
**VETERANS MEMORIAL HALL**  
ROCKFORD, ILLINOIS

COPYRIGHT 2021  
All drawn and written information appearing herein shall not be duplicated, disclosed, or otherwise used without the written consent of Larson & Darby Group

ISSUED FOR:	DATE
DRAWN	_____
APPROVED	_____

DATE: 6-16-2021	PROJECT NUMBER: 30271
SHEET NUMBER: A1.2	